



We Ship Anything, Anywhere, Anytime!

## EDINBURGH, INDIANA

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LIVONIA, MI 48154

MECHANICAL/ELECTRIAL ENGINEERS:  
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### REFERENCE NOTES

[03-1]	CONCRETE PAVEMENT - 8" CONCRETE SLAB WITH 6' x 6' W2.9' x W2.9' W.W.F. ON 8" MINIMUM COMPACTED GRANULAR FILL - SEE STRUCTURAL DRAWINGS AND SOILS REPORT.	[07-12]	METAL GUTTER AND DOWNSPOUT - PRE-FINISHED GALVANIZED METAL GUTTER AND DOWNSPOUT, SLOPE GUTTER TO DOWNSPOUT (MINIMUM 1/8" PER 12')
[03-2]	CONCRETE PAVEMENT - 8" CONCRETE SLAB WITH 6' x 6' W2.9' x W2.9' W.W.F. ON 8" MINIMUM COMPACTED GRANULAR FILL - SEE STRUCTURAL DRAWINGS AND SOILS REPORT.	[07-15]	EIPS - EXTERIOR INSULATION FINISH SYSTEM ON RIGID INSULATION ON DENS GLASS GOLD EXTERIOR GYPSUM BOARD SHEATHING ON EXTERIOR STRUCTURAL METAL STUDS AT 16" O.C., PROVIDE IMPACT RESISTANT SYSTEM FROM GRADE TO 1'-0" ABOVE FINISH FLOOR.
[03-4]	CONCRETE SLAB - 8" CONCRETE SLAB WITH 6' x 6' W1.4' x W1.4' W.W.F. ON PLASTIC VAPOR BARRIER ON 6" MINIMUM COMPACTED GRANULAR FILL - CURE AND SEAL PER SPECIFICATIONS - SEE STRUCTURAL DRAWINGS AND SOILS REPORT.	[07-16]	SNOW GUARDS - POLYCARBONATE POLYMER SNOW GUARDS ATTACHED TO METAL ROOF PANELS WITH ADHESIVE TAPE, PROVIDE MANUFACTURERS RECOMMENDED AND REQUIRED AND SEALANT - VERIFY QUANTITY OF ROWS AND SPACING OF SNOW GUARDS WITH MANUFACTURER. SEE SPECIFICATIONS
[03-6]	CONCRETE SLAB - 6" CONCRETE SLAB WITH 6' x 6' W2.9' x W2.9' W.W.F. ON PLASTIC VAPOR BARRIER ON 6" MINIMUM COMPACTED GRANULAR FILL - CURE AND SEAL PER SPECIFICATIONS - SEE STRUCTURAL DRAWINGS AND SOILS REPORT.	[07-19]	METAL PANEL - PRE-FINISHED METAL SIDING PANEL ON STEEL GIRTS ON STEEL FRAMING BY PEMB CONTRACTOR WITH VINYL FACED BATT INSULATION MINIMUM R-11, MAXIMUM ASSEMBLY U = 0.123 VALUE. - SEE PRE-ENGINEERED METAL BUILDING (PEMB) PLANS.
[03-7]	CONCRETE SLAB - 8" CONCRETE SLAB WITH 6' x 6' W2.9' W.W.M. ON PLASTIC VAPOR BARRIER ON 6" MINIMUM COMPACTED GRANULAR FILL - CURE AND SEAL PER SPECIFICATIONS - SEE STRUCTURAL DRAWINGS AND SOILS REPORT.	[07-20]	METAL PANEL - PRE-FINISHED METAL SIDING PANEL ON STEEL GIRTS ON STEEL FRAMING BY PEMB CONTRACTOR WITH VINYL FACED BATT INSULATION MINIMUM R-13, MAXIMUM ASSEMBLY U = 0.113 VALUE. - SEE PRE-ENGINEERED METAL BUILDING (PEMB) PLANS.
[03-14]	1/2" EXPANSION JOINT - 1/2" EXPANSION JOINT MATERIAL HOLD DOWN 1" AND FILL WITH SEALANT.	[08-1]	METAL DOOR AND FRAME - INSULATED HOLLOW METAL DOOR AND FRAME (PAINT).
[04-2]	BLOCK MASONRY - 8" SMOOTH FACE BLOCK MASONRY (PAINT) WITH HORIZONTAL METAL REINFORCING AT 16" O.C. - SEE STRUCTURAL DRAWINGS FOR INFORMATION ON VERTICAL REINFORCING.	[08-2]	METAL DOOR AND FRAME - HOLLOW METAL DOOR AND FRAME (PAINT).
[04-6]	SMOOTH FACE BLOCK MASONRY - 8" SMOOTH FACE INTERNALLY COLORED BLOCK MASONRY WITH INTEGRAL SEALER. SEE STRUCTURAL DRAWINGS FOR INFORMATION ON VERTICAL REINFORCING.	[08-3]	GLASS IN ALUMINUM FRAME - 1" INSULATING TINTED GLASS IN 2" x 4-1/2" PRE-FINISHED DARK BRONZE ANODIZED ALUMINUM FRAME. TEMPERED FLOAT GLASS REQUIRED WITHIN 2'-0" OF ALL DOORS AND 1'-6" FROM WALKING SURFACES.
[04-7]	SMOOTH FACE BLOCK MASONRY - 12" INTERNALLY COLORED SMOOTH FACE BLOCK MASONRY WITH INTEGRAL SEALER WITH HORIZONTAL METAL REINFORCING AT 16" O.C. WITH FOAM-IN-PLACE INSULATION. SEE STRUCTURAL DRAWINGS FOR INFORMATION ON VERTICAL REINFORCING.	[08-4]	GLASS IN HOLLOW METAL FRAME - 1/4" CLEAR GLASS IN HOLLOW METAL FRAME (PAINT, VERIFY COLOR WITH OWNER)
[04-8]	SMOOTH FACE BLOCK MASONRY - 8" INTERNALLY COLORED SMOOTH FACE BLOCK MASONRY WITH INTEGRAL SEALER WITH HORIZONTAL METAL REINFORCING AT 16" O.C. WITH FOAM-IN-PLACE INSULATION. SEE STRUCTURAL DRAWINGS FOR INFORMATION ON VERTICAL REINFORCING.	[08-5]	SPANDREL GLASS IN ALUMINUM FRAME - 1" INSULATING SPANDREL GLASS IN 2" x 4-1/2" PRE-FINISHED DARK BRONZE ANODIZED ALUMINUM FRAME. TEMPERED FLOAT GLASS REQUIRED WITHIN 2'-0" OF ALL DOORS AND 1'-6" FROM WALKING SURFACES.
[05-1]	STEEL BOLLARD - 6" DIAMETER CONCRETE FILLED SCHEDULE 40 STEEL PIPE (PAINT). FOR INTERIOR INSTALLATIONS ONLY. SEE DETAIL 3 ON SHEET A1.1.	[08-6]	GLASS IN HOLLOW METAL FRAME - 1" CLEAR INSULATING GLASS IN FLOW METAL FRAME (PAINT, VERIFY COLOR WITH OWNER)
[05-2]	STEEL BOLLARD - 8" DIAMETER CONCRETE FILLED STEEL SCHEDULE 40 PIPE (PAINT). FOR EXTERIOR INSTALLATIONS ONLY. SEE DETAIL 4 ON SHEET A1.1.	[08-7]	ALUMINUM AND GLASS DOOR - 1" INSULATING TINTED GLASS IN PRE-FINISHED DARK BRONZE ANODIZED ALUMINUM FRAME DOOR.
[05-3]	STEEL BOLLARD - 8" DIAMETER CONCRETE FILLED SCHEDULE 40 STEEL PIPE (PAINT) INSTALL WITH TOP 7'-0" ABOVE FINISHED GRADE. FOR EXTERIOR INSTALLATIONS ONLY. SEE DETAIL 4 ON SHEET A1.1 FOR SIMILAR CONDITION.	[08-8]	GLASS IN ALUMINUM FRAME - 1/4" CLEAR GLASS IN 2" x 4-1/2" PRE-FINISHED DARK BRONZE ANODIZED ALUMINUM FRAME. TEMPERED FLOAT GLASS REQUIRED WITHIN 2'-0" OF ALL DOORS AND 1'-6" FROM WALKING SURFACES.
[07-3]	SINGLE PLY ROOFING - FULLY-ADHERED SINGLE-PLY ROOF MEMBRANE ON RIGID INSULATION R-15 MINIMUM ON PRECAST CONCRETE PLANK MEMBERS.	[08-12]	METAL ROLLING DOOR - 9'-0" X 9'-0" INSULATED PRE-FINISHED CHAIN OPERATED METAL ROLLING OVERHEAD DOOR IN STEEL FRAME. SEE PRE-ENGINEERED METAL BUILDING (PEMB) PLANS.
[07-6]	METAL ROOFING - PRE-FINISHED STANDING SEAM METAL ROOFING ON STEEL FURLINS AND STEEL FRAMING BY PEMB CONTRACTOR WITH VINYL FACED BATT INSULATION R VALUE TO BE MINIMUM R-10, MAXIMUM ASSEMBLY U = 0.097. SEE PRE-ENGINEERED METAL BUILDING (PEMB) PLANS.	[08-13]	METAL ROLLING DOOR - 9'-0" X 10'-0" INSULATED PRE-FINISHED CHAIN OPERATED METAL ROLLING OVERHEAD DOOR WITH VISION SLATS IN STEEL FRAME. SEE PRE-ENGINEERED METAL BUILDING (PEMB) PLANS.
[07-7]	METAL ROOFING - PRE-FINISHED STANDING SEAM METAL ROOFING ON STEEL FURLINS AND STEEL BY PEMB CONTRACTOR FRAMING WITH BATT INSULATION MINIMUM R VALUE TO BE R-19, MAXIMUM ASSEMBLY U = 0.065 VALUE. SEE PRE-ENGINEERED METAL BUILDING (PEMB) PLANS.	[08-14]	METAL ROLLING DOOR - 12'-0" W. X 12'-0" H. INSULATED PRE-FINISHED MOTOR OPERATED METAL ROLLING OVERHEAD DOOR WITH VISION SLATS IN STEEL FRAME. SEE PRE-ENGINEERED METAL BUILDING (PEMB) PLANS.
[07-8]	METAL COPING - GALVANIZED METAL COPING (PRE-FINISHED CUSTOM COLORS PER FINISH SCHEDULES) SECURE WITH CONTINUOUS CLEAT AT EXTERIOR SIDE (SEE SPECIFICATIONS). PROVIDE STANDING SEAM AT JOINTS AS REQUIRED. SEE DETAIL 5 ON A5.6 FOR REFERENCE.	[08-15]	METAL ROLLING DOOR - 9'-0" W. X 8'-8" H. INSULATED PRE-FINISHED CHAIN OPERATED METAL ROLLING OVERHEAD DOOR.
[07-9]	MEMBRANE FLASHING - MEMBRANE ROOFING FLASHING, RUN UP AND UNDER METAL COPING OR FLASHING. SECURE TO WALL PER MANUFACTURERS SPECIFICATIONS.	[08-16]	METAL ROLLING DOOR - 14'-0" W. X 12'-0" H. INSULATED PRE-FINISHED MOTOR OPERATED METAL ROLLING OVERHEAD DOOR WITH VISION SLATS.
[07-10]	TWO PIECE METAL FLASHING - TWO PIECE INTERLOCKING GALVANIZED METAL FLASHING (PAINT) EXTEND UP AND BEHIND EIFS.	[09-16]	GYPSUM BOARD CEILING - 5/8" GYPSUM BOARD CEILING (PAINT) ON METAL FURRING AT 16" O.C. ON METAL CHANNELS AT 4'-0" O.C. SUSPENDED FROM STRUCTURAL MEMBERS.
		[09-25]	GYPSUM BOARD CEILING - 5/8" GYPSUM BOARD (PAINT) ON 8" METAL JOISTS AT 16" O.C. AT SHOWER/TOILET ROOMS PROVIDE 5/8" MOISTURE RESISTANT GYPSUM BOARD.

### ABBREVIATIONS

ADJ. - ADJUSTABLE A.F.F. - ABOVE FINISH FLOOR AGG. - AGGREGATE ALT. - ALTERNATE ALUM. - ALUMINUM ANOD. - ANODIZED BD. - BOARD BLDG. - BUILDING B.O.S. - BOTTOM OF STEEL BOTT. - BOTTOM BRG. - BEARING BTWN. - BETWEEN CLG. - CEILING C.O. - CLEAN-OUT COL. - COLUMN CONC. - CONCRETE CONSTR. - CONSTRUCTION CONT. - CONTINUOUS CONTR. - CONTRACTOR C.J. - CONTROL JOINT CORR. - CORRIDOR CTSK. - COUNTERSUNK SCREW DET. - DETAIL DIM. - DIMENSION DR. - DOOR D.S. - DOWNSPOUT D.F. - DRINKING FOUNTAIN DWG. - DRAWING DWL. - DOWEL	E.G. - EXTERIOR GRADE EL. - ELEVATION ELEC. - ELECTRICAL E.J. - EXPANSION JOINT EWC. - ELECTRIC WATER COOLER ELEV. - ELEVATION EQ. - EQUAL EQUIP. - EQUIPMENT EX. - EXHAUST EXIST. - EXISTING EXPN. - EXPANSION FIN. - FINISH F.F. - FINISH FLOOR F.E. - FIRE EXTINGUISHER FR. - FRAME FRT. - FIRE-RETARDANT FLR. - FLOOR F.D. - FLOOR DRAIN FURN. - FURNISHED GA. - GAUGE GALV. - GALVANIZED GEN. - GENERAL GYF. - GYPSUM H.B. - HOSE BIBB HOW. - HARDWARE H.P. - HIGH POINT HVAC. - HEATING/VENTILATING/ AIR CONDITIONING HT. - HEIGHT H.W. - HOLLOW METAL HORIZ. - HORIZONTAL	I.D. - INSIDE DIAMETER INSUL. - INSULATION INT. - INTERIOR JT. - JOINT LAM. - LAMINATE LAV. - LAVATORY L.C. - LONG L.P. - LOW POINT MANUF. - MANUFACTURER MAS. - MASONRY M.O. - MASONRY OPENING MAT. - MATERIAL MAX. - MAXIMUM M.C.J. - MASONRY CONTROL JOINT MECH. - MECHANICAL MET. - METAL M.I.C. - MISCELLANEOUS M.D. - MOUNTED MIN. - MINIMUM M.I.C. - NOT IN CONTRACT N.T.S. - NOT TO SCALE O.C. - ON CENTER O.H. - OPPOSITE HAND OPNG. - OPENING OPP. - OPPOSITE O.D. - OUTSIDE DIAMETER PL. - PLATE PR. - PAIR	PREFAB - PREFABRICATED PREFIN. - PRE-FINISHED RAD. - RADIUS REINF. - REINFORCE RM. - ROOM R.O. - ROUGH OPENING R.S. - ROOF SUMP SHT. - SHEET SIM. - SIMILAR SPEC. - SPECIFICATION SQ. - SQUARE STL. - STEEL STRUCT. - STRUCTURAL SUSP. - SUSPENDED SYM. - SYMMETRICAL SYN. - SYNTHETIC SYS. - SYSTEM THK. - THICKNESS T & G - TONGUE & GROOVE T.O.P. - TOP OF PARAPET T.O.S. - TOP OF STEEL (UNDERLIES METAL DECK) TYP. - TYPICAL N.I.C. - NOT IN CONTRACT V.I.F. - VERIFY IN FIELD W. - WITH W.C. - WATER CLOSET W.D. - WIDE WD. - WOOD
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### SYMBOL LEGEND

<b>DETAIL TITLE</b> DETAIL IDENTIFICATION DRAWING WHERE DETAIL IS REFERENCED OR CUT <b>DETAIL CUT</b> DETAIL IDENTIFICATION DRAWING WHERE DETAIL IS DRAWN <b>COLUMN OR CENTERLINE</b> NEW EXISTING <b>ROOM NAME AND NUMBER</b> ROOM NO. FLOOR	<b>ELEVATION SYMBOL</b> ELEVATION IDENTIFICATION DRAWING WHERE ELEVATION IS DRAWN <b>BUILDING SECTION LOCATOR</b> BUILDING SECTION IDENTIFICATION DRAWING WHERE SECTION IS DRAWN <b>PLAN OR DETAIL ENLARGEMENT</b> PLAN OR DETAIL IDENTIFICATION DRAWING WHERE PLAN OR DETAIL IS LOCATED <b>DOOR NUMBER</b> DOOR NO. FLOOR
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### GENERAL NOTES

- THE CONTRACTOR SHALL VISIT THE SITE PRIOR TO SUBMITTING HIS PROPOSAL TO BECOME FAMILIAR WITH ALL EXISTING FIELD CONDITIONS, AND REPORT ANY DISCREPANCIES TO THE ARCHITECT.
- THE CONTRACTOR SHALL BE RESPONSIBLE FOR VERIFYING THE LOCATION OF ALL EXISTING UNDERGROUND AND OVERHEAD UTILITIES TO SAFEGUARD AGAINST THE INTERRUPTION OF SERVICES TO THE OWNER OR TENANTS.
- ALL WOOD MEMBERS, PLYWOOD, STUDS, BLOCKING, ETC. TO BE FIRE RETARDANT TREATED WITH U.L. LABEL - SEE SPECIFICATIONS.
- REFERENCE NOTE MAY CONTAIN MATERIALS AND PROCEDURES REQUIRED BY SEVERAL DIFFERENT SUBCONTRACTORS. IT IS THE GENERAL CONTRACTORS RESPONSIBILITY TO INSURE THE SUBCONTRACTORS INCLUDE WITHIN THEIR BID ALL THE NECESSARY MATERIALS AND PROCEDURES REQUIRED TO PROVIDE A COMPLETE PROJECT. THE DRAWINGS AND SPECIFICATIONS ARE COMPLEMENTARY. IF THERE IS A CONFLICT BETWEEN THE DRAWINGS AND SPECIFICATIONS OR THE SPECIFICATIONS OMMITS A MATERIAL INDICATED ON THE DRAWINGS, IT IS THE GENERAL CONTRACTORS RESPONSIBILITY TO OBTAIN AN INTERPRETATION FROM THE ARCHITECT DURING BIDDING.
- PROHIBITED SUBSTITUTION OF MATERIALS FROM METAL OR WOOD DECK. SUSPENSION OF ANY MATERIAL OR EQUIPMENT FROM METAL OR WOOD DECK IS STRICTLY PROHIBITED. ITEMS NOT ALLOWED TO BE ATTACHED TO OR SUSPENDED FROM THE METAL OR WOOD DECK INCLUDE BUT ARE NOT LIMITED TO MECHANICAL OR ELECTRICAL EQUIPMENT, DUCTS, PIPES, LIGHT FIXTURES, OR OTHER DECORATIVE STRUCTURES.
- PROVIDE PORTABLE FIRE EXTINGUISHERS DURING CONSTRUCTION IN ACCORDANCE OF LOCAL AUTHORITIES.
- DEFERRED SUBMITTAL ITEMS:  
THE FOLLOWING SUBMITTAL ITEMS SHALL NOT BE INSTALLED UNTIL THEIR DESIGN AND SUBMITTAL DOCUMENTS HAVE BEEN APPROVED BY THE BUILDING OFFICIALS.
  - FIRE SUPPRESSION DRAWINGS.
  - PRE-ENGINEERED METAL BUILDING STRUCTURAL STEEL SHOP DRAWINGS.
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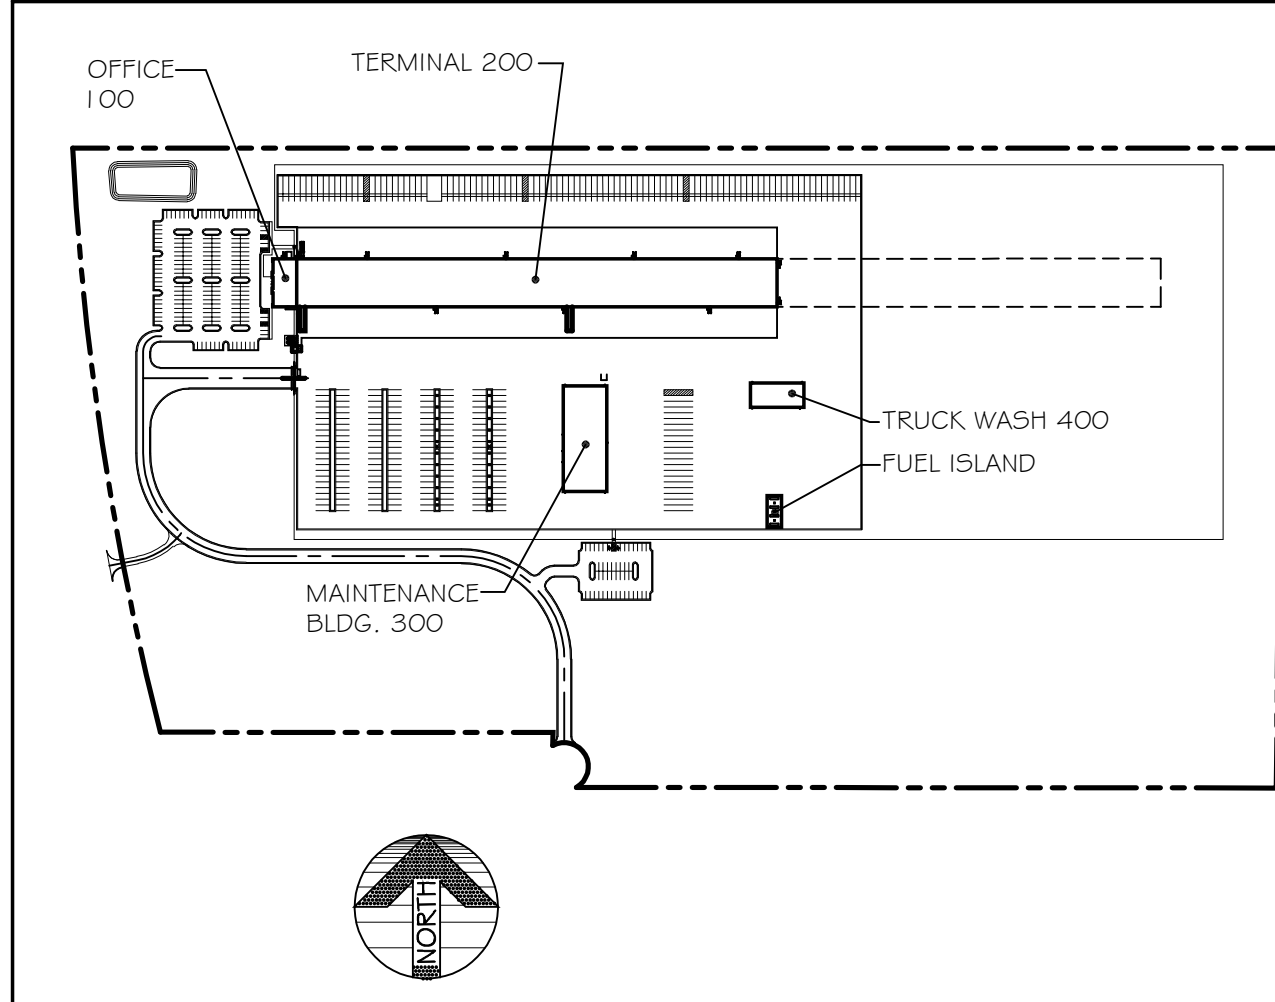
#### MAINTENANCE BUILDING

REQUIRED WOMEN'S RESTROOM	- WATERCLOSETS = 1 LAVATORIES = 1	PROVIDED WOMEN'S RESTROOM	- WATERCLOSETS = 1 LAVATORIES = 1
MEN'S ROOM	- WATERCLOSETS = 1 LAVATORIES = 1	MEN'S ROOM	- WATERCLOSETS = 2 URINALS = 2 LAVATORIES = 2
DRINKING FOUNTAINS	= 1	DRINKING FOUNTAINS	= 4 (2) ADA HI-LO
SERVICE SINK	= 1	SERVICE SINK	= 3
		COMBO EYE WASH/SHOWER	= 2


#### 4. EGRESS:

REQUIRED EXIT WIDTH (DOORS) = (51 OCCUPYS. X 0.20) = 11 INCHES
PROVIDED EXIT WIDTH (DOORS) = 64 INCHES
REQUIRED EXIT WIDTH (STAIRS) = (55 OCCUPYS. X 0.30) = 16.5 INCHES
PROVIDED EXIT WIDTH (STAIRS) = 48 INCHES
TERMINAL 200
REQUIRED EXIT WIDTH (DOORS) = (200 OCCUPYS. X 0.20) = 40 INCHES
PROVIDED EXIT WIDTH (DOORS) = 352 INCHES
REQUIRED EXIT WIDTH (STAIRS) = (200 OCCUPYS. X 0.30) = 60 INCHES
PROVIDED EXIT WIDTH (STAIRS) = 528 INCHES
MAINTENANCE BUILDING 300
REQUIRED EXIT WIDTH (DOORS) = (110 OCCUPYS. X 0.20) = 22 INCHES
PROVIDED EXIT WIDTH (DOORS) = 256 INCHES
TRUCK WASH BUILDING 400
REQUIRED EXIT WIDTH (DOORS) = (57 OCCUPYS. X 0.20) = 12 INCHES
PROVIDED EXIT WIDTH (DOORS) = 128 INCHES

### KEY PLAN



### VICINITY MAP

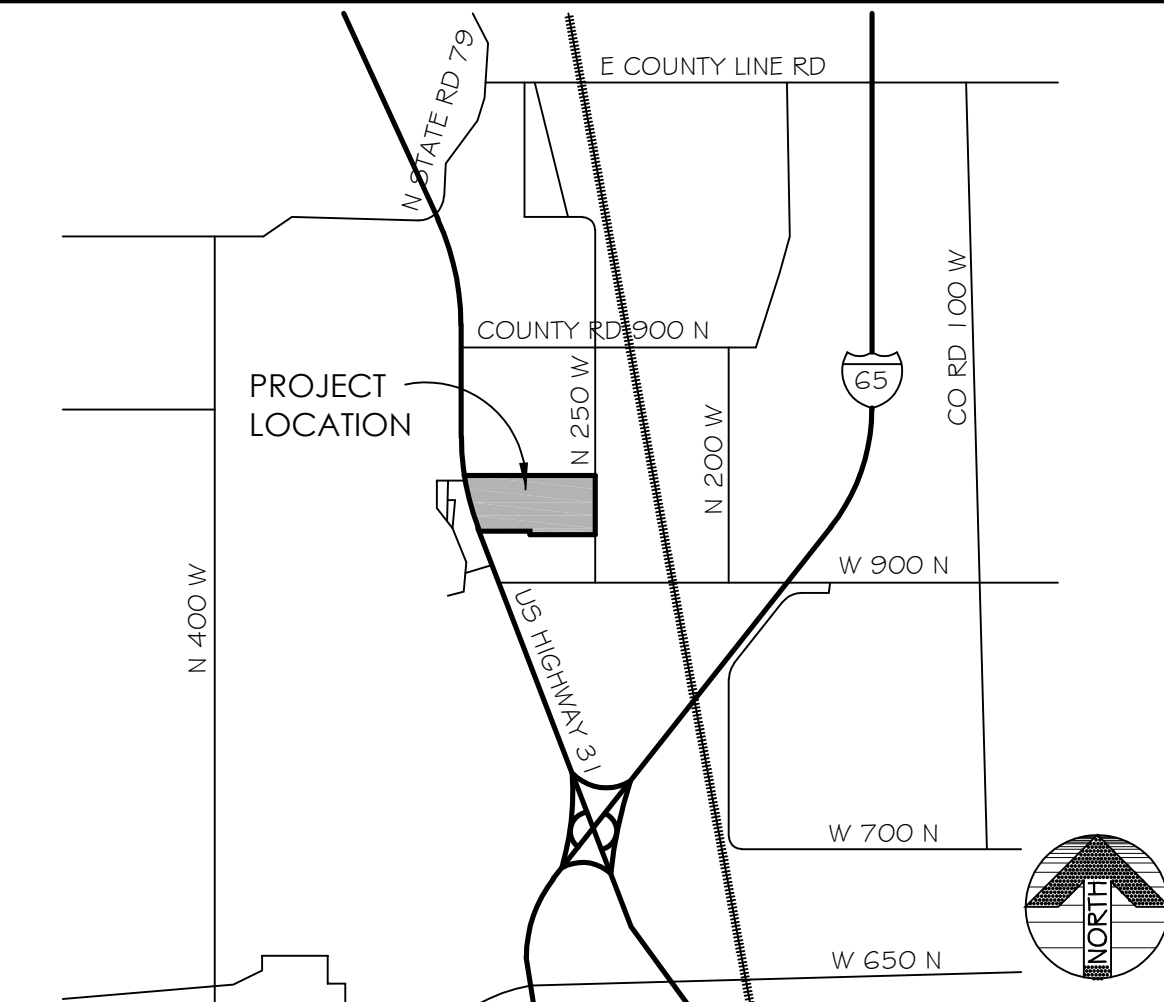

Wah Yee Associates  
Architects & Planners  
42400 GRAND RIVER AVENUE SUITE 200  
NOVI, MICHIGAN 48375  
PHONE 248.489.9160

PROJECT  
**R + L CARRIERS**  
EDINBURGH, INDIANA

Date Issued

Bids & Permit Oct. 8, 2021

Job Number

5147

SHEET TITLE  
TITLE SHEET

Sheet Number


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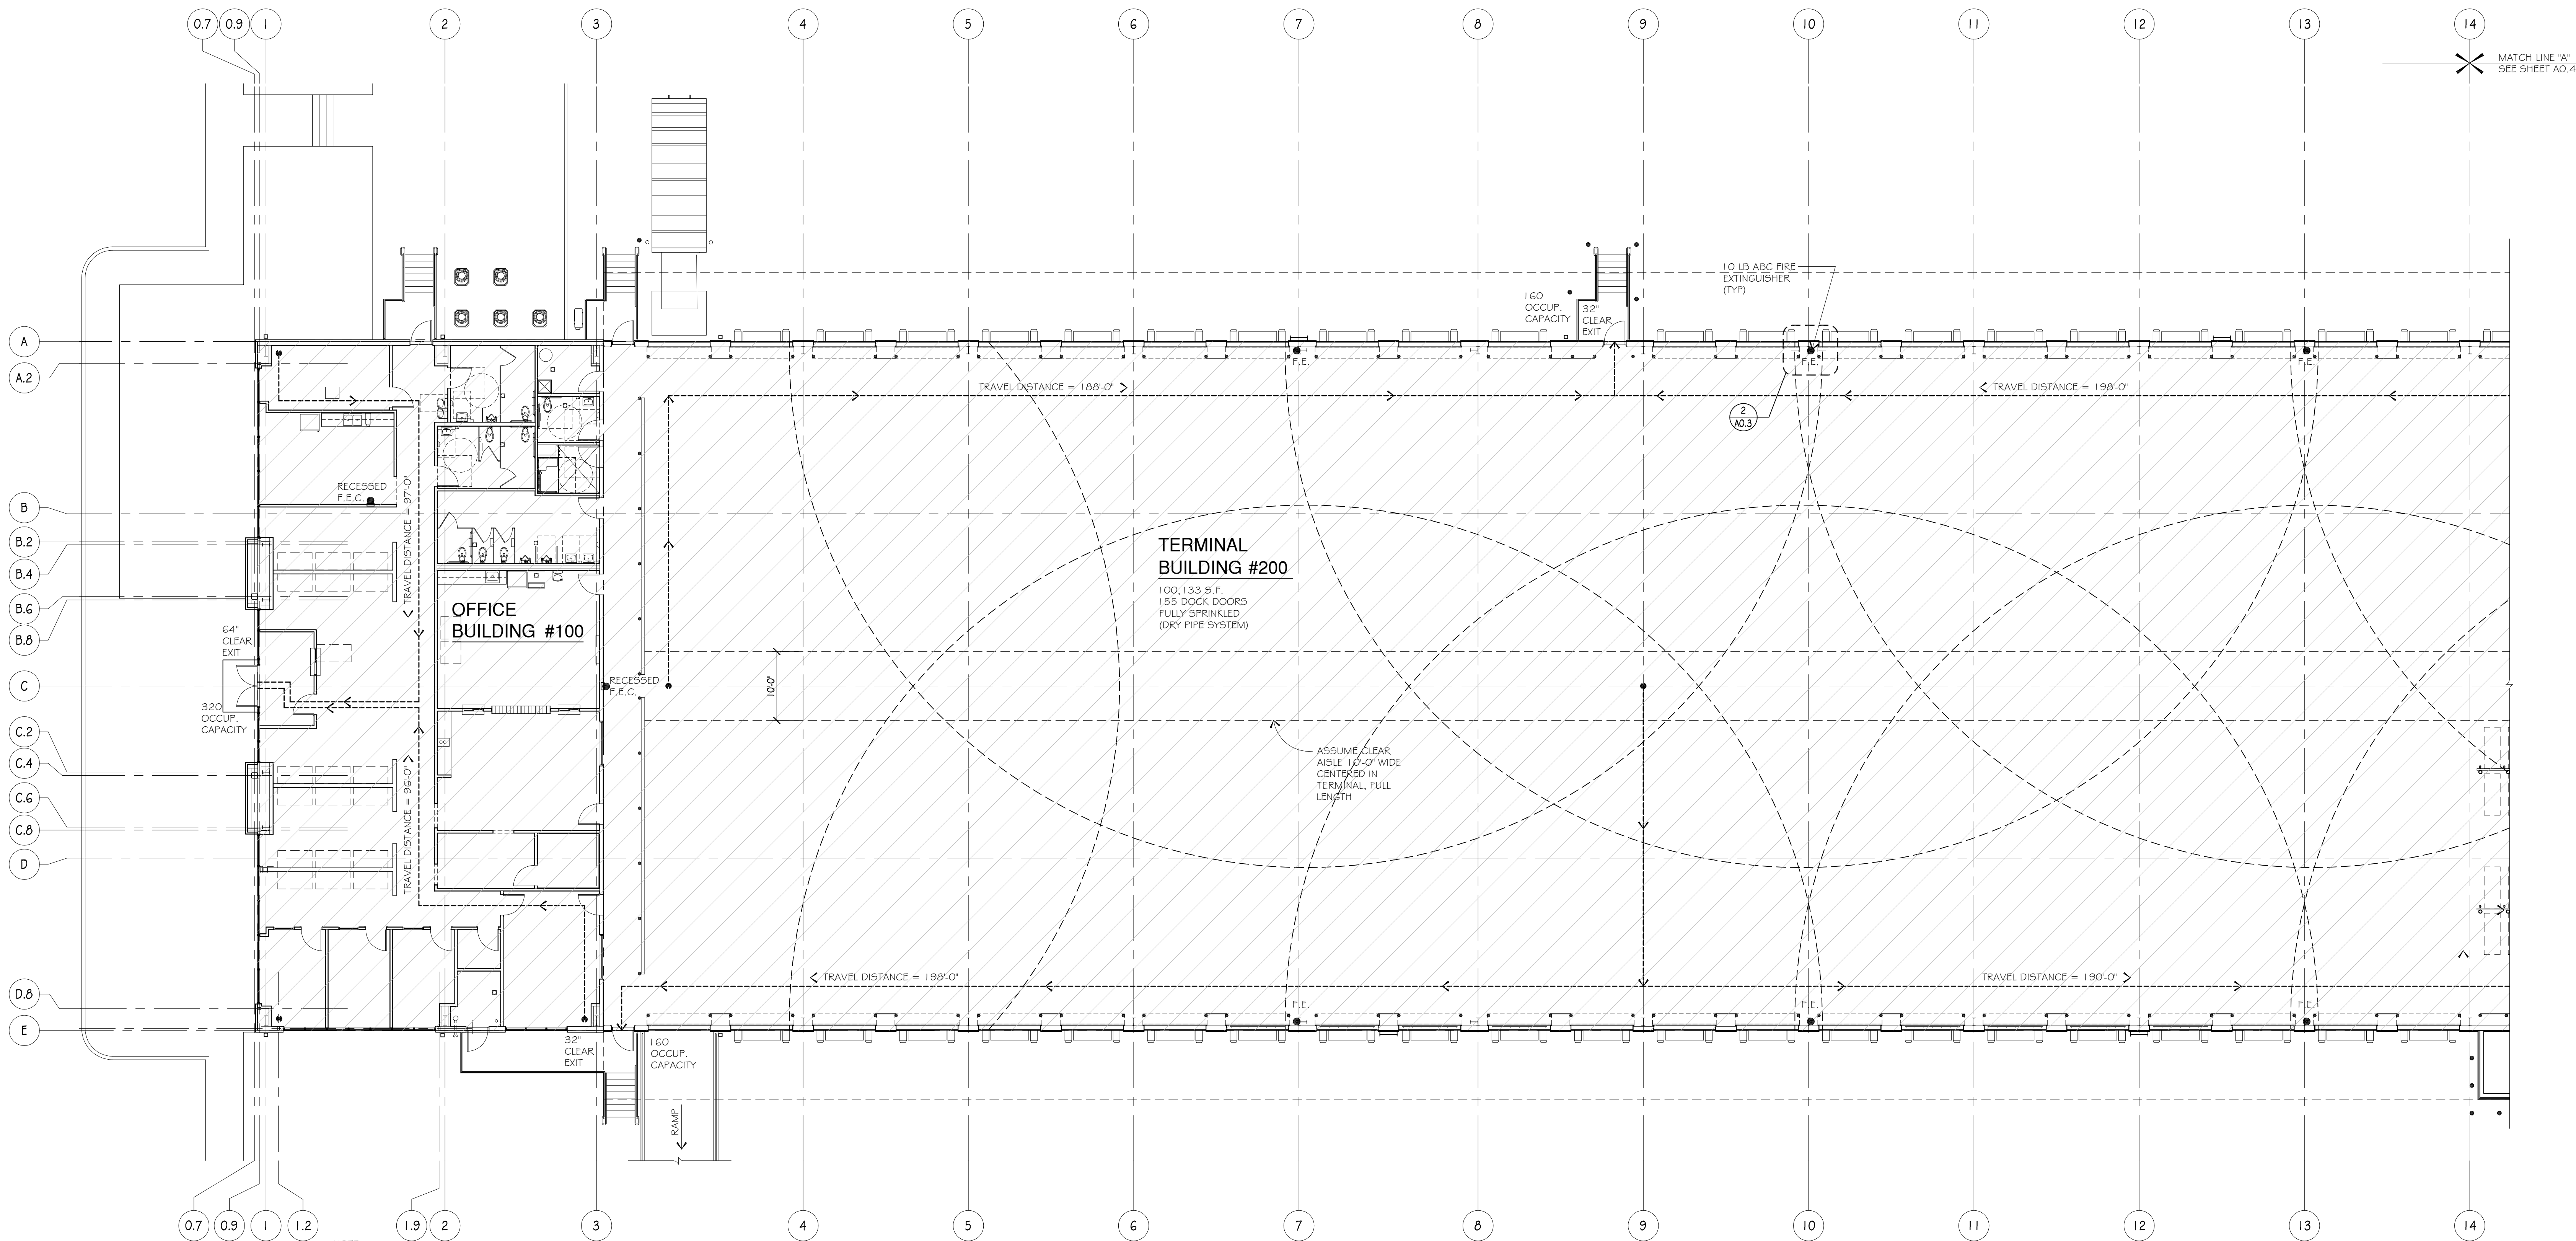
**BARRIER FREE REQUIREMENTS**

THE FOLLOWING IS NOT A COMPLETE LIST OF ALL THE BARRIER FREE REQUIREMENTS. THIS DOES NOT RELIEVE THE CONTRACTOR OF ANY ADDITIONAL BARRIER FREE REQUIREMENTS AS SPECIFIED BY THE CONSTRUCTION DOCUMENTS OR THE LOCAL BUILDING AUTHORITIES.

CONVENTION	DESCRIPTION
	DIMENSION SHOWING IN INCHES UNLESS OTHERWISE SPECIFIED
	DIMENSION SHOWING A RANGE WITH MINIMUM - MAXIMUM
	MINIMUM
	MAXIMUM
	GREATER THAN
	GREATER THAN OR EQUAL TO
	BOUNDARY OF CLEAR FLOOR SPACE OR MANEUVERING CLEARANCE
	LESS THAN
	LESS THAN OR EQUAL TO
	PERMITTED ELEMENT OR ITS EXTENSION
	DIRECTION OF TRAVEL OR APPROACH
	A WALL, FLOOR, CEILING OR OTHER ELEMENT CUT IN SECTION OR PLAN
	A HIGHLIGHTED ELEMENT IN ELEVATION OR PLAN
	LOCATION ZONE OF ELEMENT, CONTROL OR FEATURE







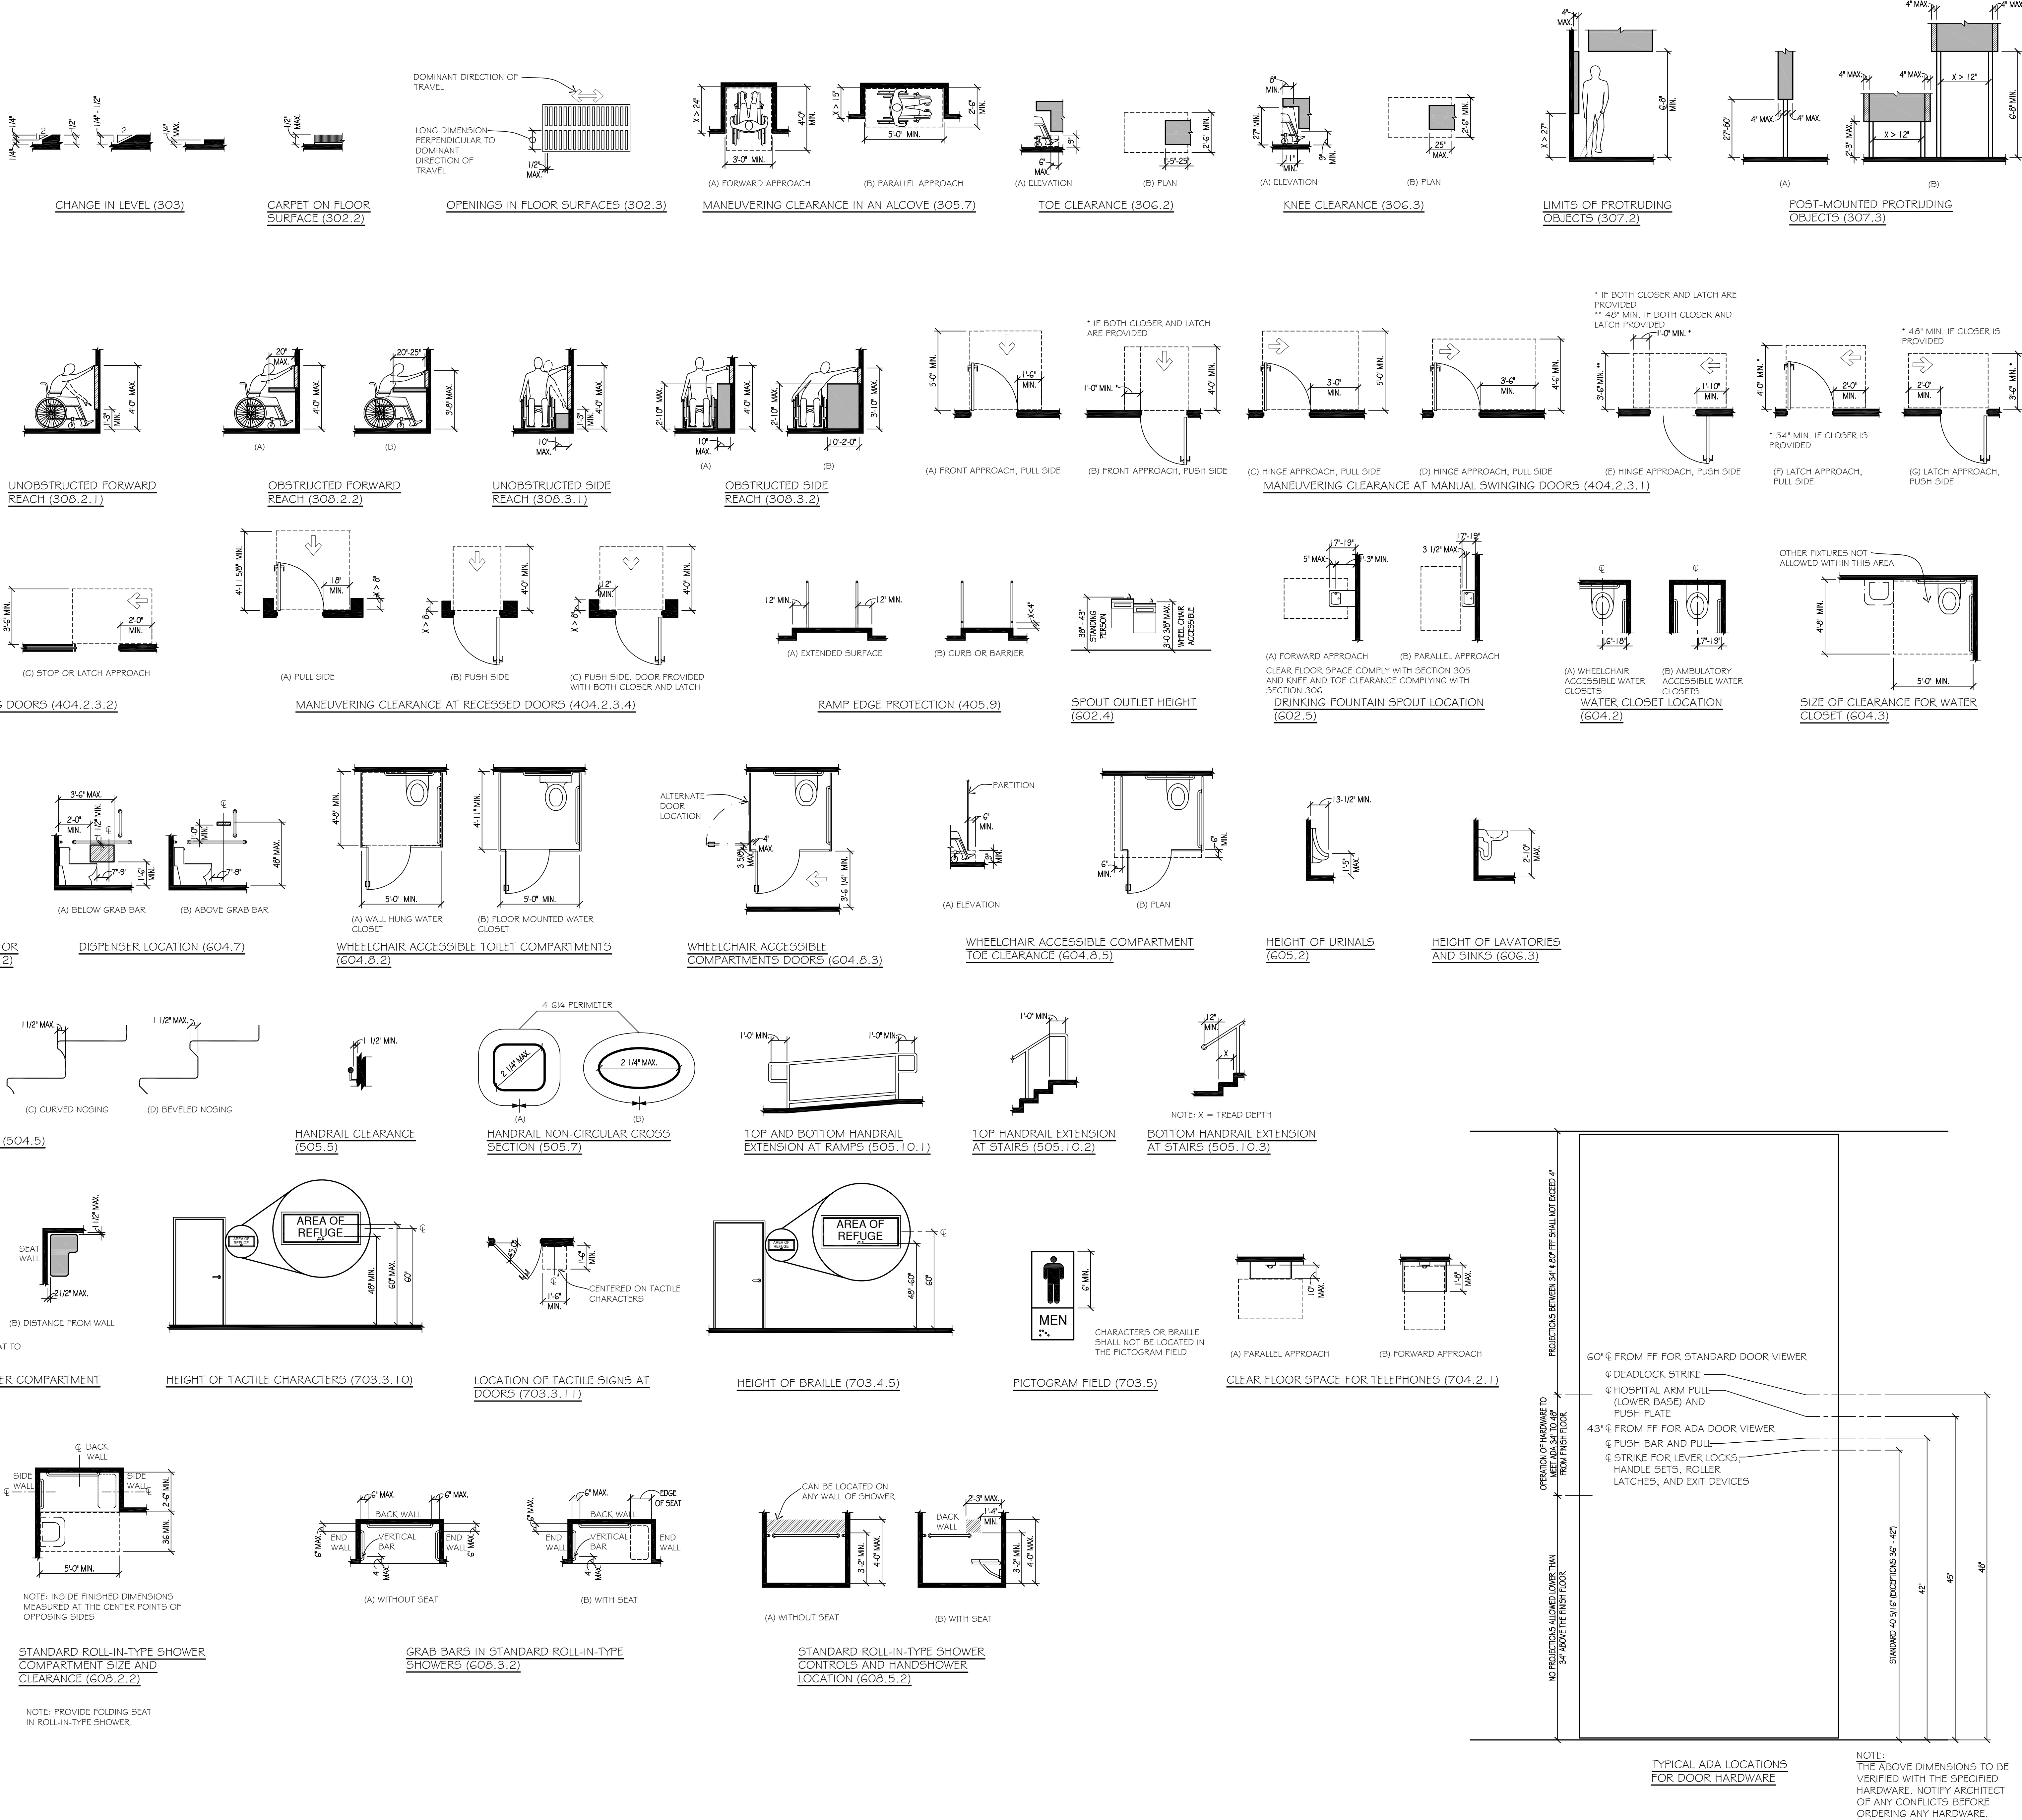

TERMINAL BUILDING #200 LIFE SAFETY PLAN


SCALE: 3/32" = 1'-0"

1  
A0.3

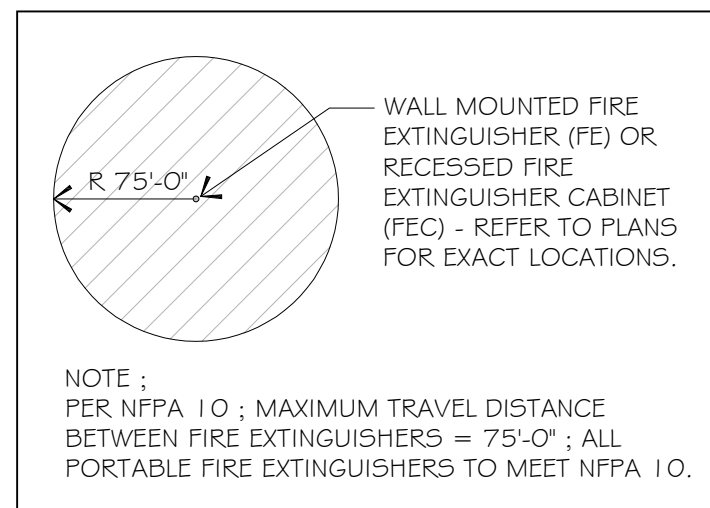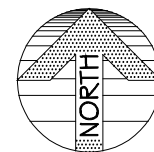



NOTE: GENERAL CONTRACTOR IS TO INSTALL OWNER FURNISHED FIRE EXTINGUISHERS THROUGHOUT TERMINAL BUILDING 200. COORDINATE WITH R.L. CARRIERS AND LOCAL FIRE MARSHALL FOR EXACT QUANTITY, TYPE AND LOCATIONS OF FIRE EXTINGUISHERS. R.L. CARRIERS STANDARDS IS ONE FIRE EXTINGUISHER EVERY THIRD COLUMN / 6 DOCK DOORS AND ON BOTH SIDES OF TERMINAL. GENERAL CONTRACTOR SHALL PROVIDE AND INSTALL FIRE EXTINGUISHER SIGNAGE AT ALL FIRE EXTINGUISHER LOCATIONS.

NOTE: F.E. = FIRE EXTINGUISHER.

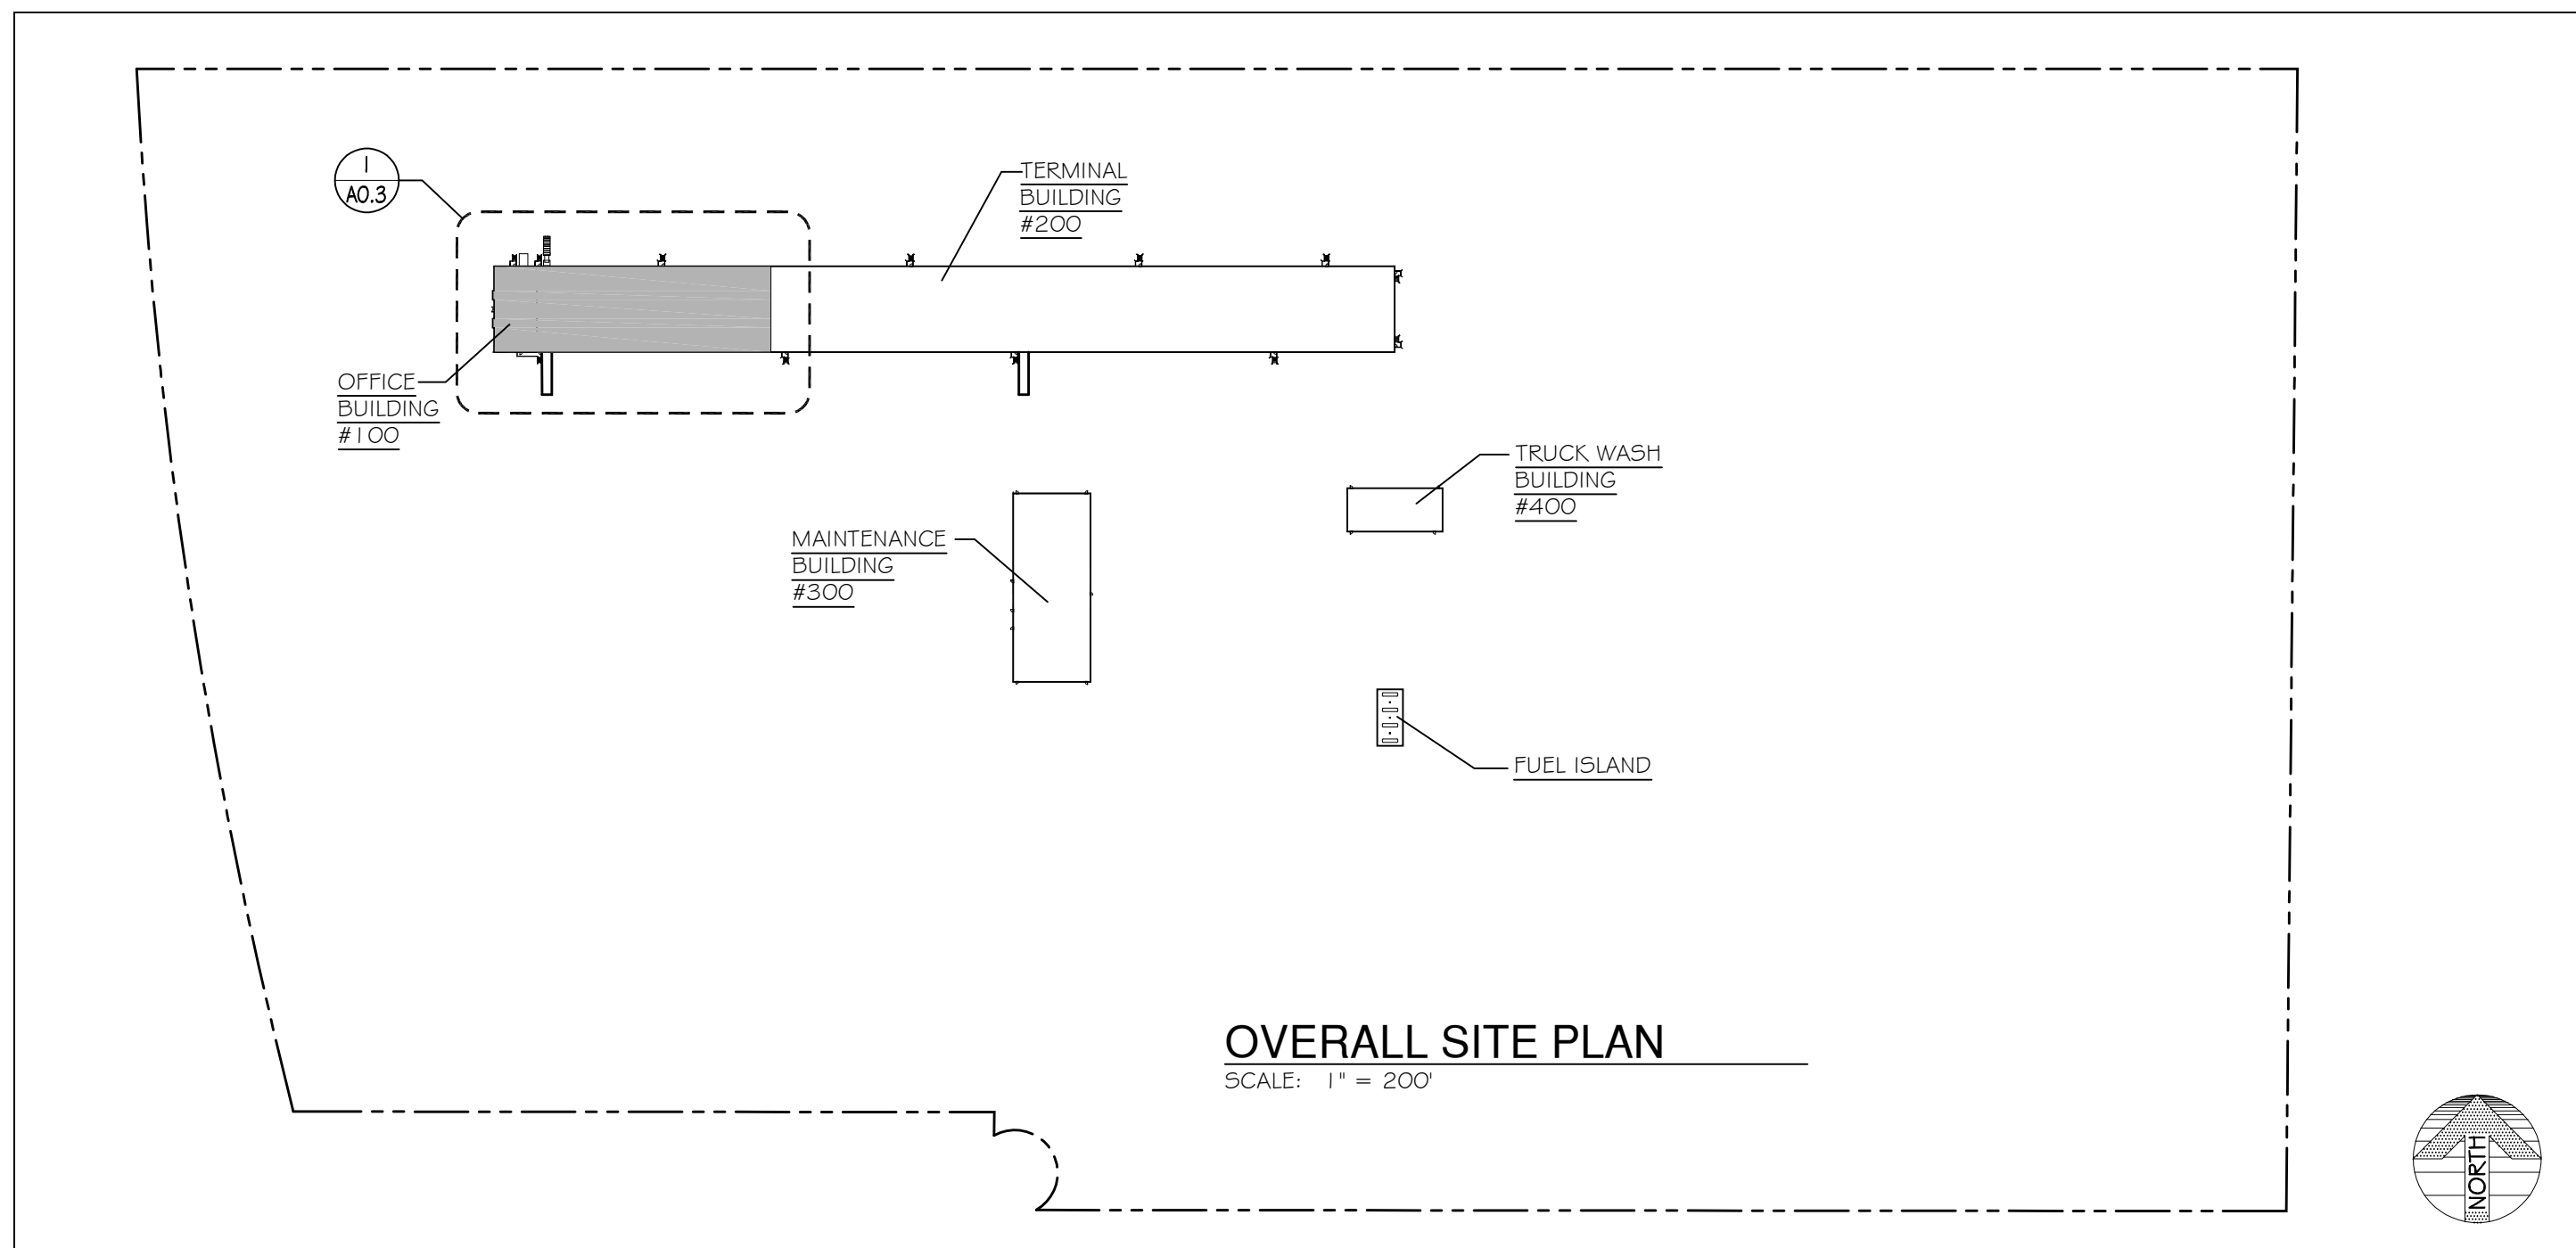

OVERALL SITE PLAN

SCALE: 1" = 200'

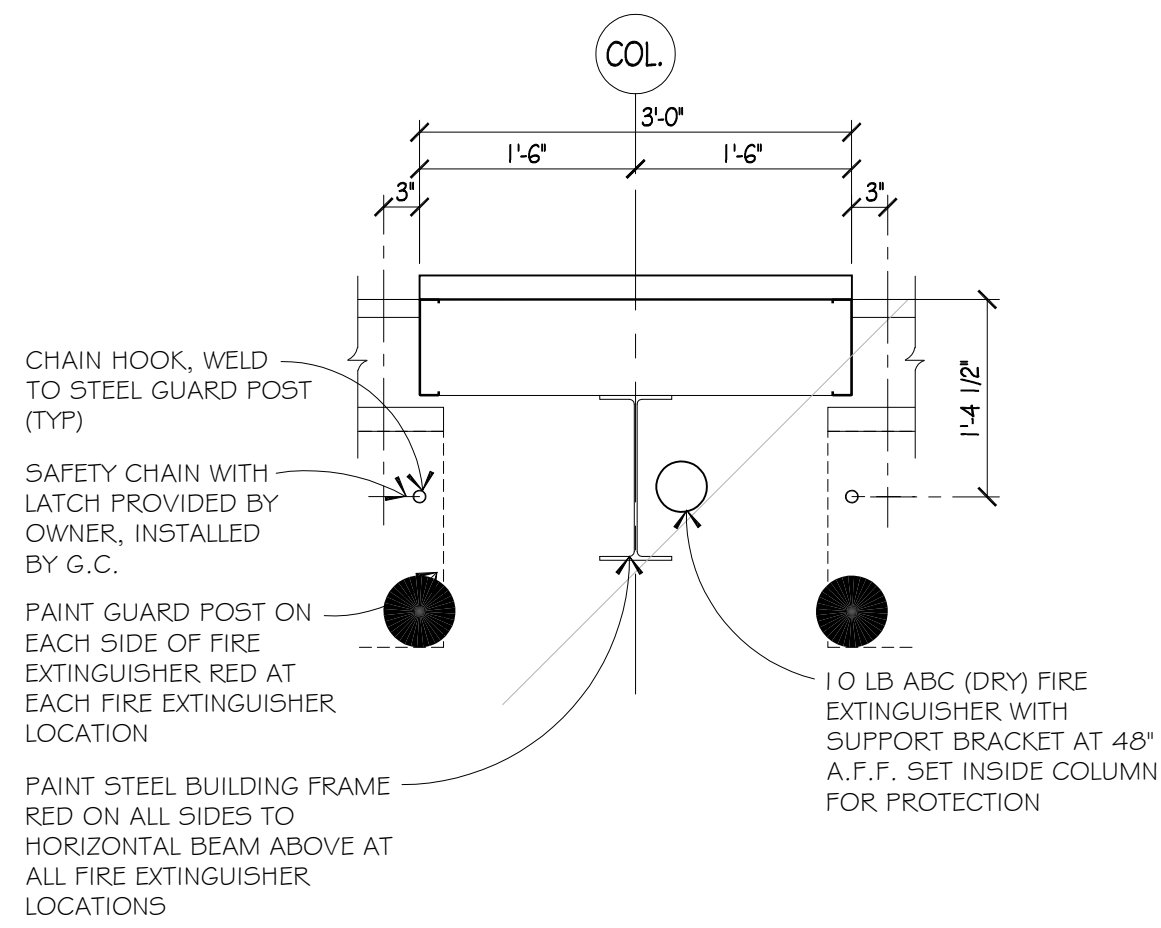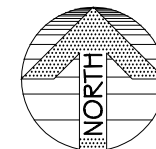


FIRE EXTINGUISHER DETAIL

SCALE: 3/4" = 1'-0"


2  
A0.3, A0.4, A0.5, A0.6



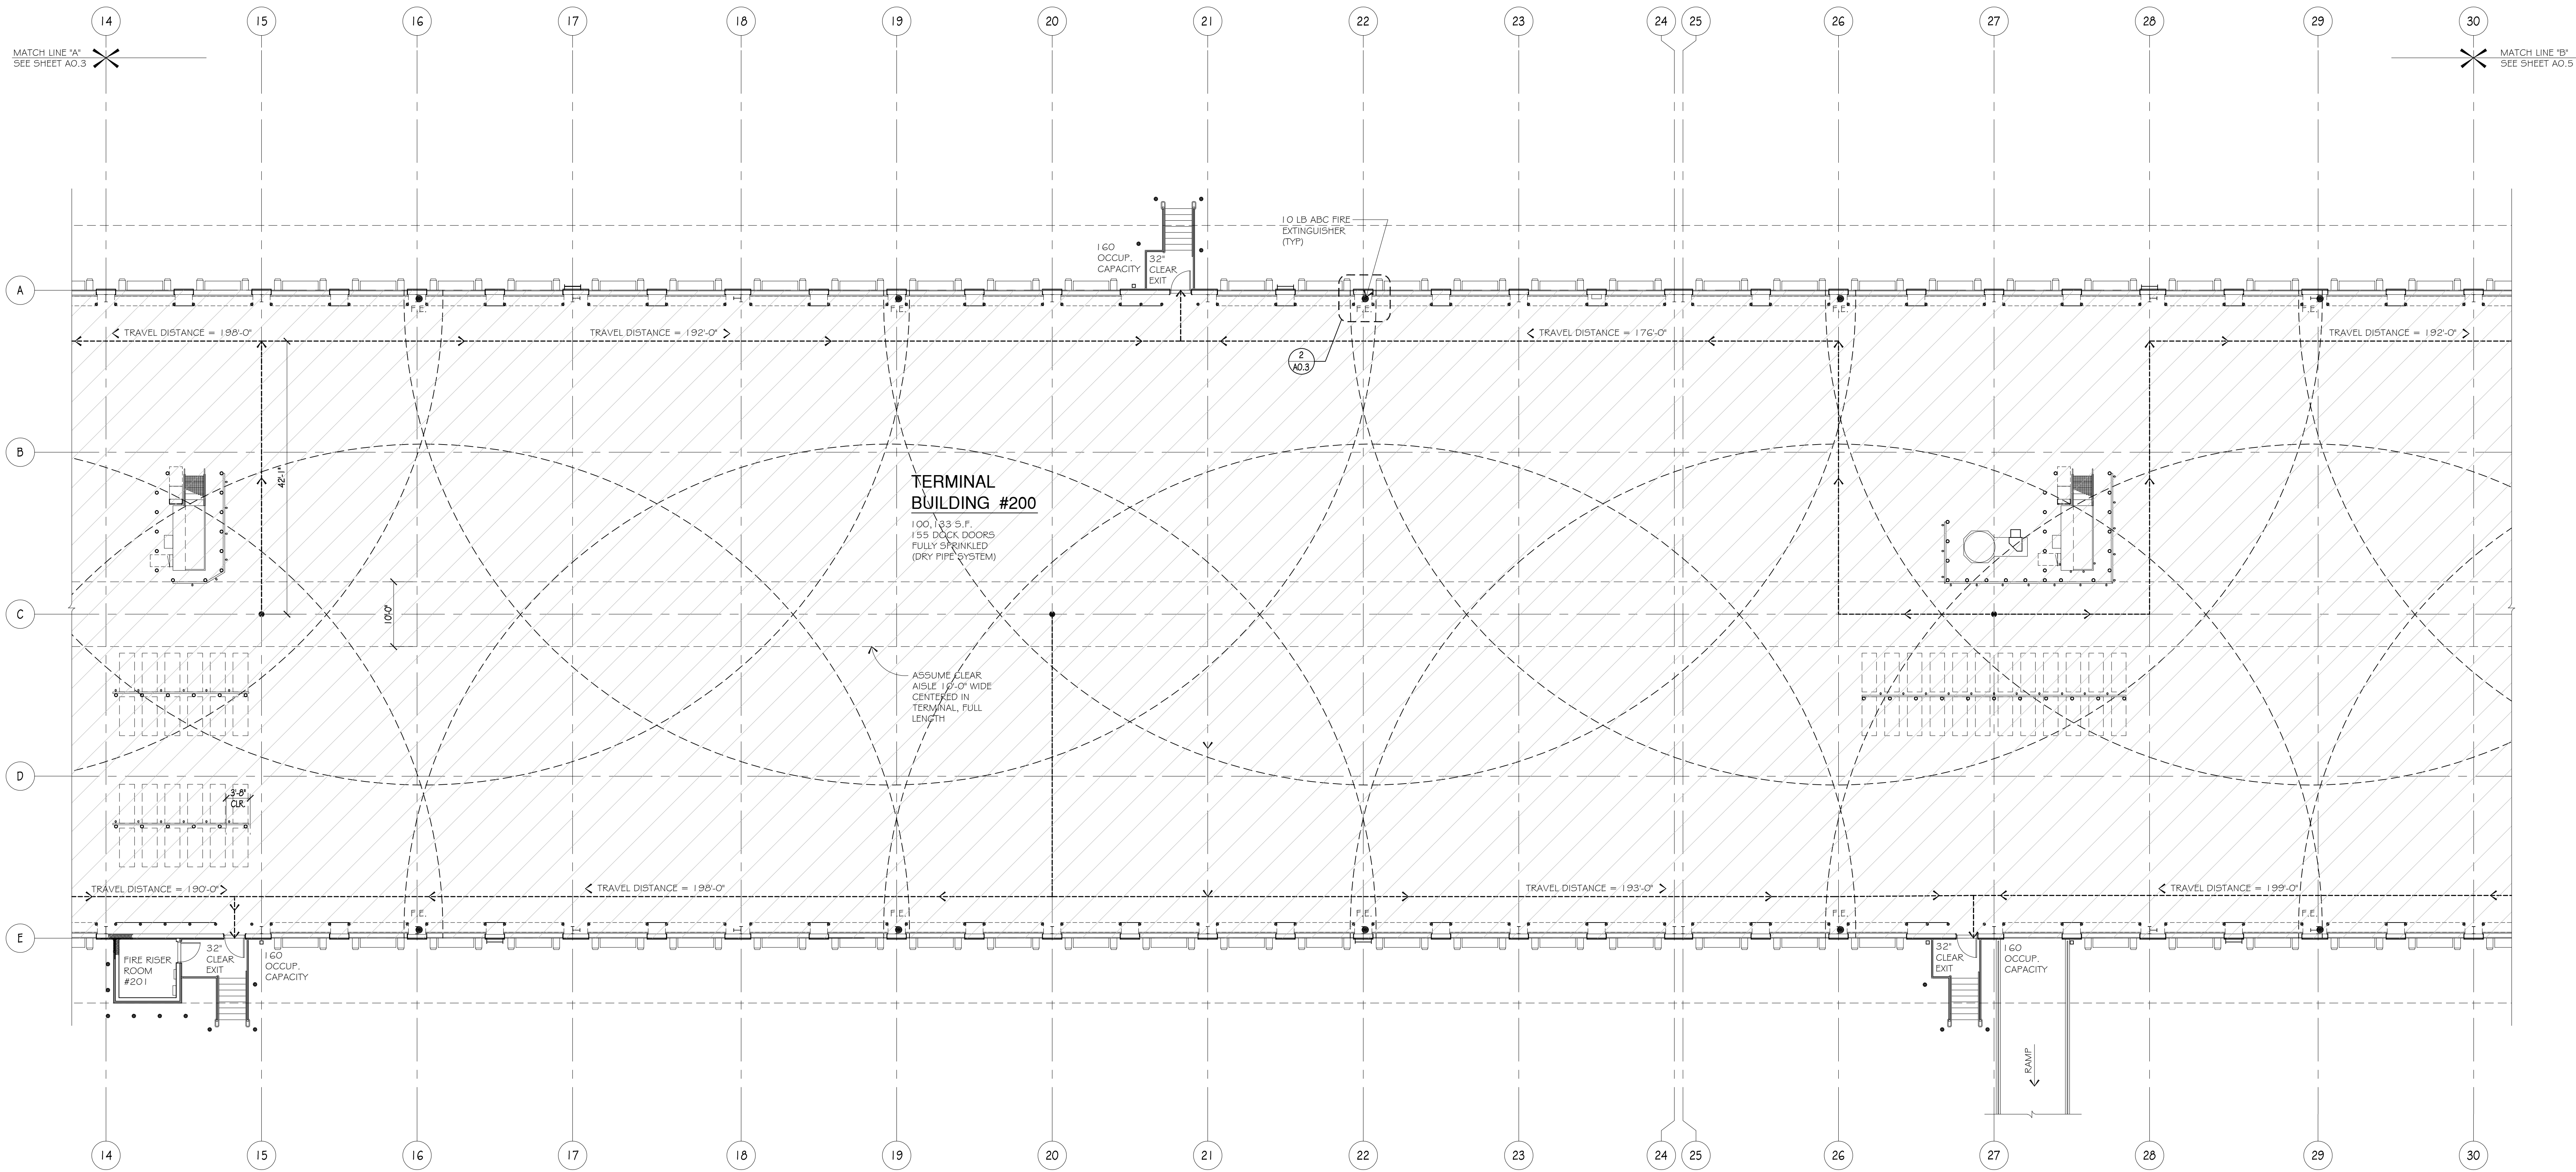


TERMINAL BUILDING #200 LIFE SAFETY PLAN  
SCALE: 3/32" = 1'-0"

1  
A0.4

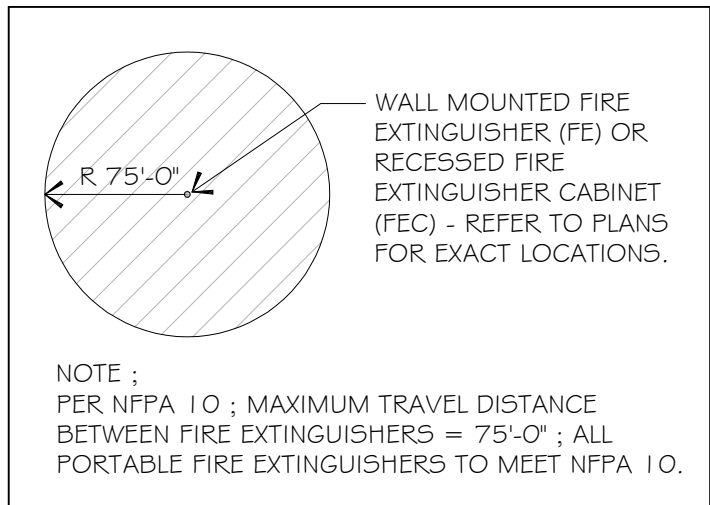


NOTE: GENERAL CONTRACTOR IS TO INSTALL OWNER FURNISHED FIRE EXTINGUISHERS THROUGHOUT TERMINAL BUILDING 200. COORDINATE WITH R.L. CARRIERS AND LOCAL FIRE MARSHALL FOR EXACT QUANTITY, TYPE AND LOCATIONS OF FIRE EXTINGUISHERS. R.L. CARRIERS STANDARD IS ONE FIRE EXTINGUISHER EVERY THIRD COLUMN / 6 DOCK DOORS AND ON BOTH SIDES OF TERMINAL. GENERAL CONTRACTOR SHALL PROVIDE AND INSTALL FIRE EXTINGUISHER SIGNAGE AT ALL FIRE EXTINGUISHER LOCATIONS.

NOTE: F.E. = FIRE EXTINGUISHER

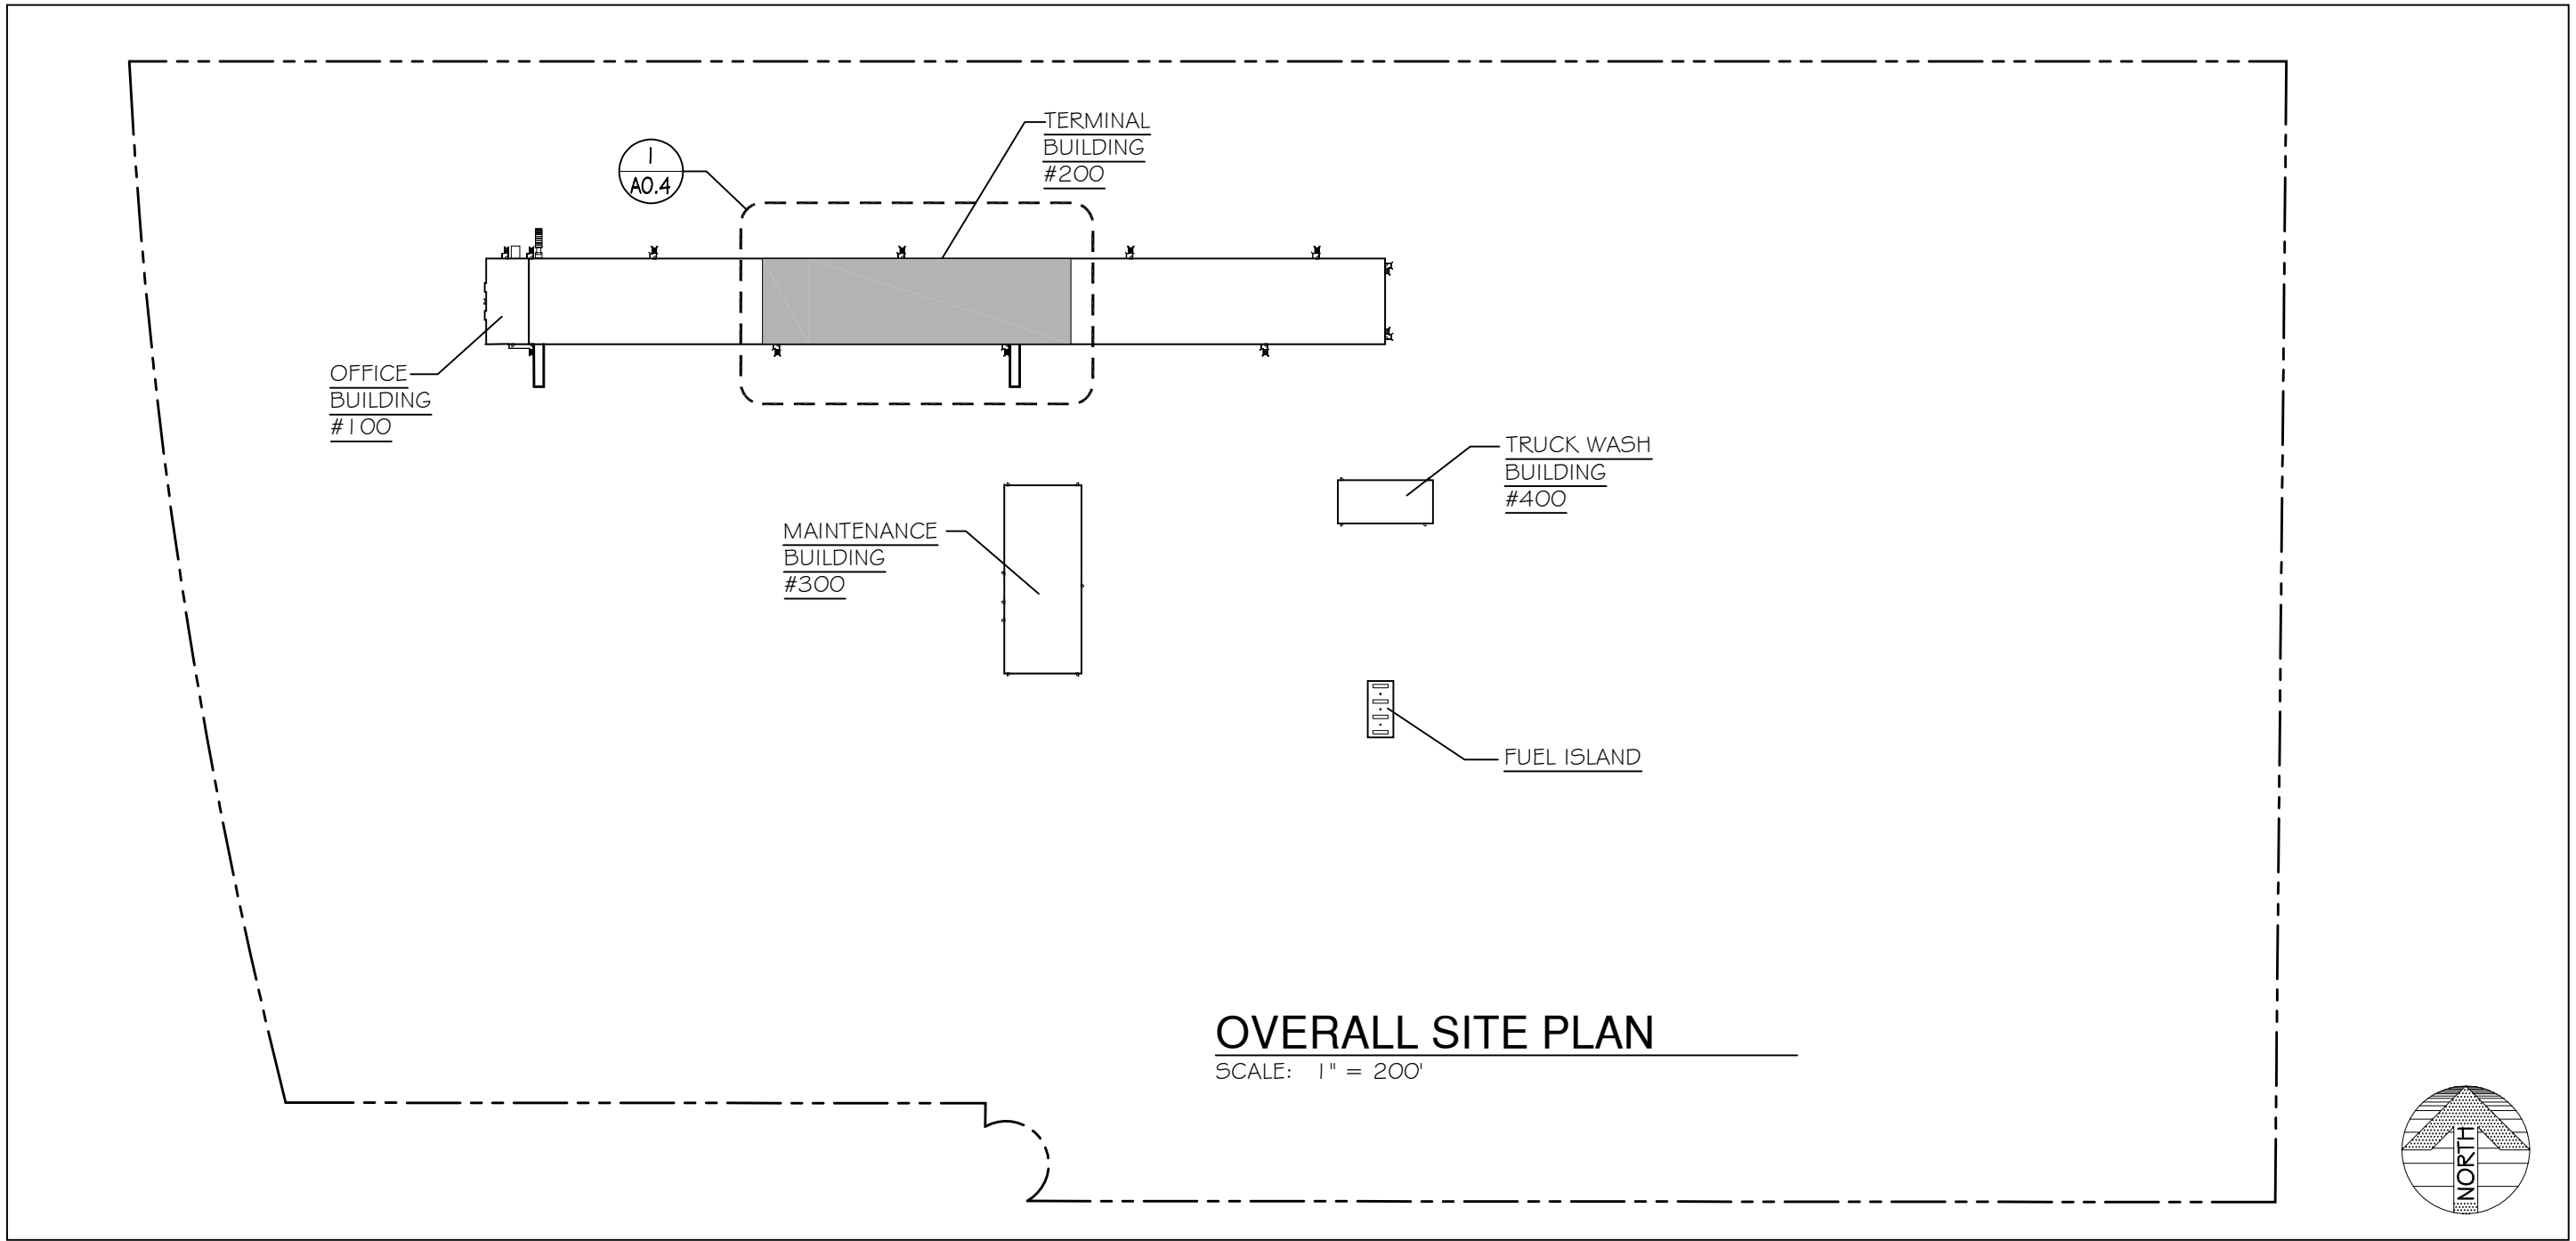



OVERALL SITE PLAN  
SCALE: 1" = 200'



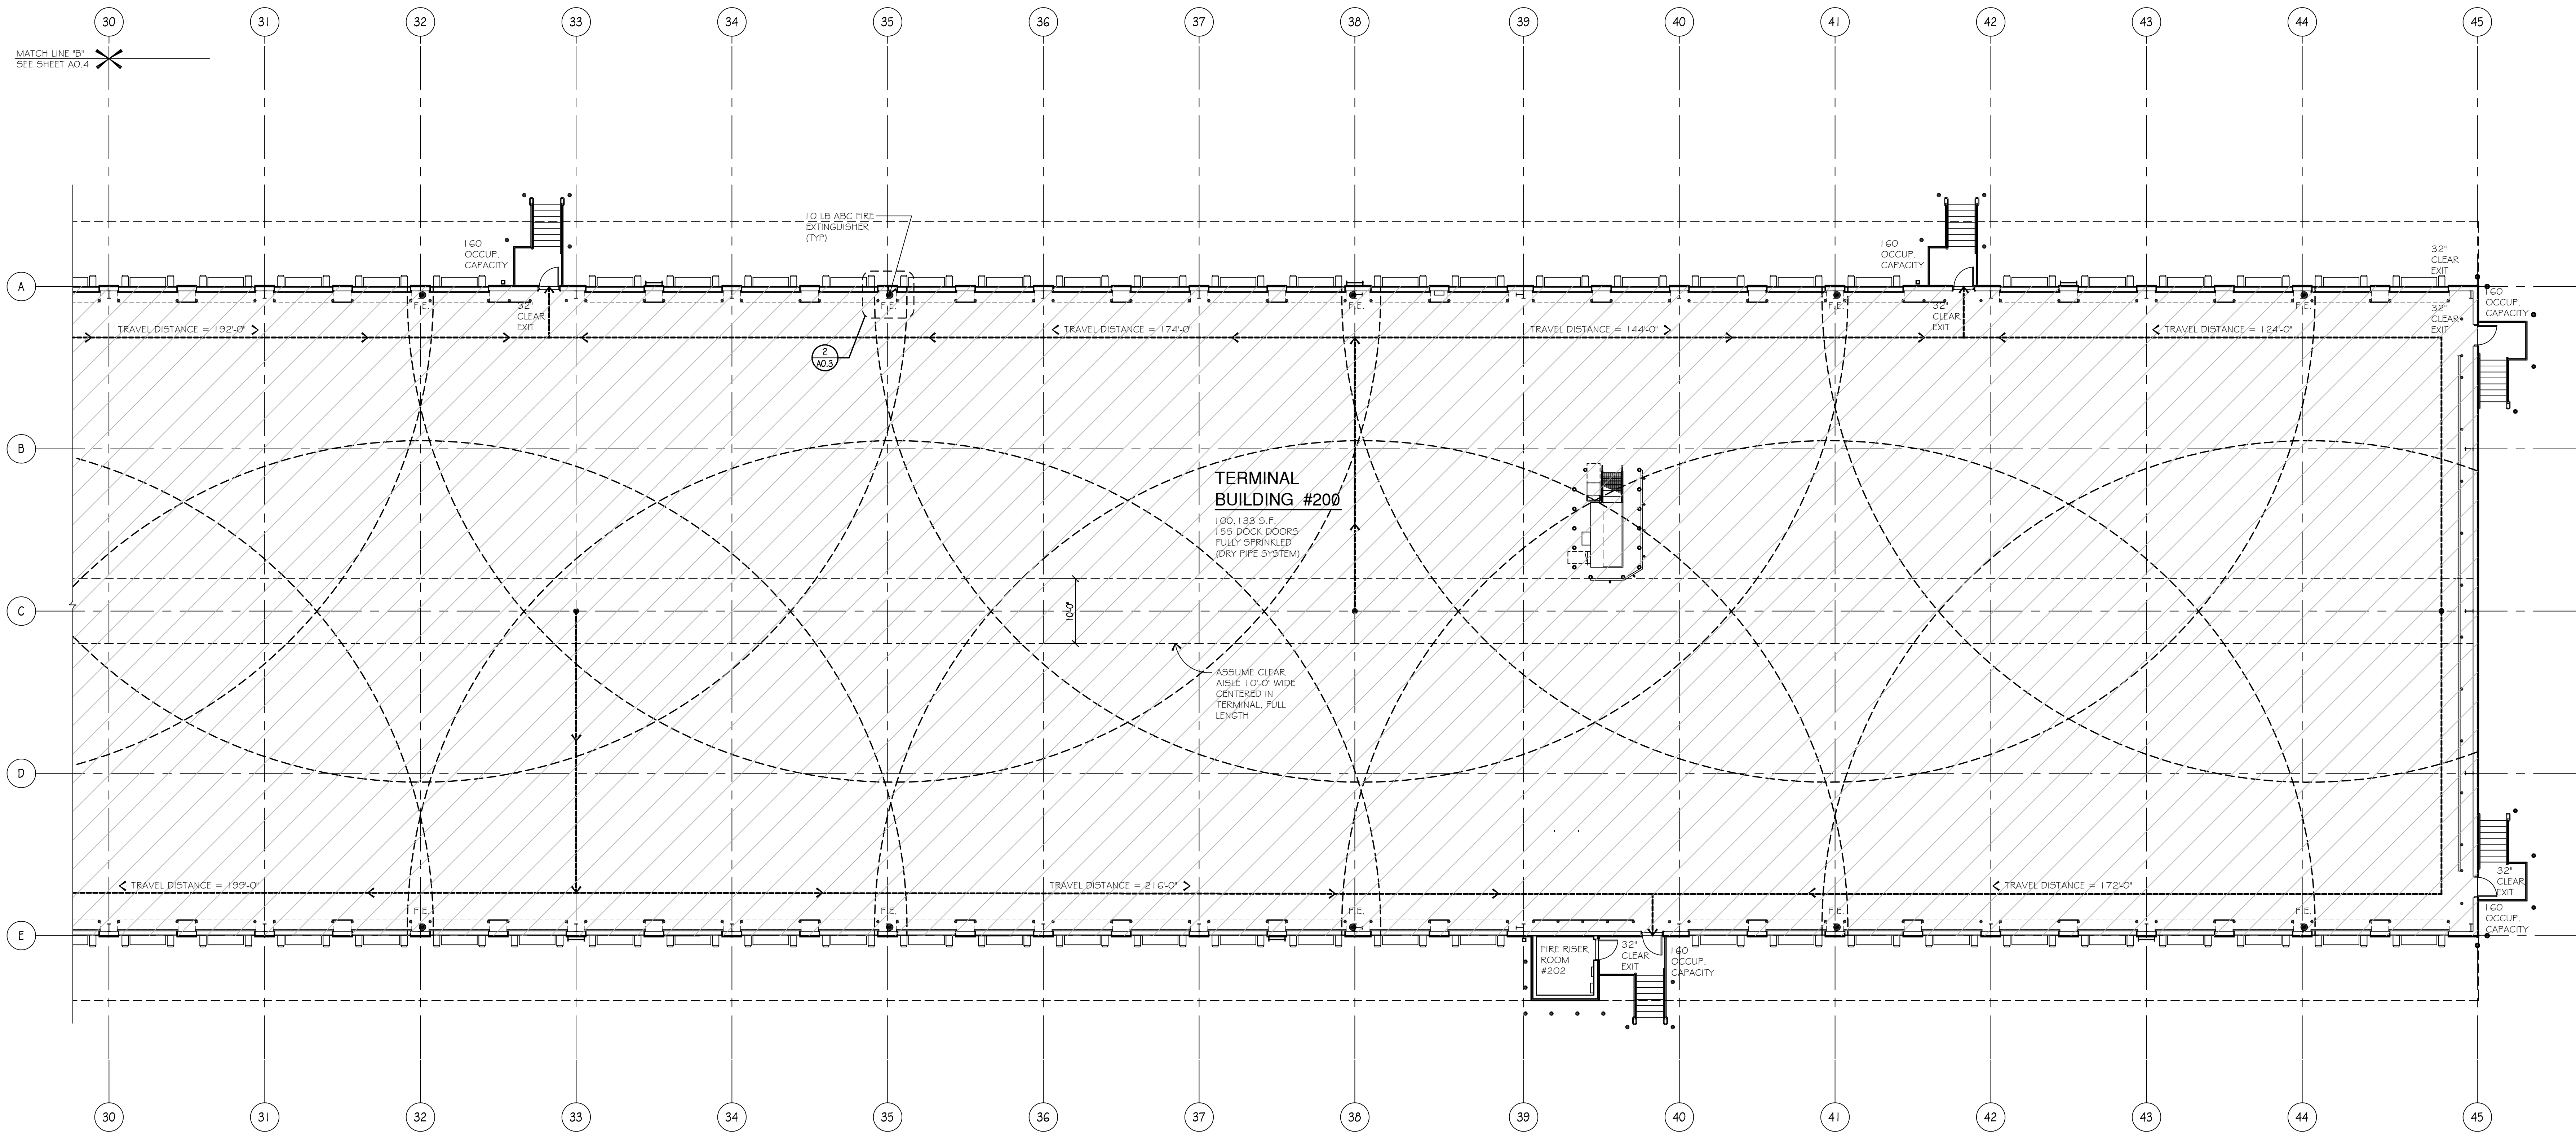

TERMINAL BUILDING #200 LIFE SAFETY PLAN  
SCALE: 3/32" = 1'-0"


A0.5

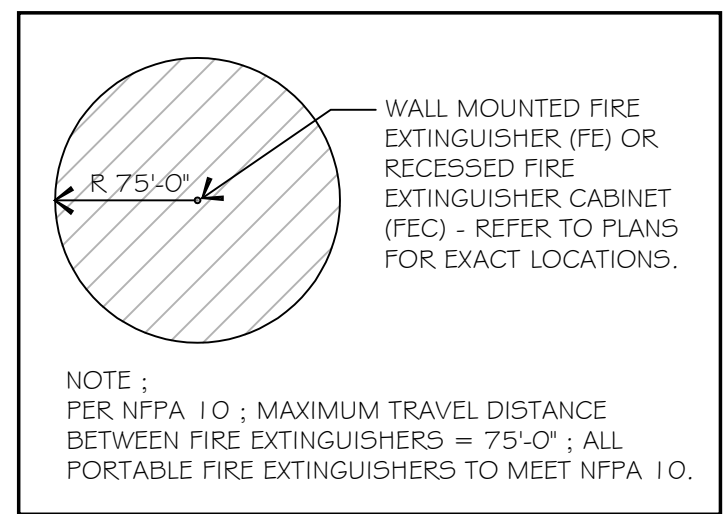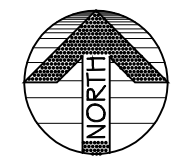

NOTE :  
PER NFPA 10 : MAXIMUM TRAVEL DISTANCE  
BETWEEN FIRE EXTINGUISHERS = 75'-0" ; ALL  
PORTABLE FIRE EXTINGUISHERS TO MEET NFPA 10.


NOTE:  
GENERAL CONTRACTOR IS TO INSTALL OWNER  
FURNISHED FIRE EXTINGUISHERS THROUGHOUT  
TERMINAL BUILDING 200. COORDINATE WITH R.L.  
CARRIERS AND LOCAL FIRE MARSHALL FOR  
EXACT QUANTITY, TYPE AND LOCATIONS OF FIRE  
EXTINGUISHERS. R.L. CARRIERS STANDARDS IS  
ONE FIRE EXTINGUISHER EVERY THIRD COLUMN /  
6 DOCK DOORS AND ON BOTH SIDES OF  
TERMINAL. GENERAL CONTRACTOR SHALL  
PROVIDE AND INSTALL FIRE EXTINGUISHER  
SIGNAGE AT ALL FIRE EXTINGUISHER LOCATIONS.

NOTE: F.E. = FIRE EXTINGUISHER

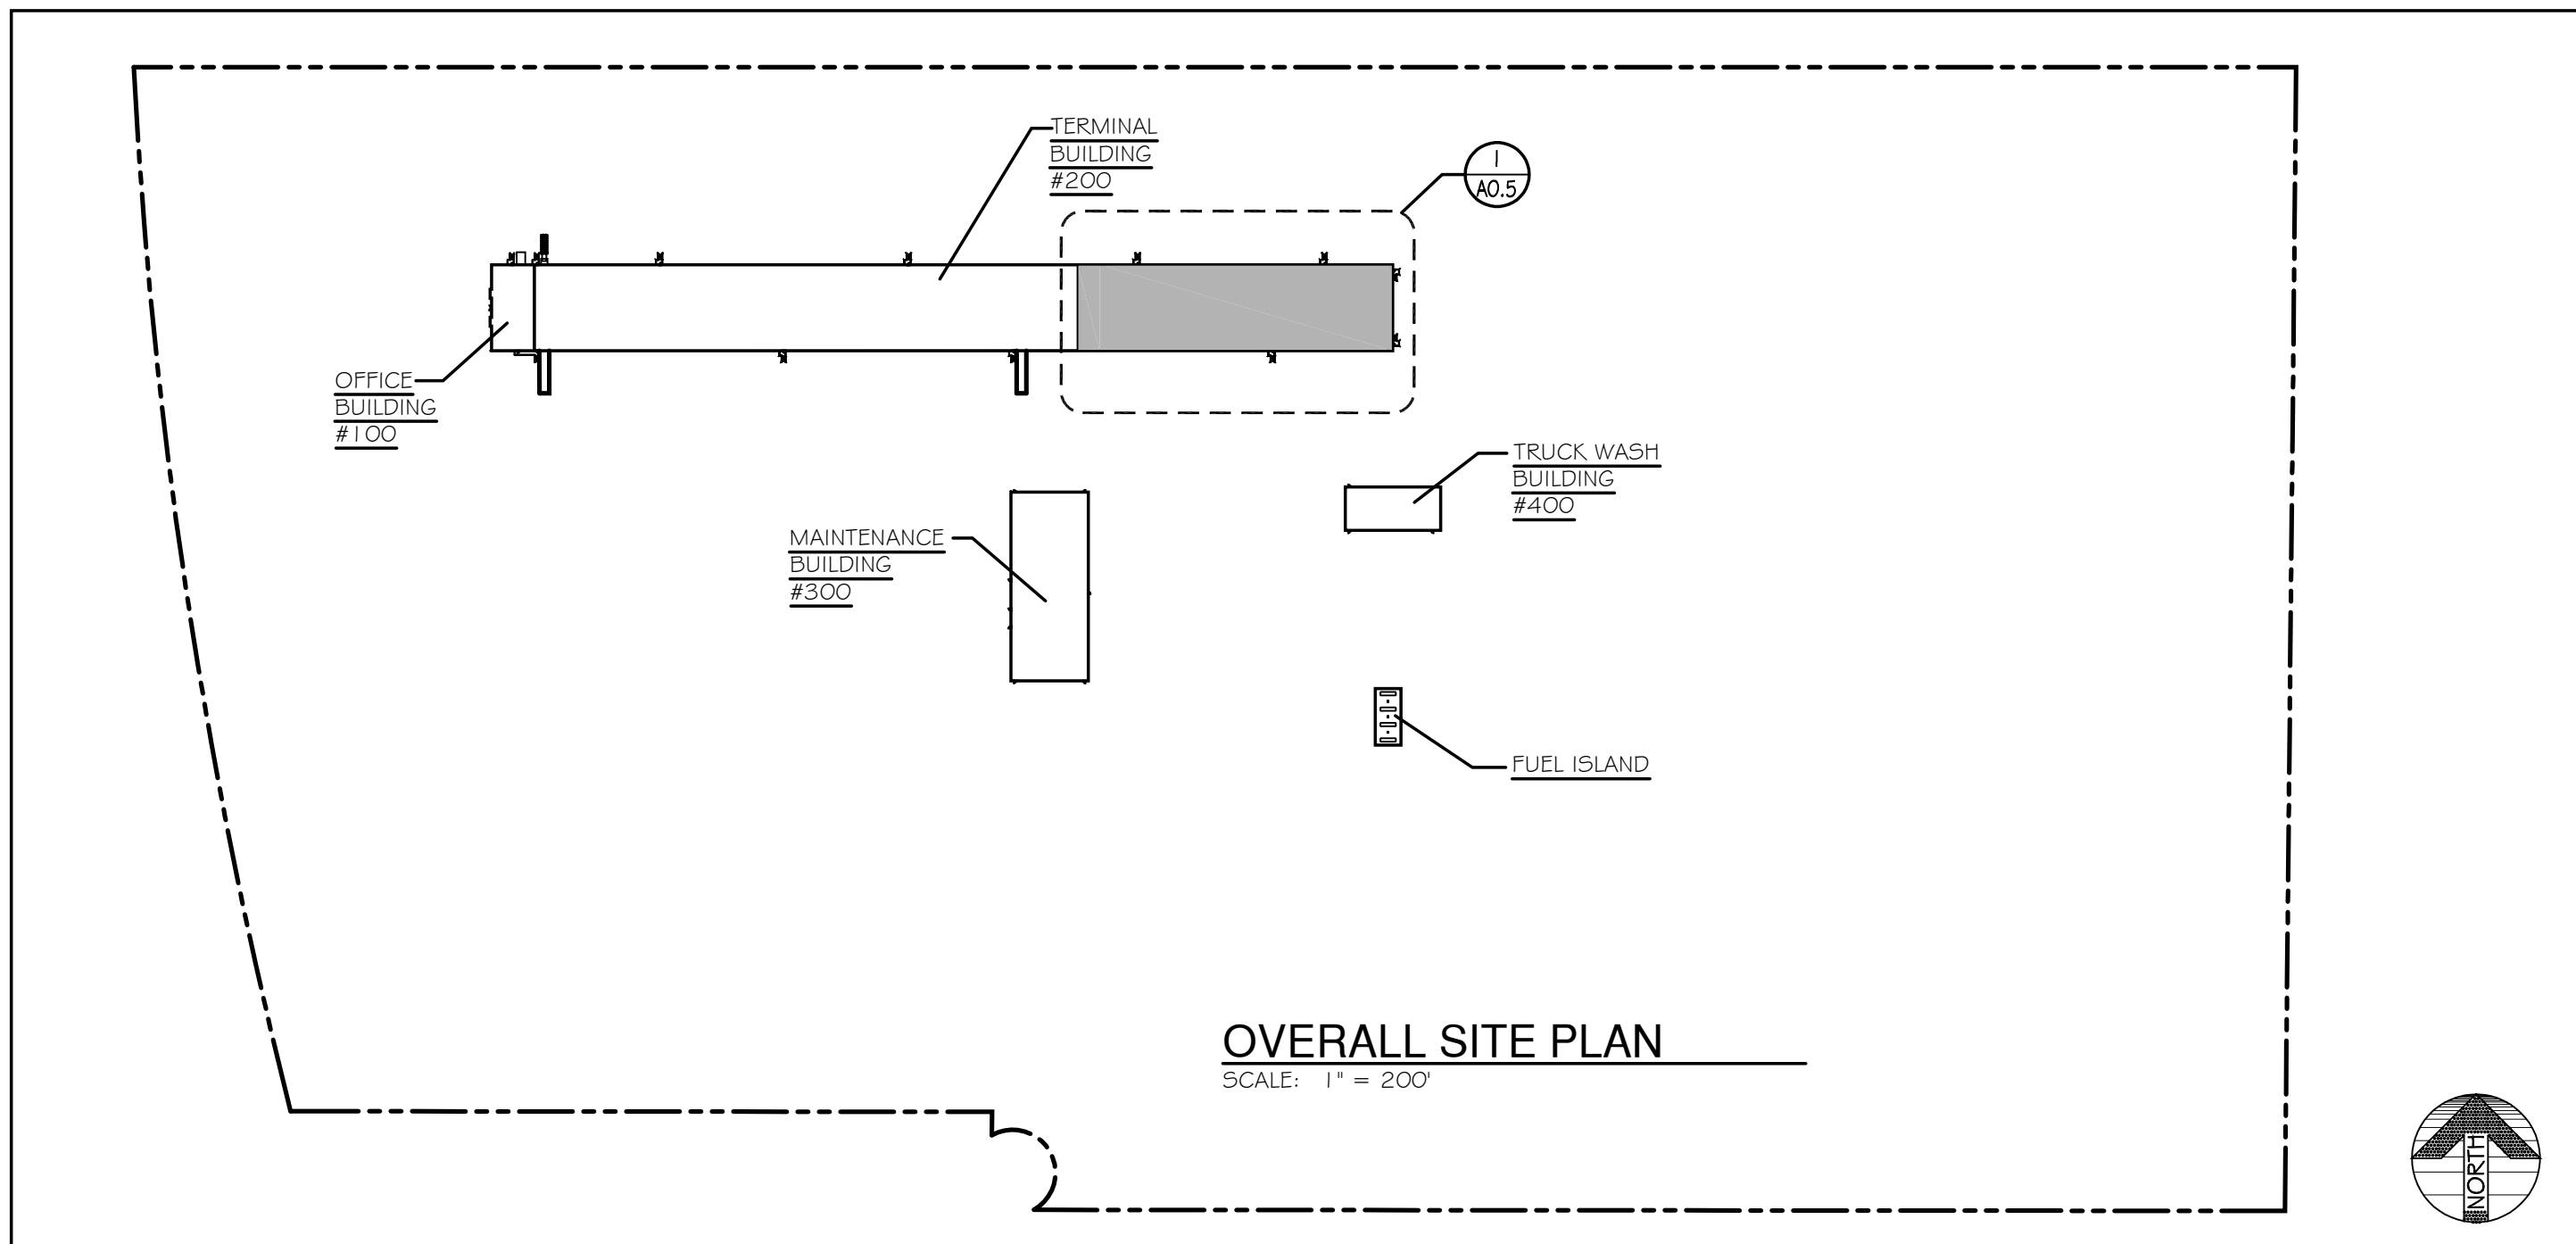


OVERALL SITE PLAN  
SCALE: 1" = 200'




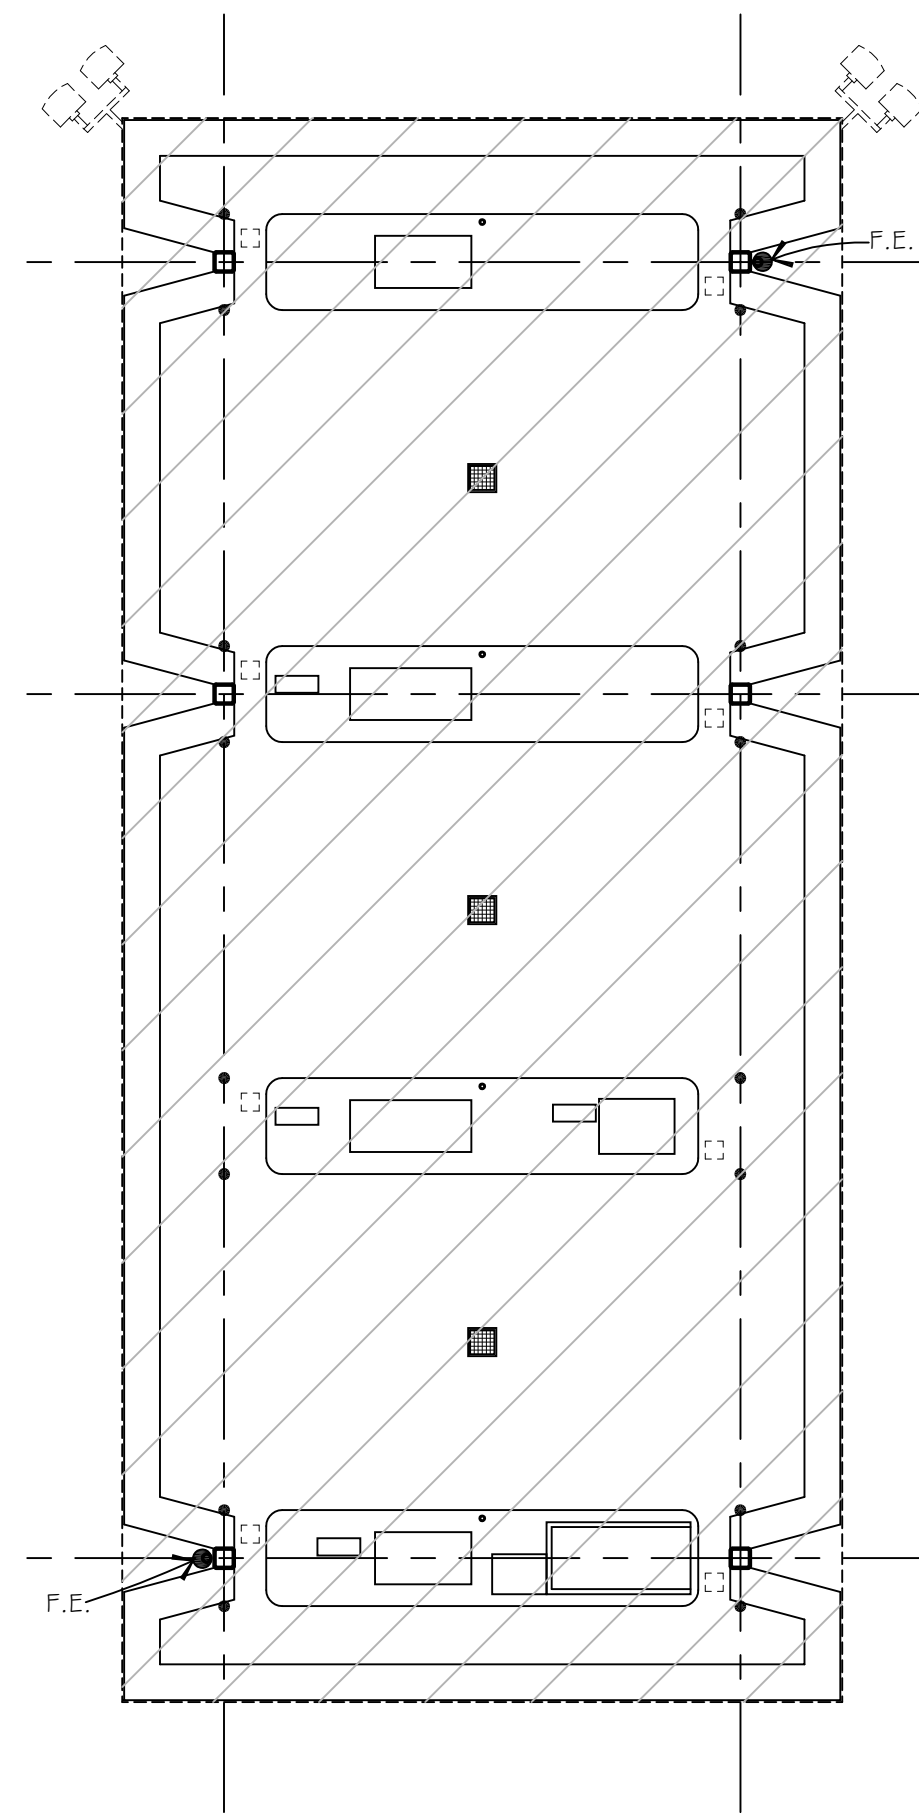


**FUEL ISLAND LIFE SAFETY PLAN**  
SCALE: 1/8" = 1'-0"

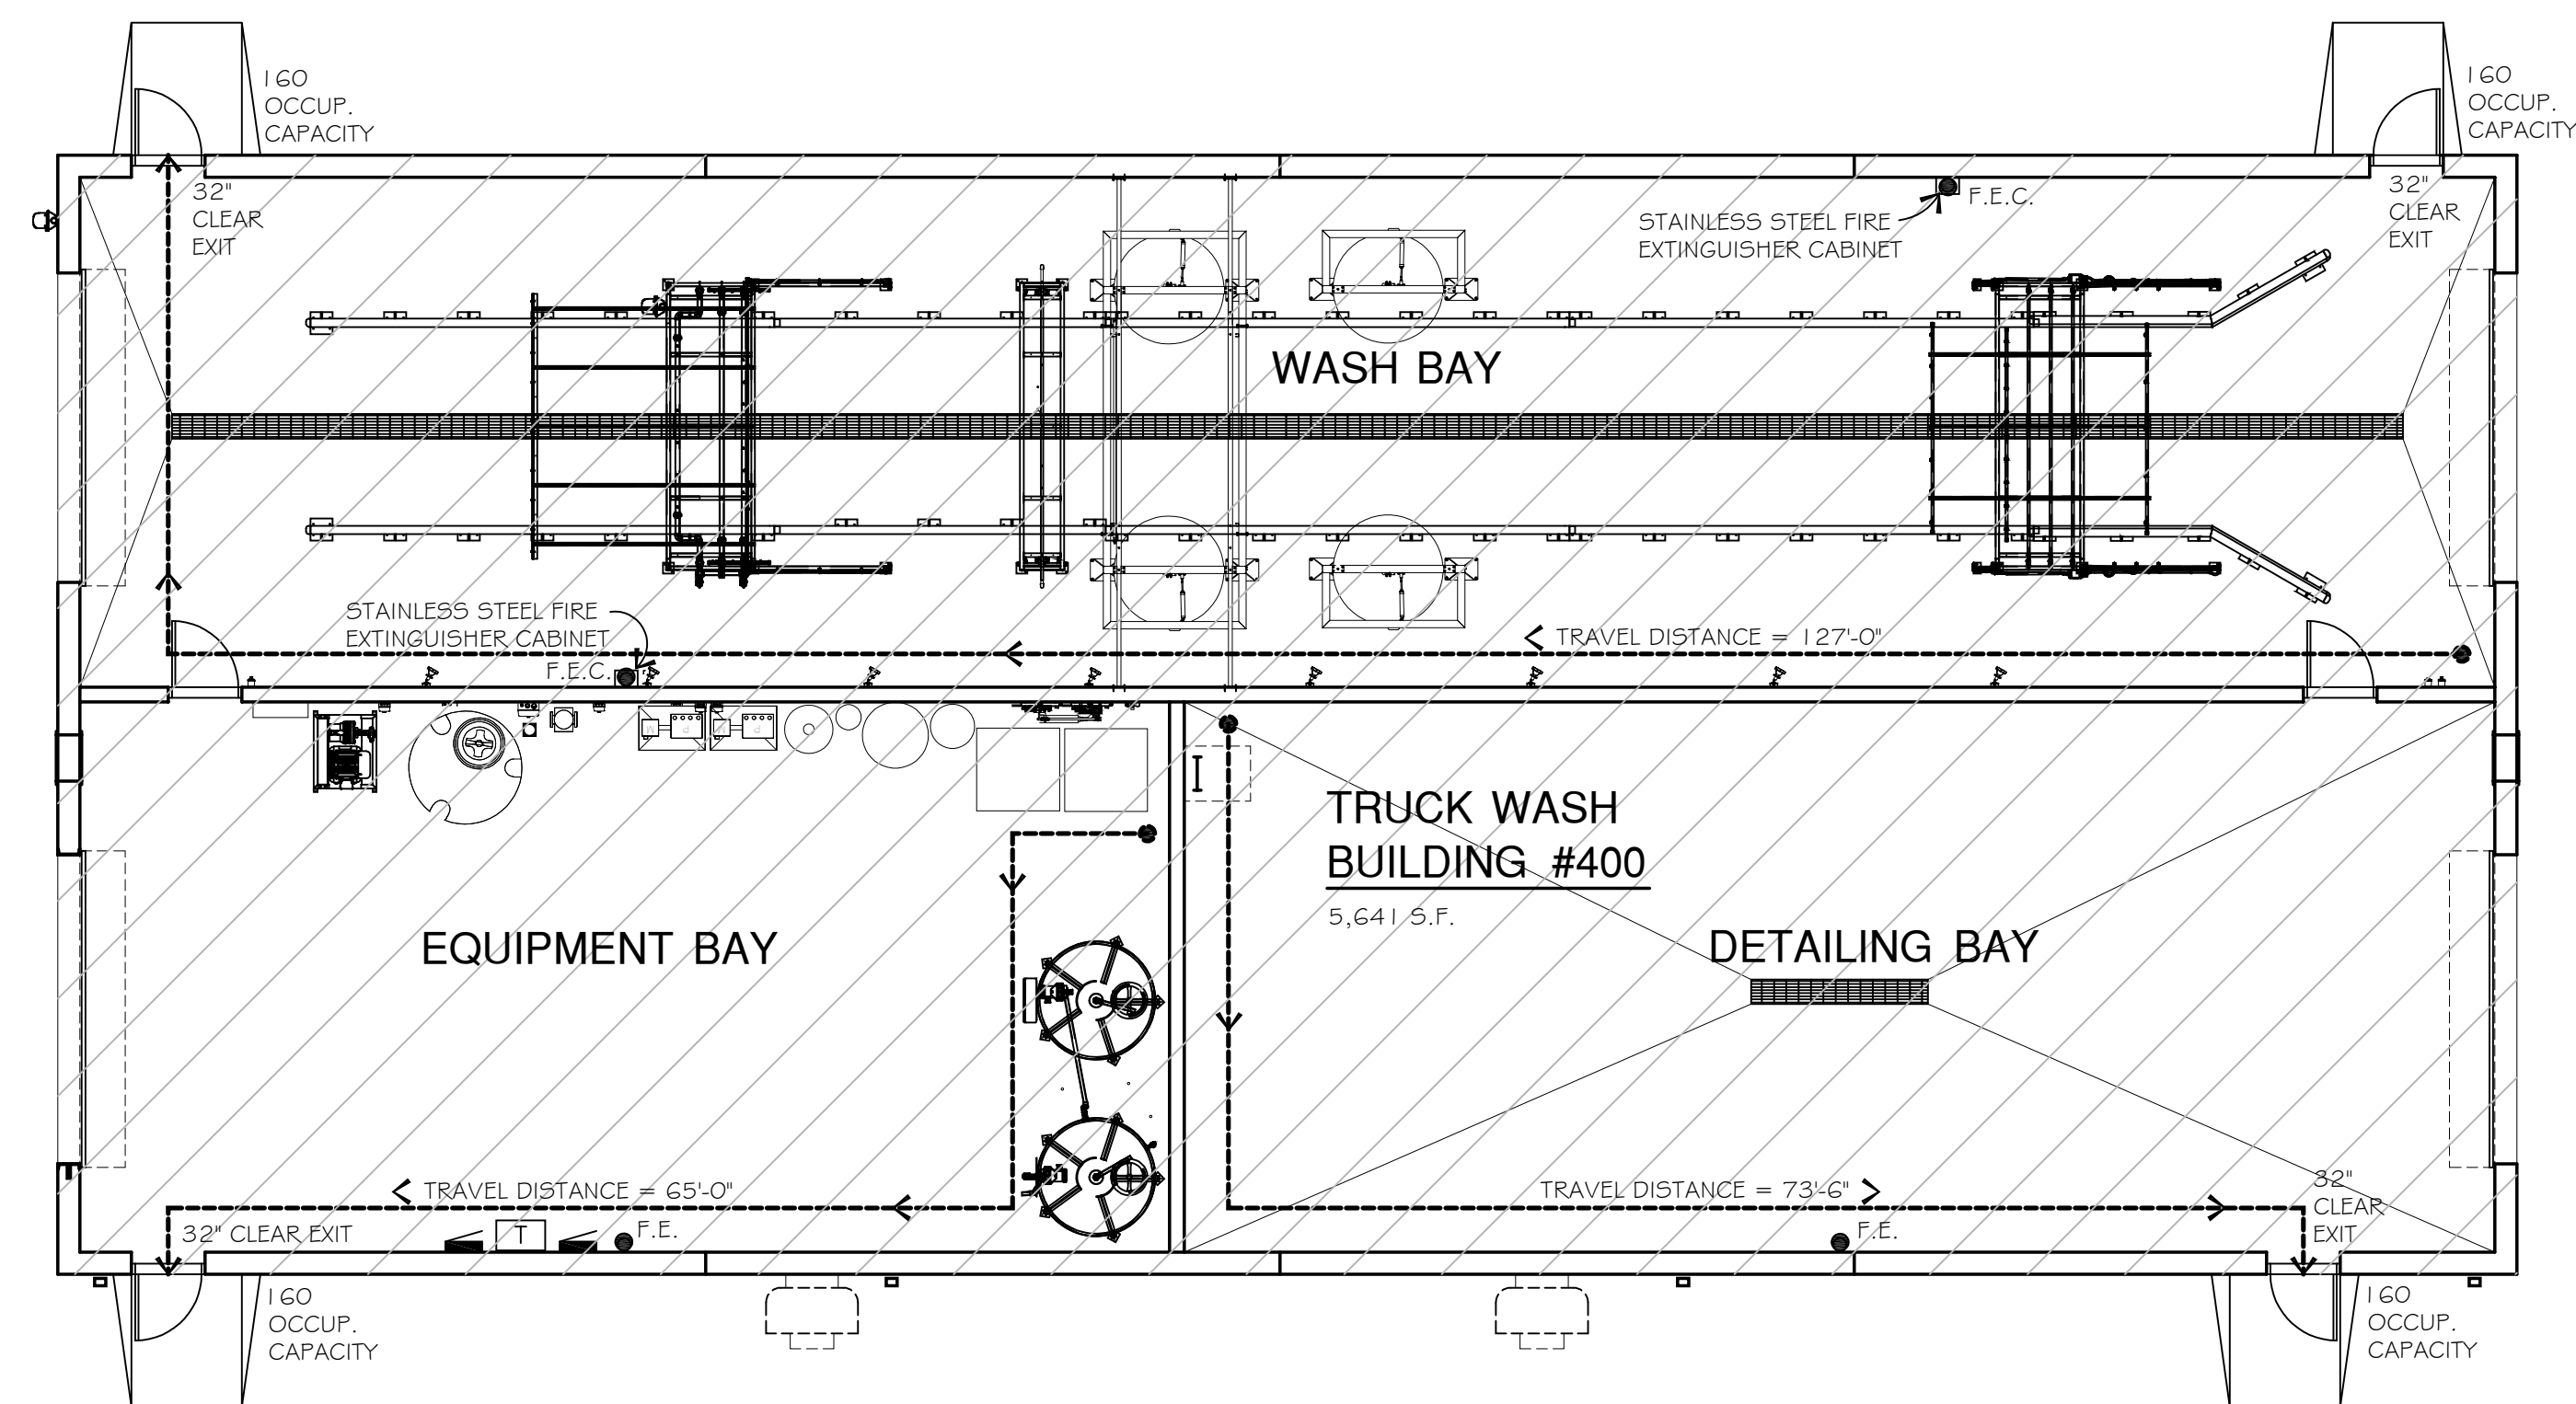

**TRUCK WASH BUILDING #400 LIFE SAFETY PLAN**  
SCALE: 1/8" = 1'-0"

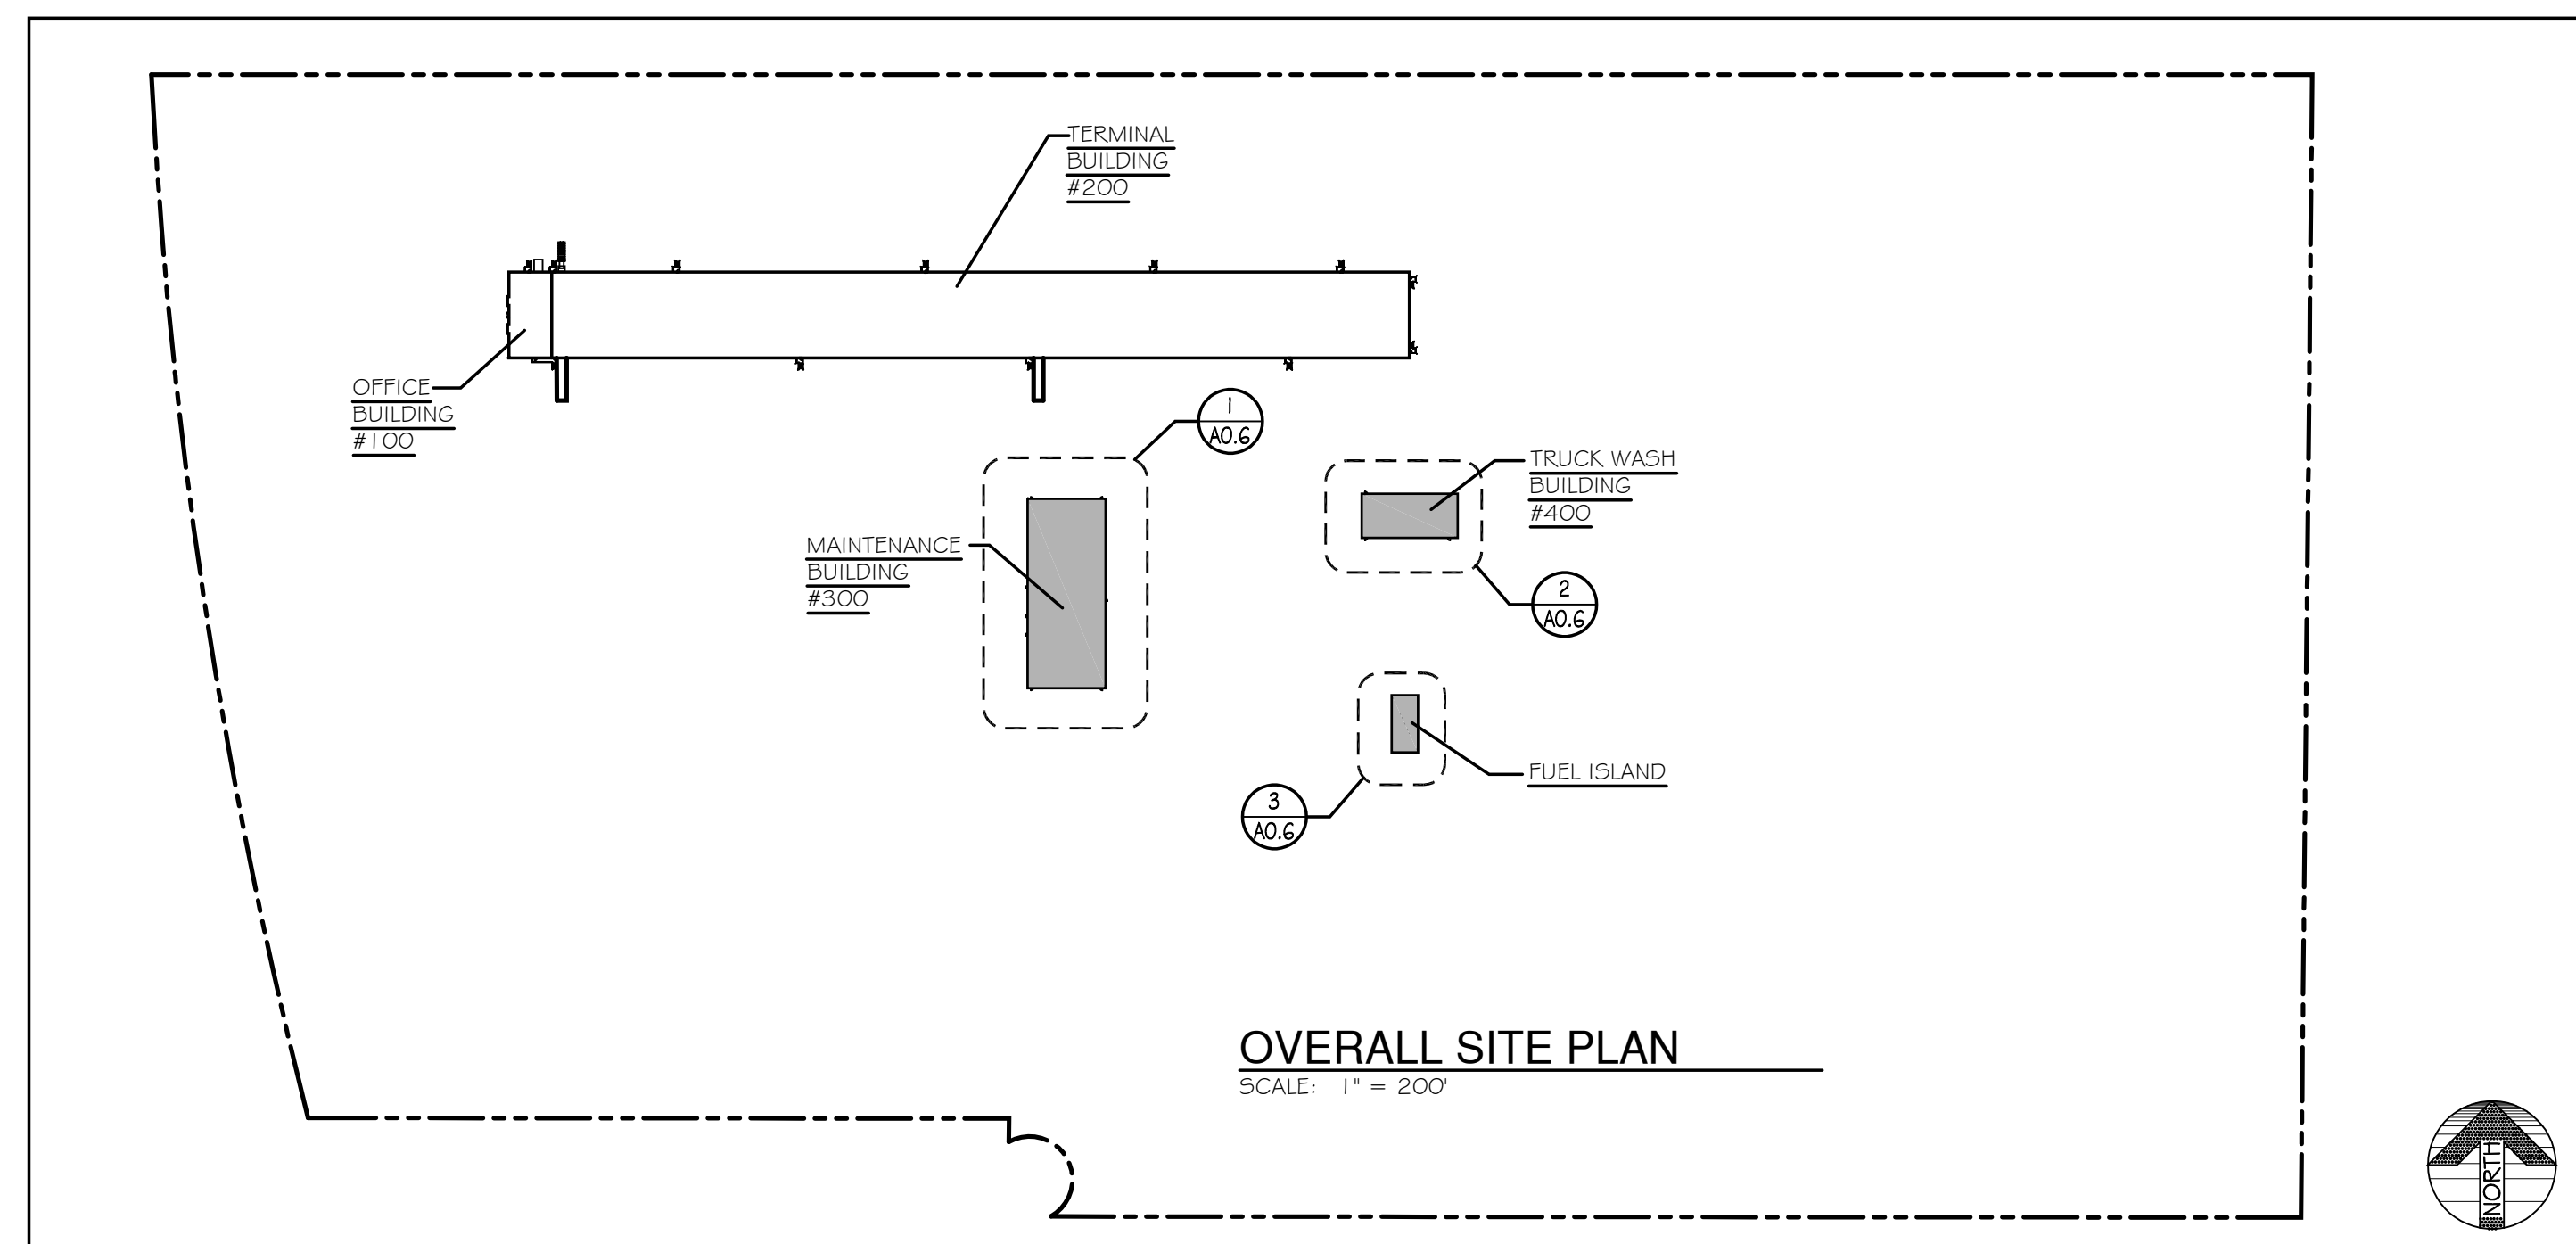


**OVERALL SITE PLAN**  
SCALE: 1" = 200'

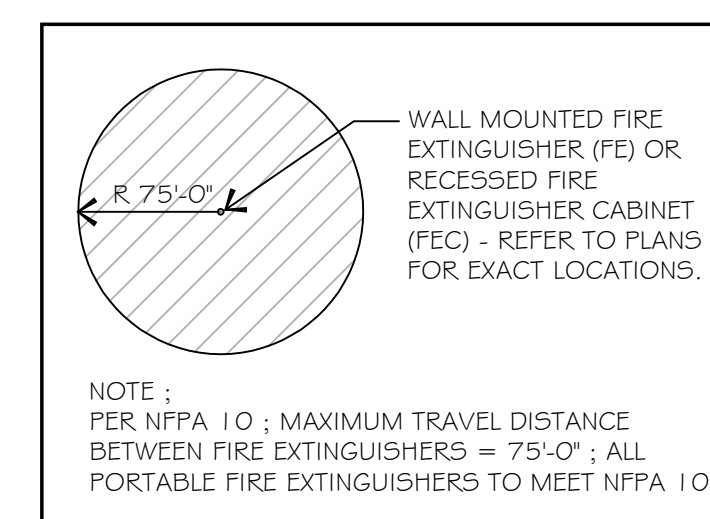


NOTE:  
GENERAL CONTRACTOR IS TO INSTALL OWNER FURNISHED FIRE EXTINGUISHERS THROUGHOUT MAINTENANCE BUILDING 300, TRUCK WASH BUILDING 400 AND FUEL ISLAND. COORDINATE WITH R.L. CARRIERS AND LOCAL FIRE MARSHALL FOR EXACT QUANTITY, TYPE AND LOCATIONS OF FIRE EXTINGUISHERS. GENERAL CONTRACTOR SHALL PROVIDE AND INSTALL FIRE EXTINGUISHER SIGNAGE AT ALL FIRE EXTINGUISHER LOCATIONS.

NOTE: F.E. = FIRE EXTINGUISHER

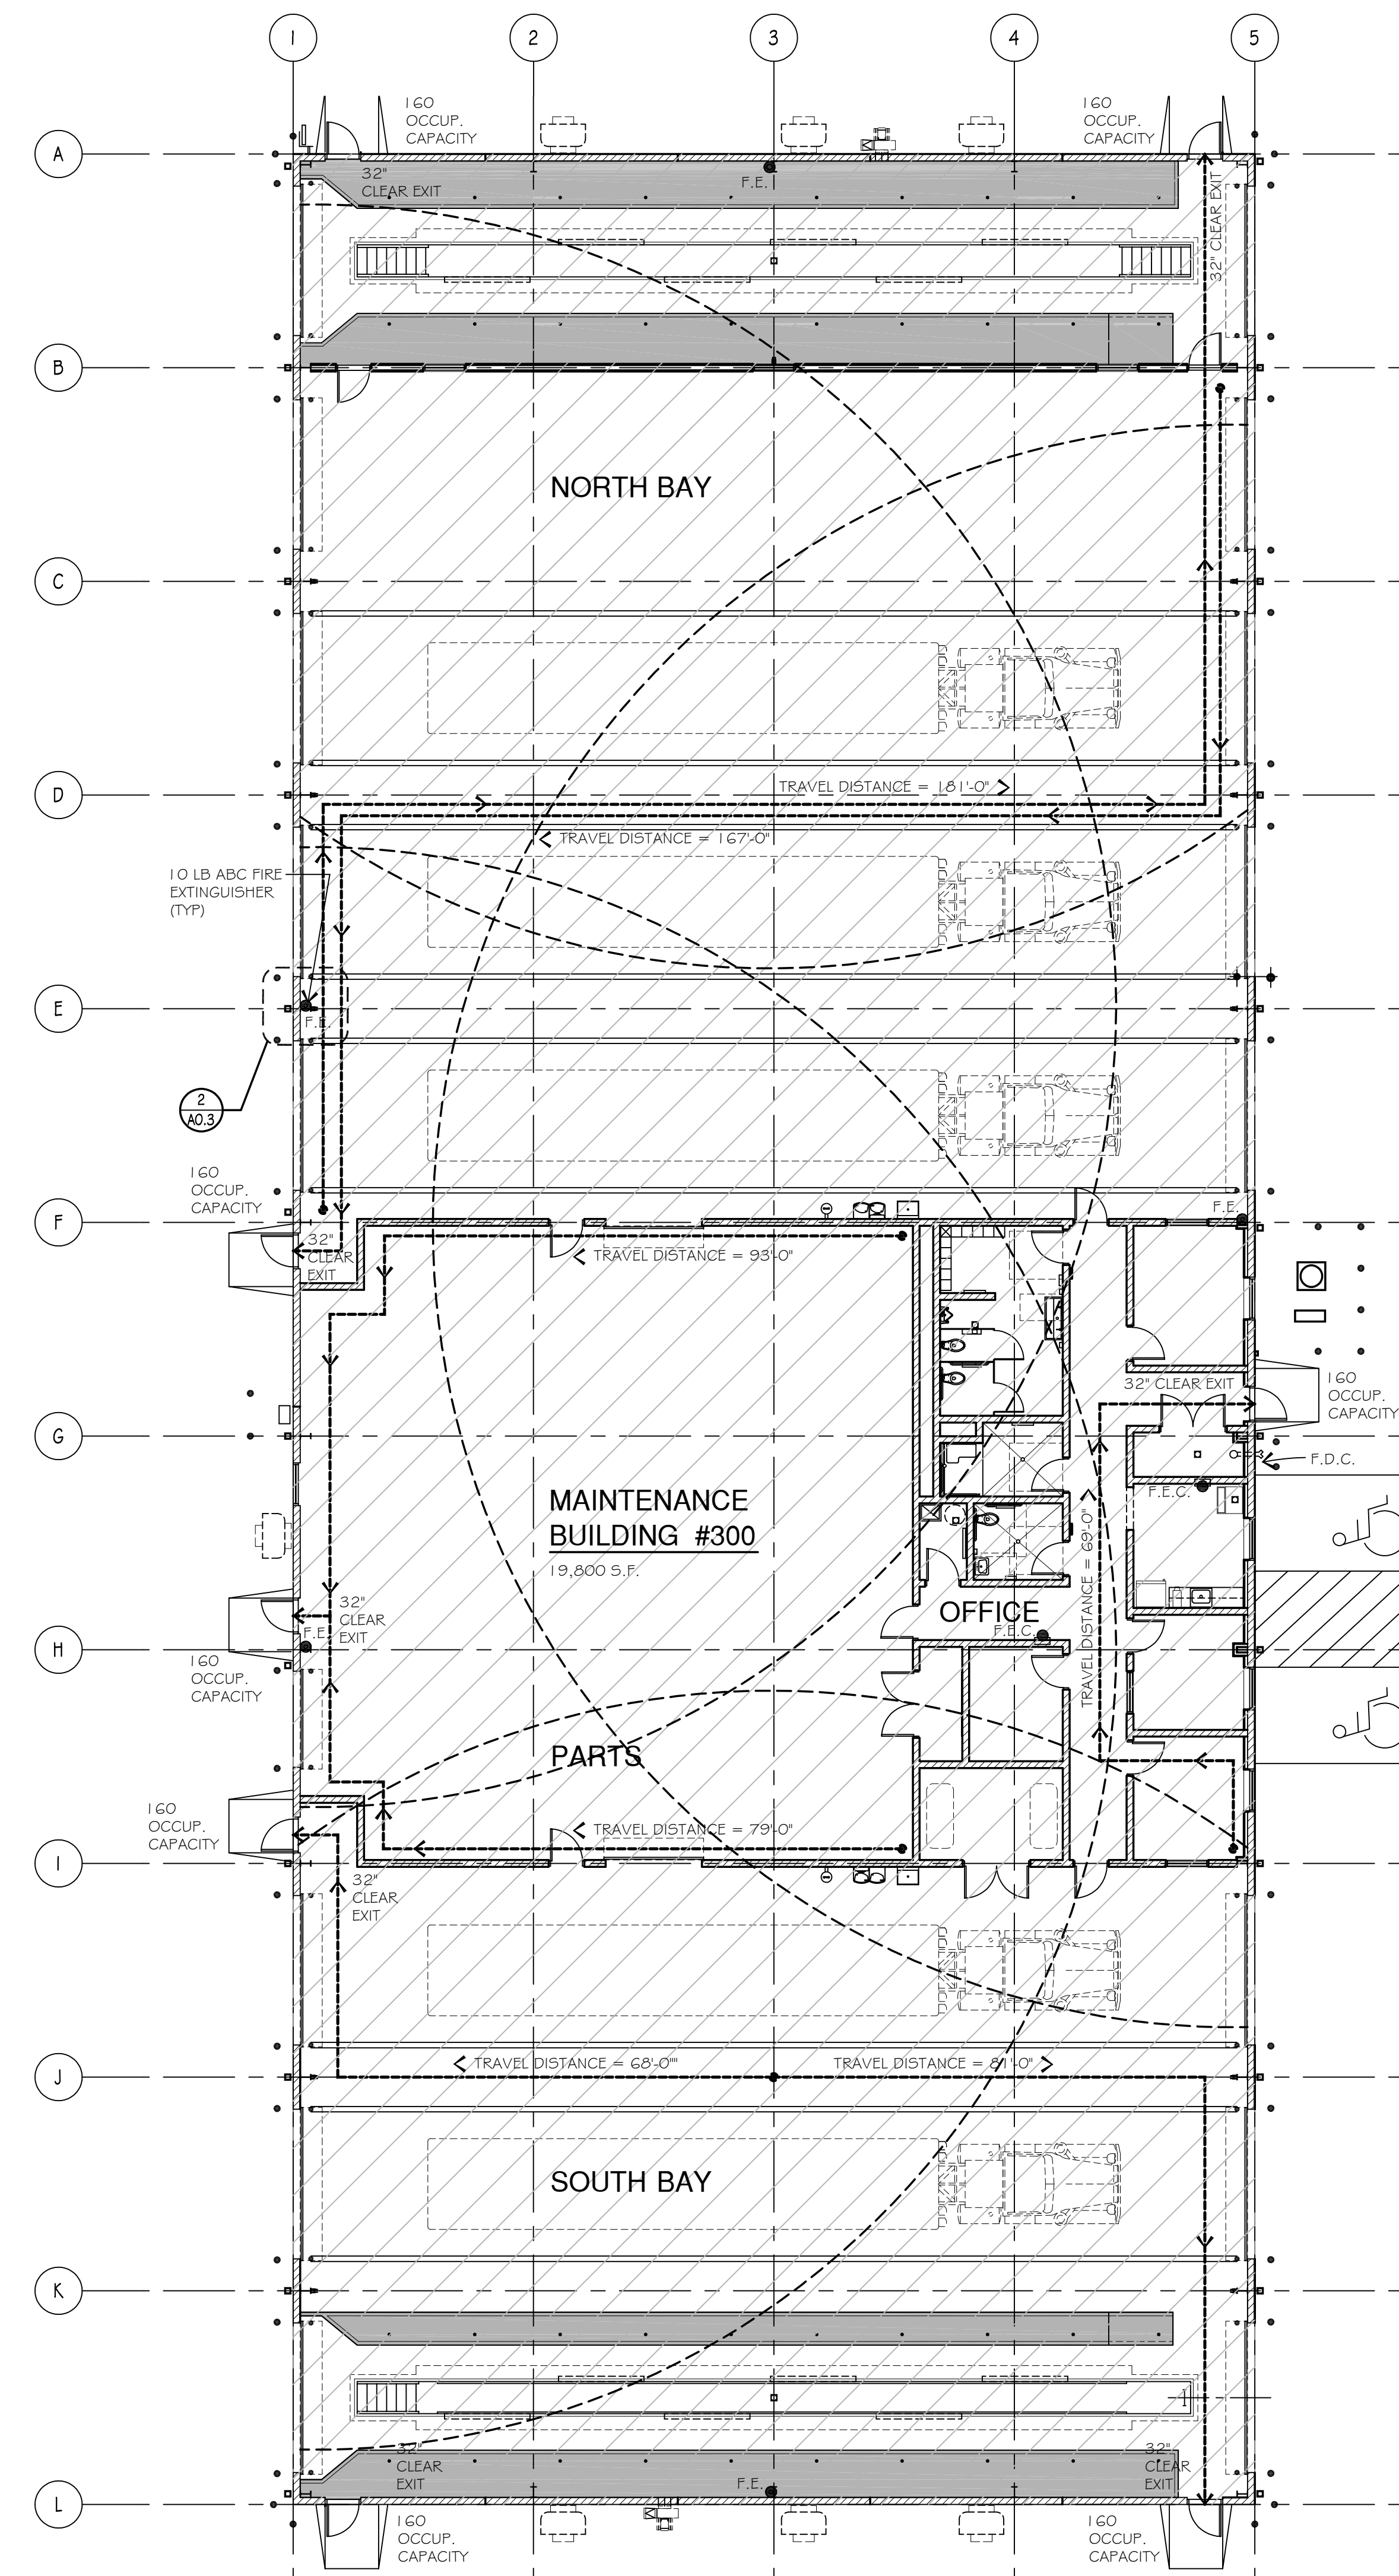

**MAINTENANCE BUILDING #300 LIFE SAFETY PLAN**  
SCALE: 3/32" = 1'-0"



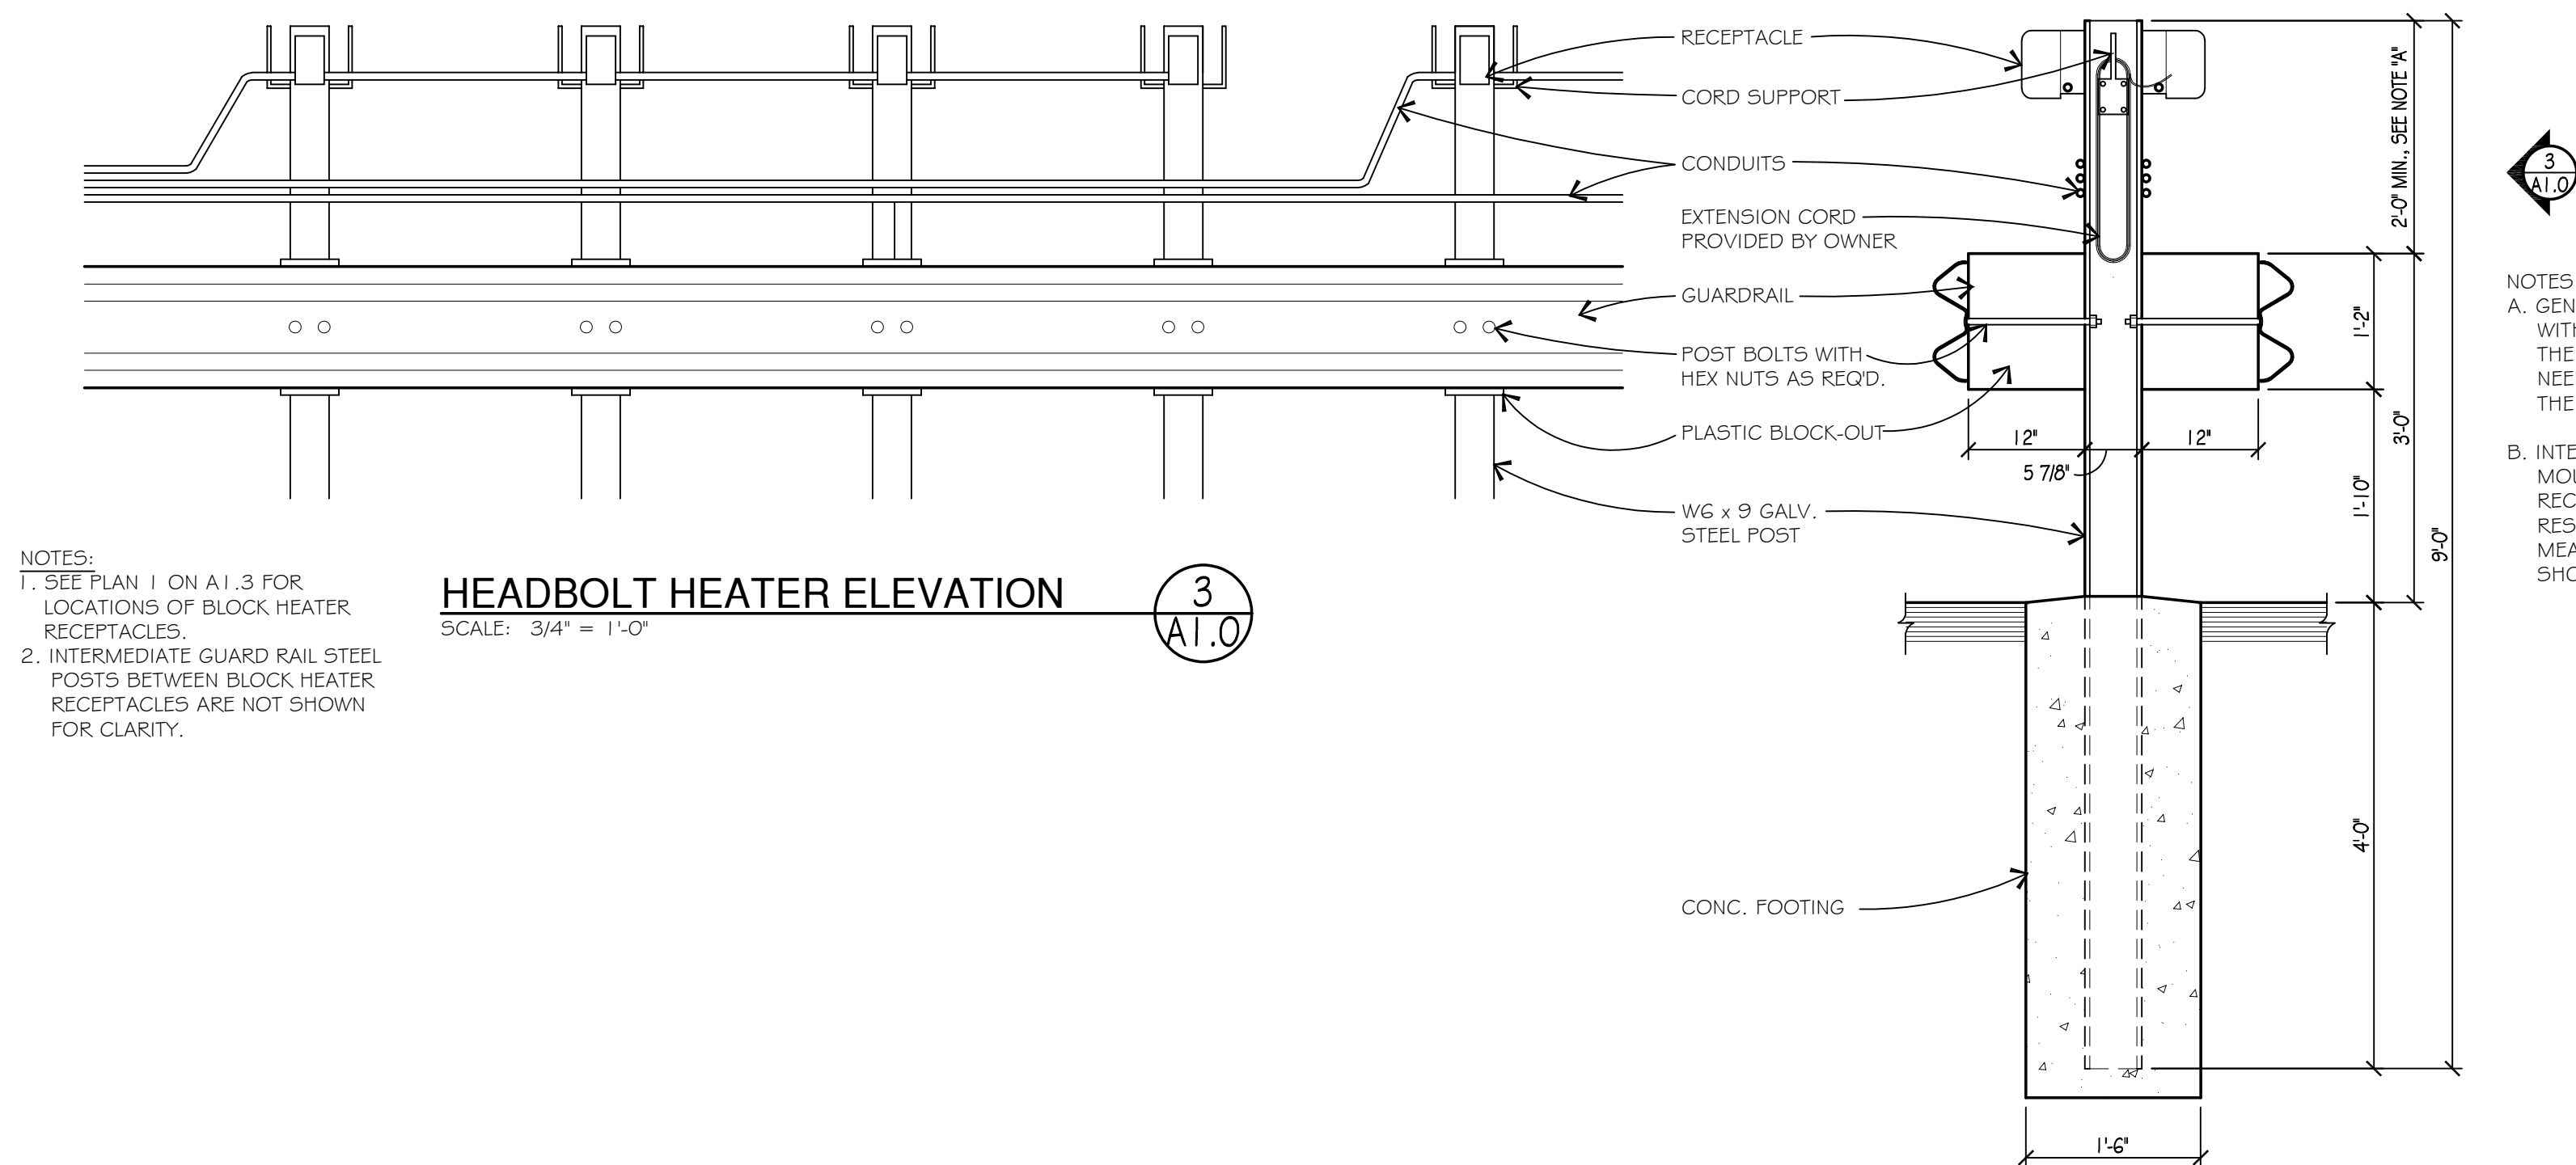

NOTES:  
1. SEE PLAN 1 ON A1.3 FOR LOCATIONS OF BLOCK HEATER RECEPTACLES.  
2. INTERMEDIATE GUARD RAIL STEEL POSTS BETWEEN BLOCK HEATER RECEPTACLES ARE NOT SHOWN FOR CLARITY.


**HEADBOLT HEATER ELEVATION**  
SCALE: 3/4" = 1'-0"

3  
A1.0

NOTES:  
A. GENERAL CONTRACTOR IS TO COORDINATE WITH ELECTRICAL CONTRACTOR TO VERIFY THE HEIGHT OF WIDE FLANGE POST NEEDED ABOVE THE GUARD RAIL TO RUN THE REQUIRED QUANTITY OF CONDUITS.  
B. INTENT OF DETAIL IS TO SHOW BASIC MOUNTING FOR HEADBOLT HEATER RECEPTACLE. GENERAL CONTRACTOR IS RESPONSIBLE FOR ACTUAL INSTALLATION, MEANS AND METHODS. INFORMATION SHOWN IS ONLY TO CONVEY INTENT.


**HEADBOLT HEATER RECEPTACLE**  
SCALE: 3/4" = 1'-0"

2  
A1.3

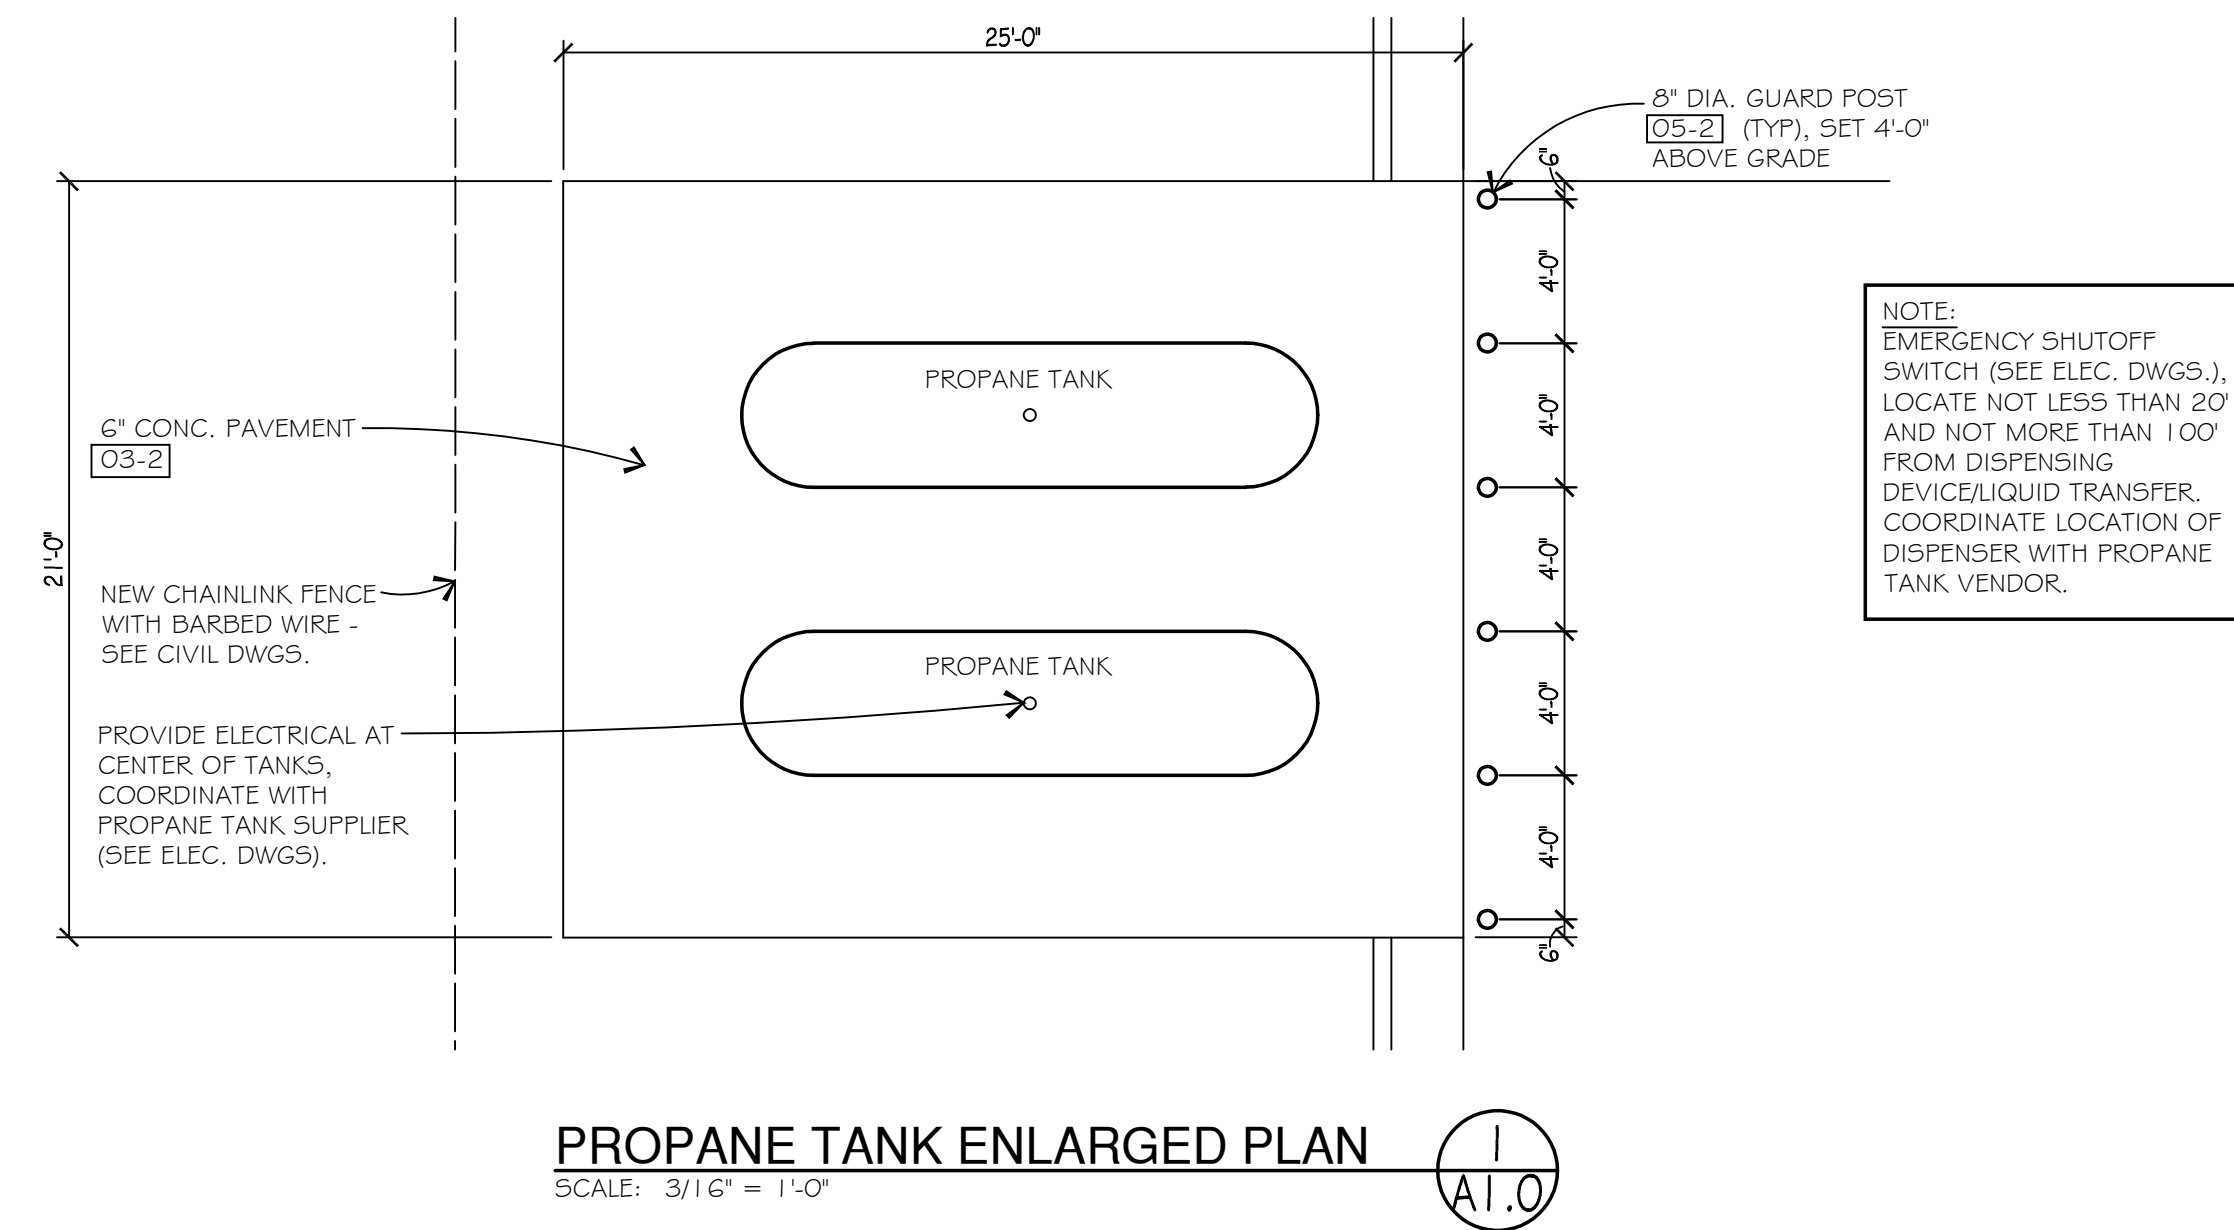


**PROPANE TANK ENLARGED PLAN**  
SCALE: 3/16" = 1'-0"

1  
A1.0

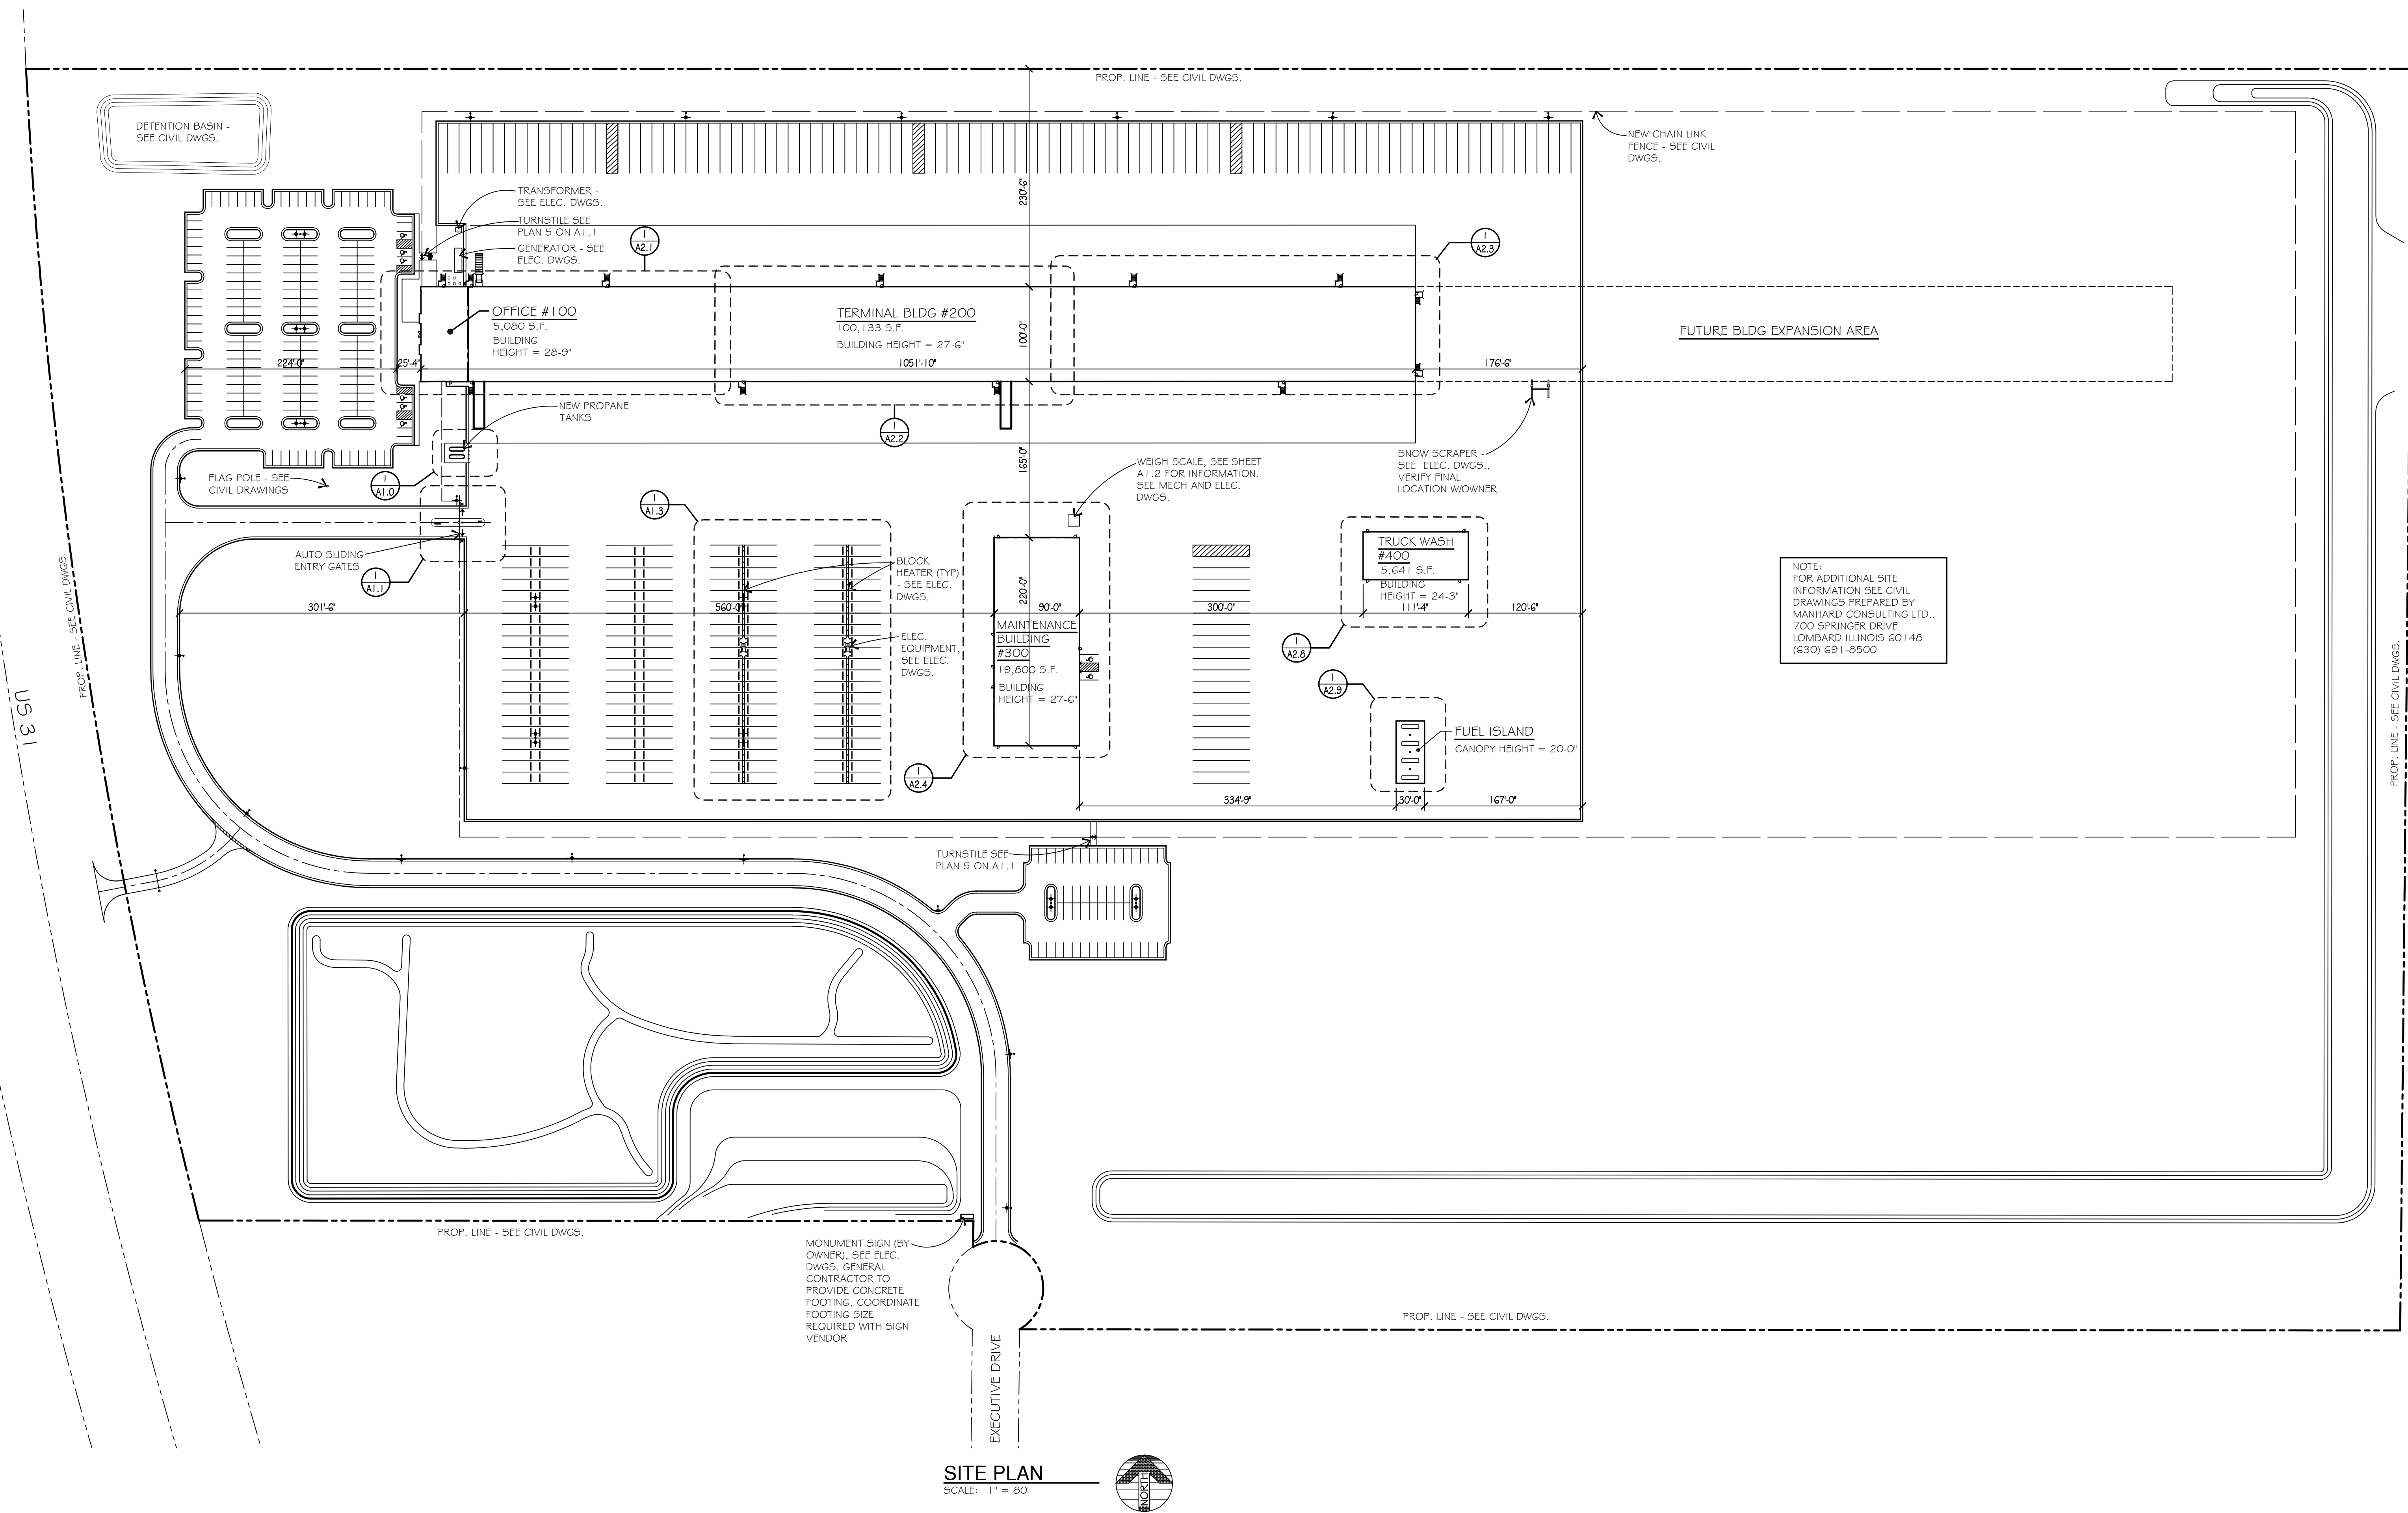


**SITE PLAN**  
SCALE: 1" = 80'




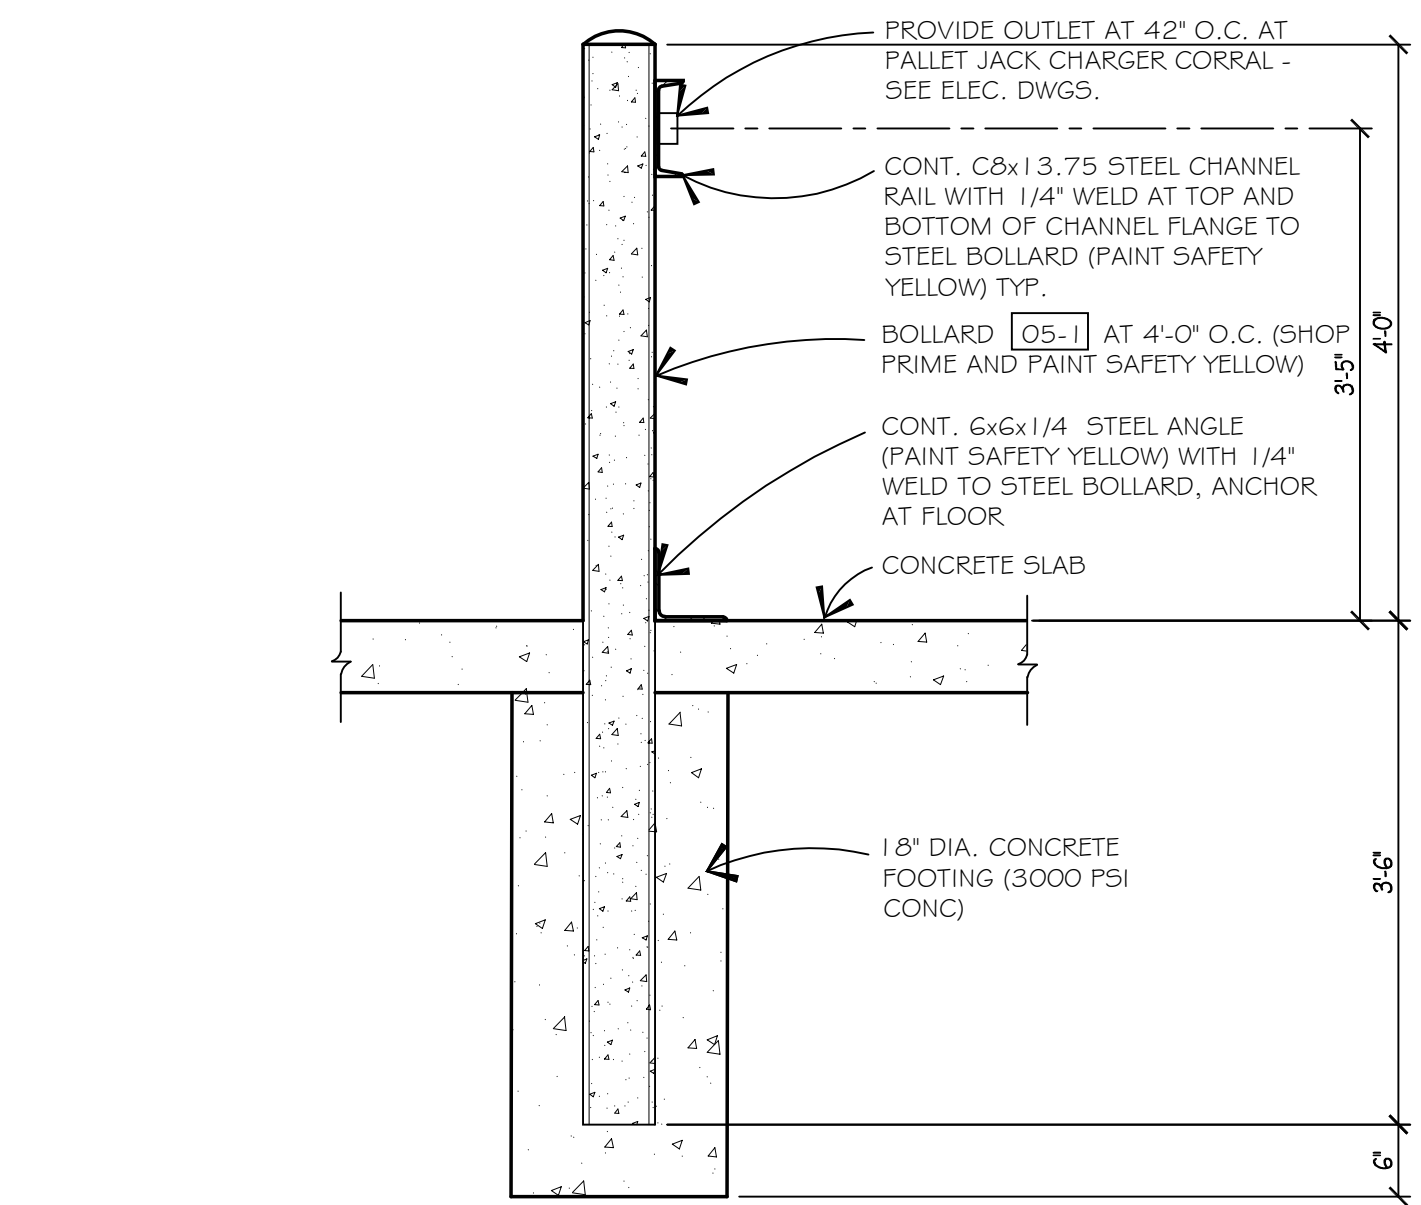


**BOLLARD DETAIL**  
SCALE: 3/4" = 1'-0"

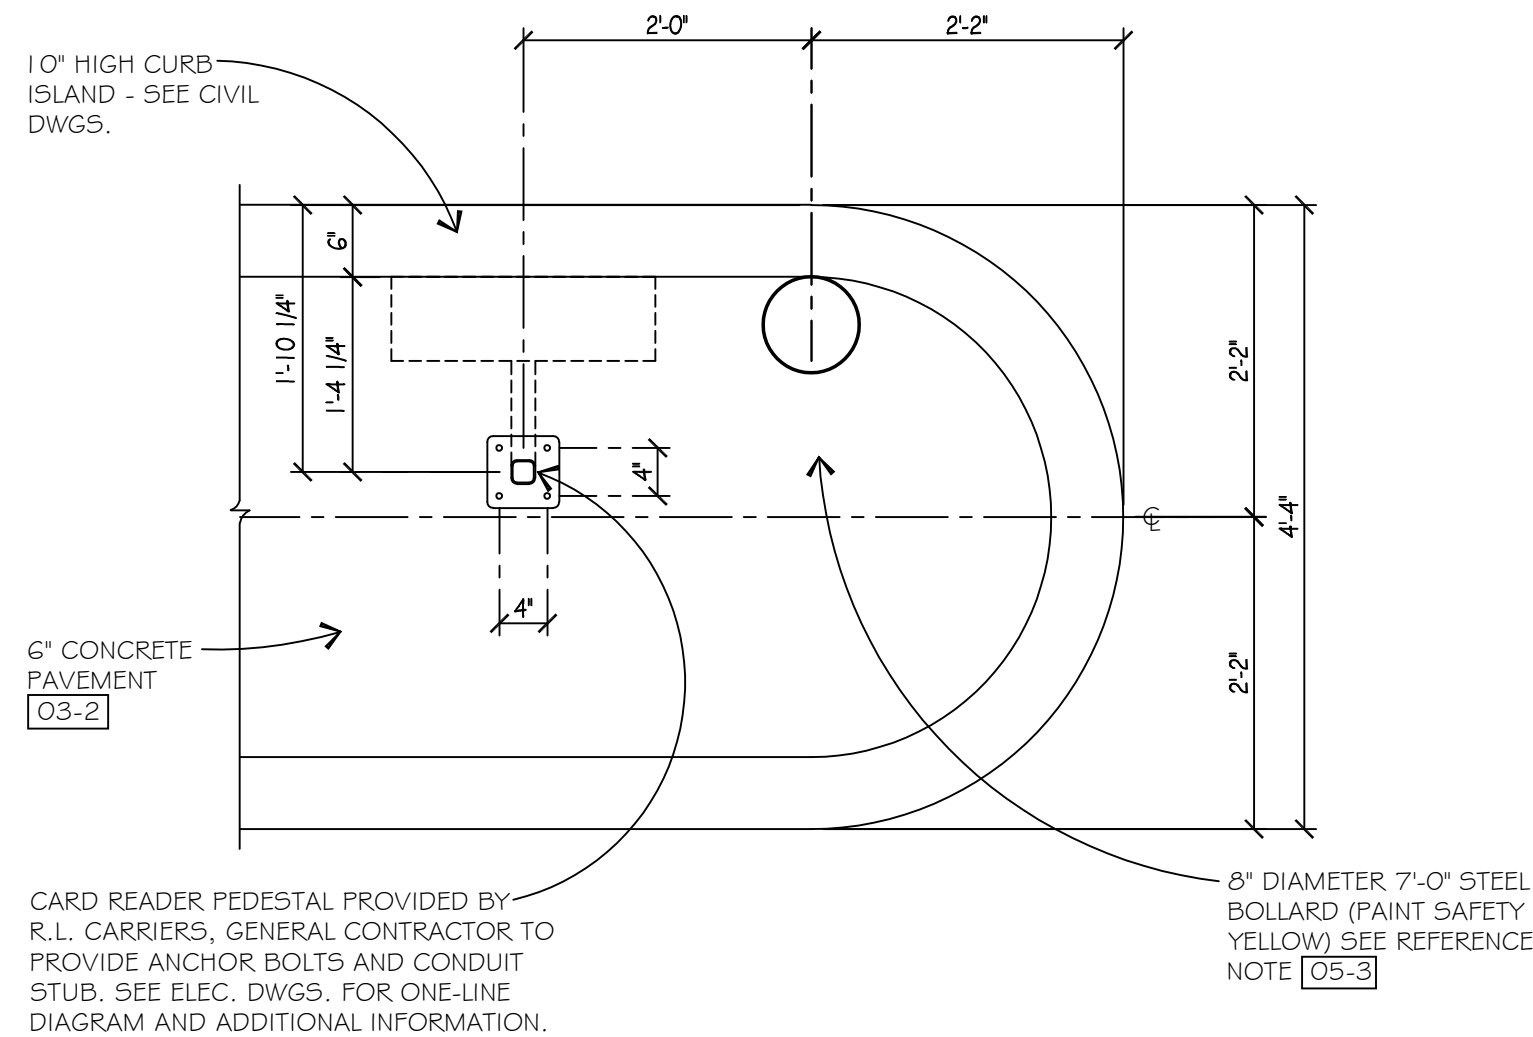


**PLAN**  
SCALE: 3/4" = 1'-0"

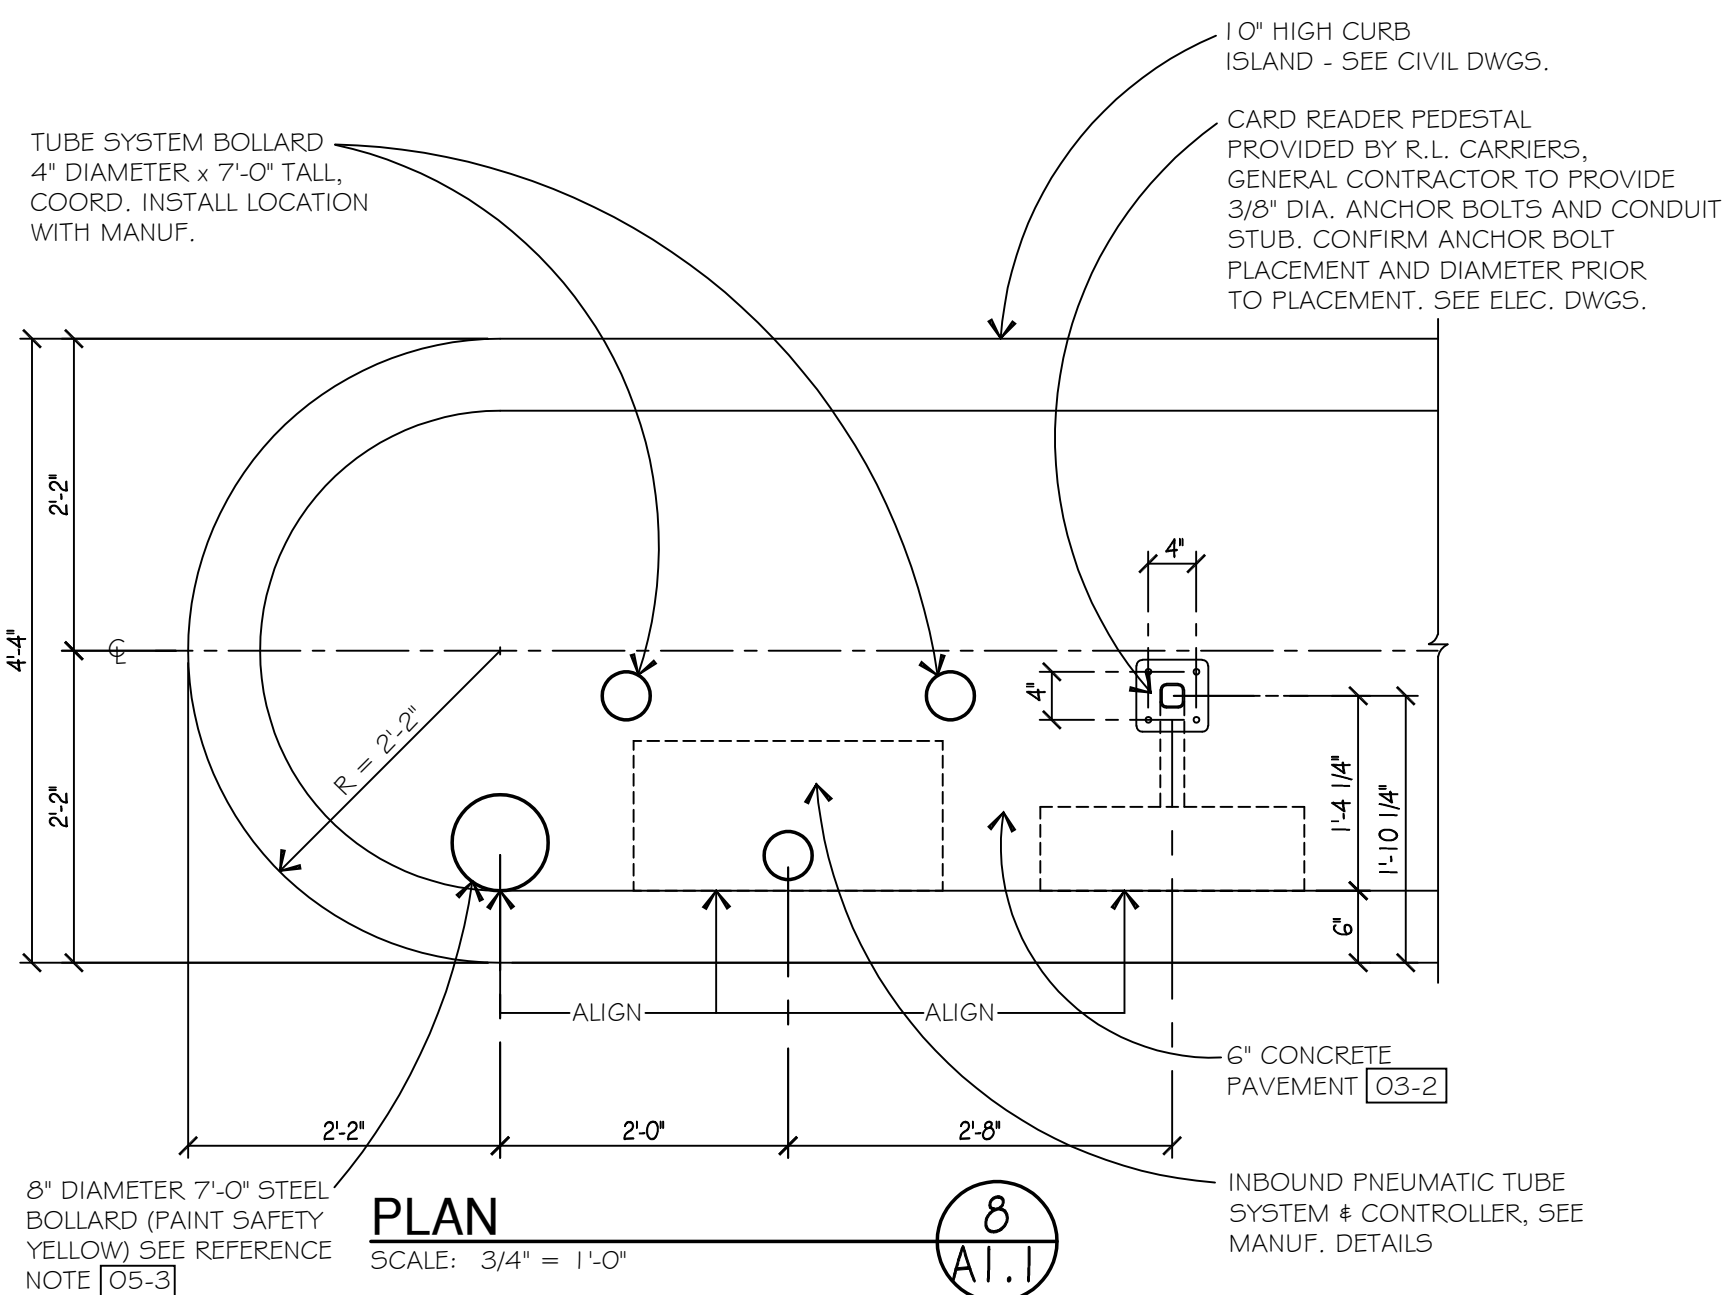


**PLAN**  
SCALE: 3/4" = 1'-0"

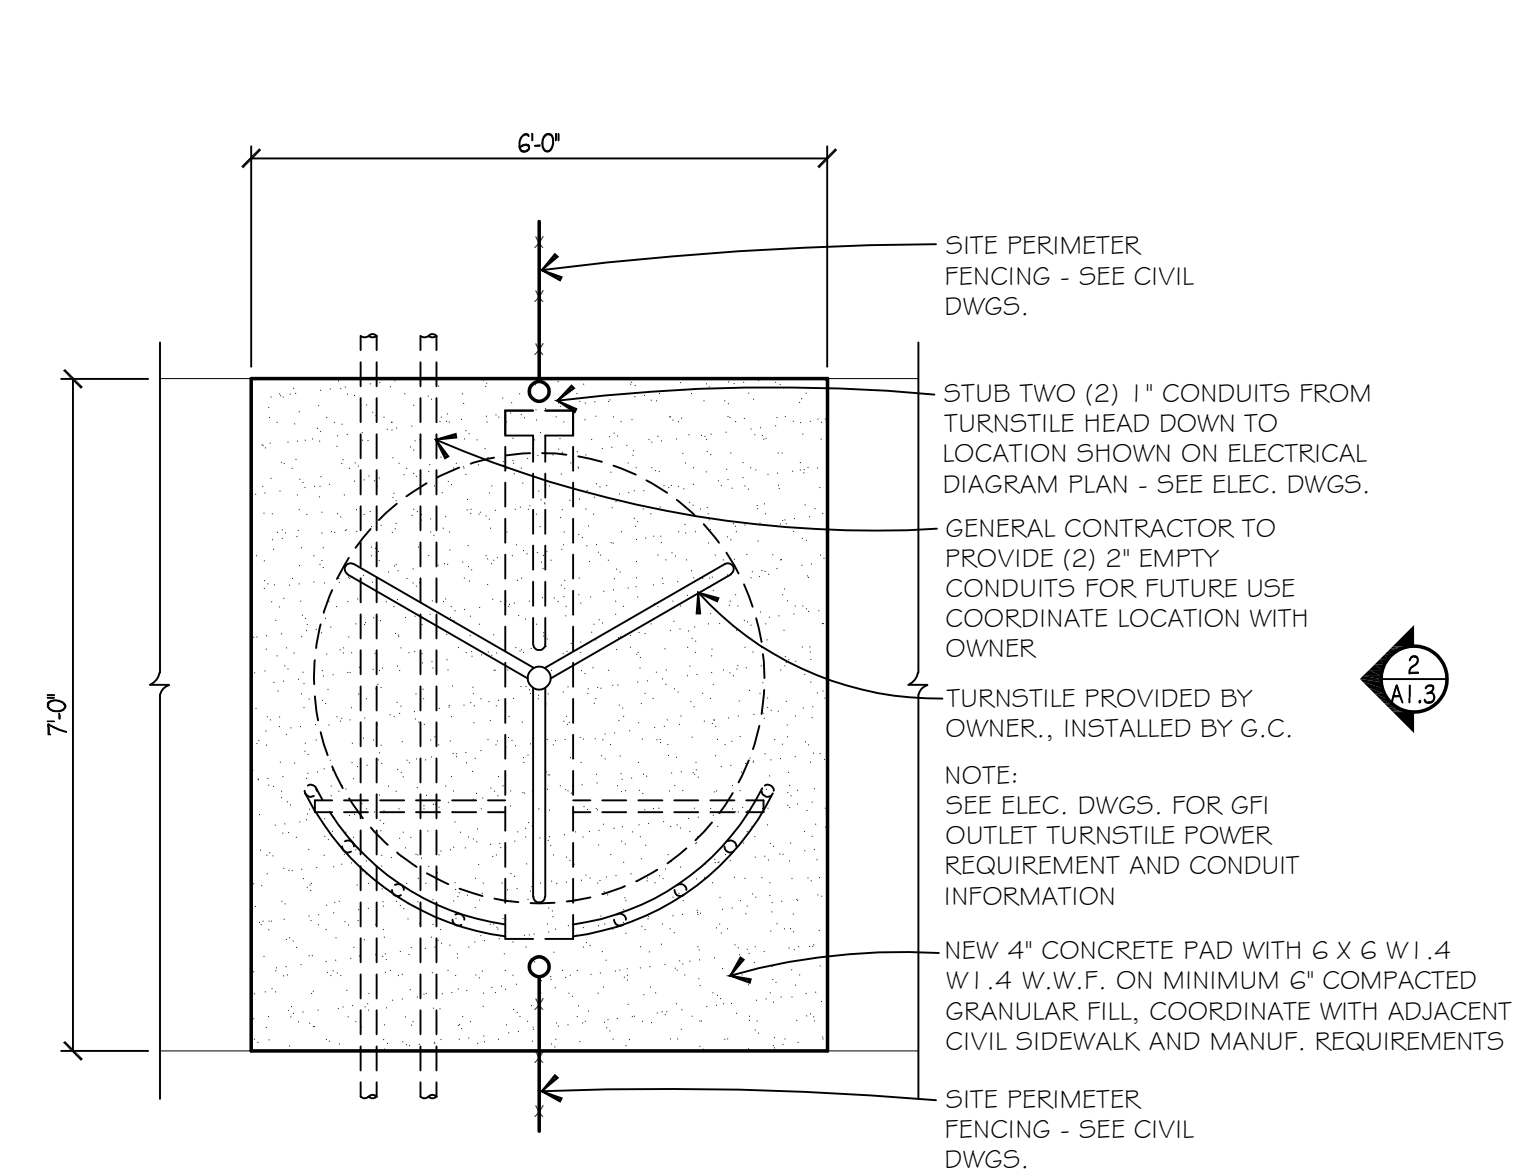


**TURNSTILE PAD PLAN**  
SCALE: 1/2" = 1'-0"

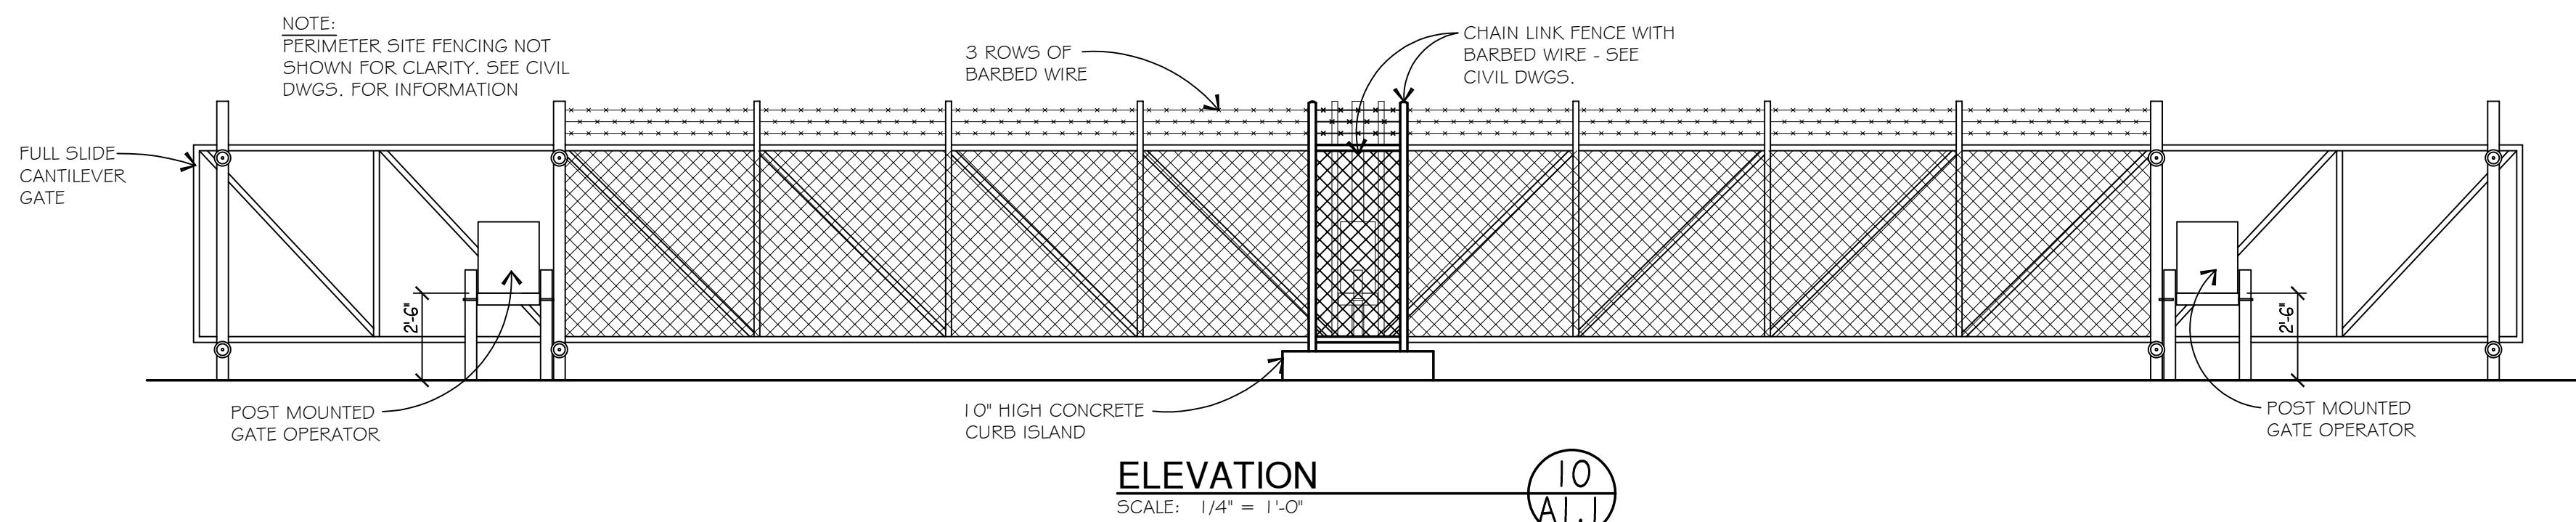


**ELEVATION**  
SCALE: 1/4" = 1'-0"

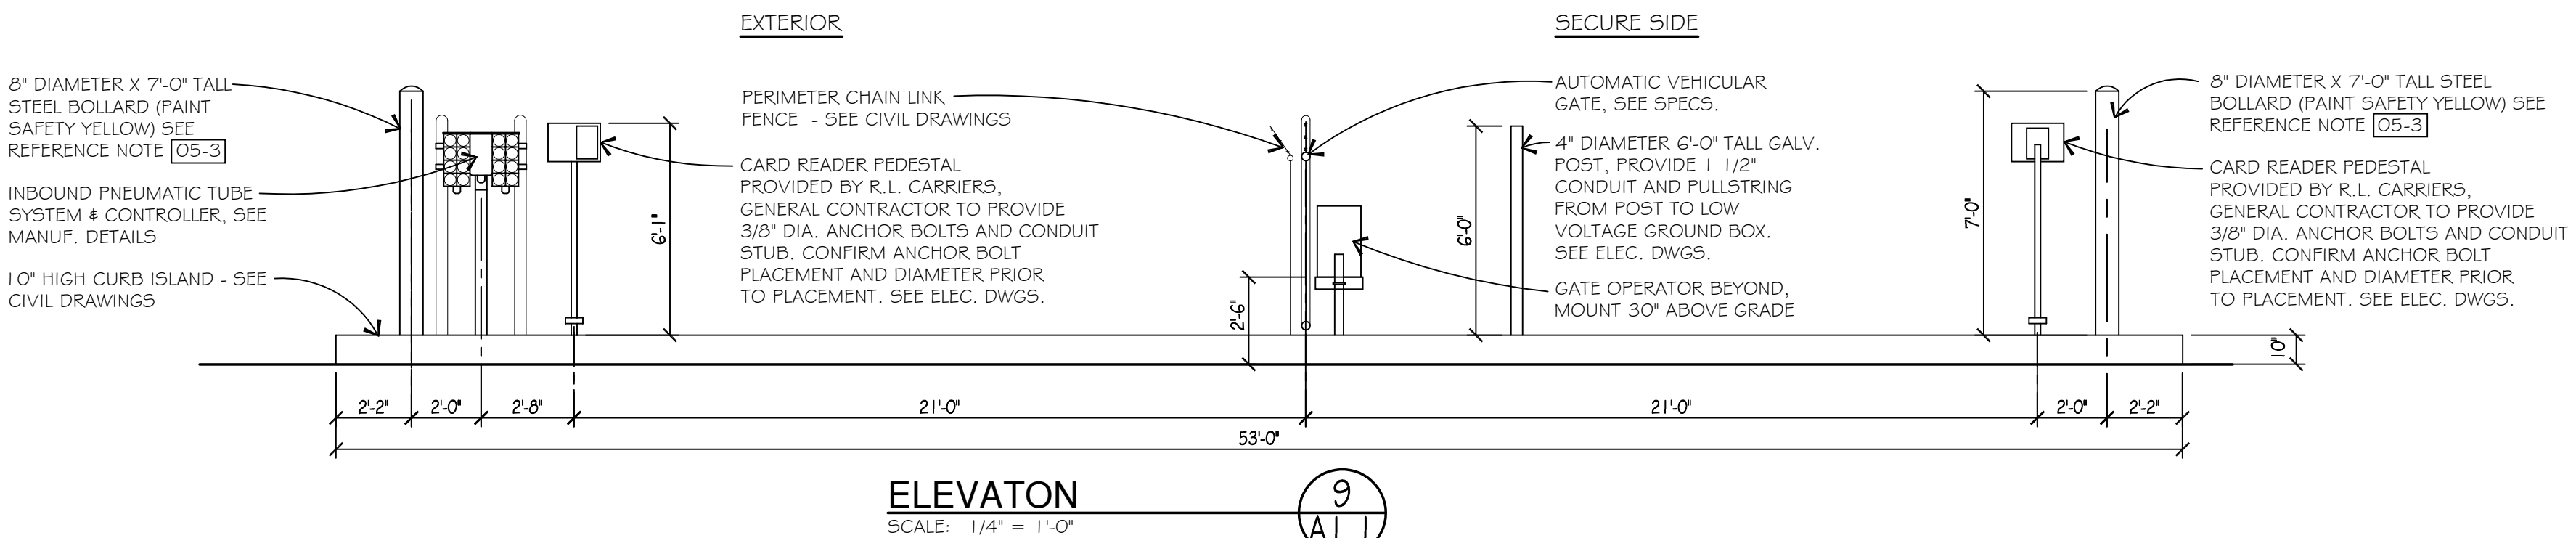


**ELEVATION**  
SCALE: 1/4" = 1'-0"

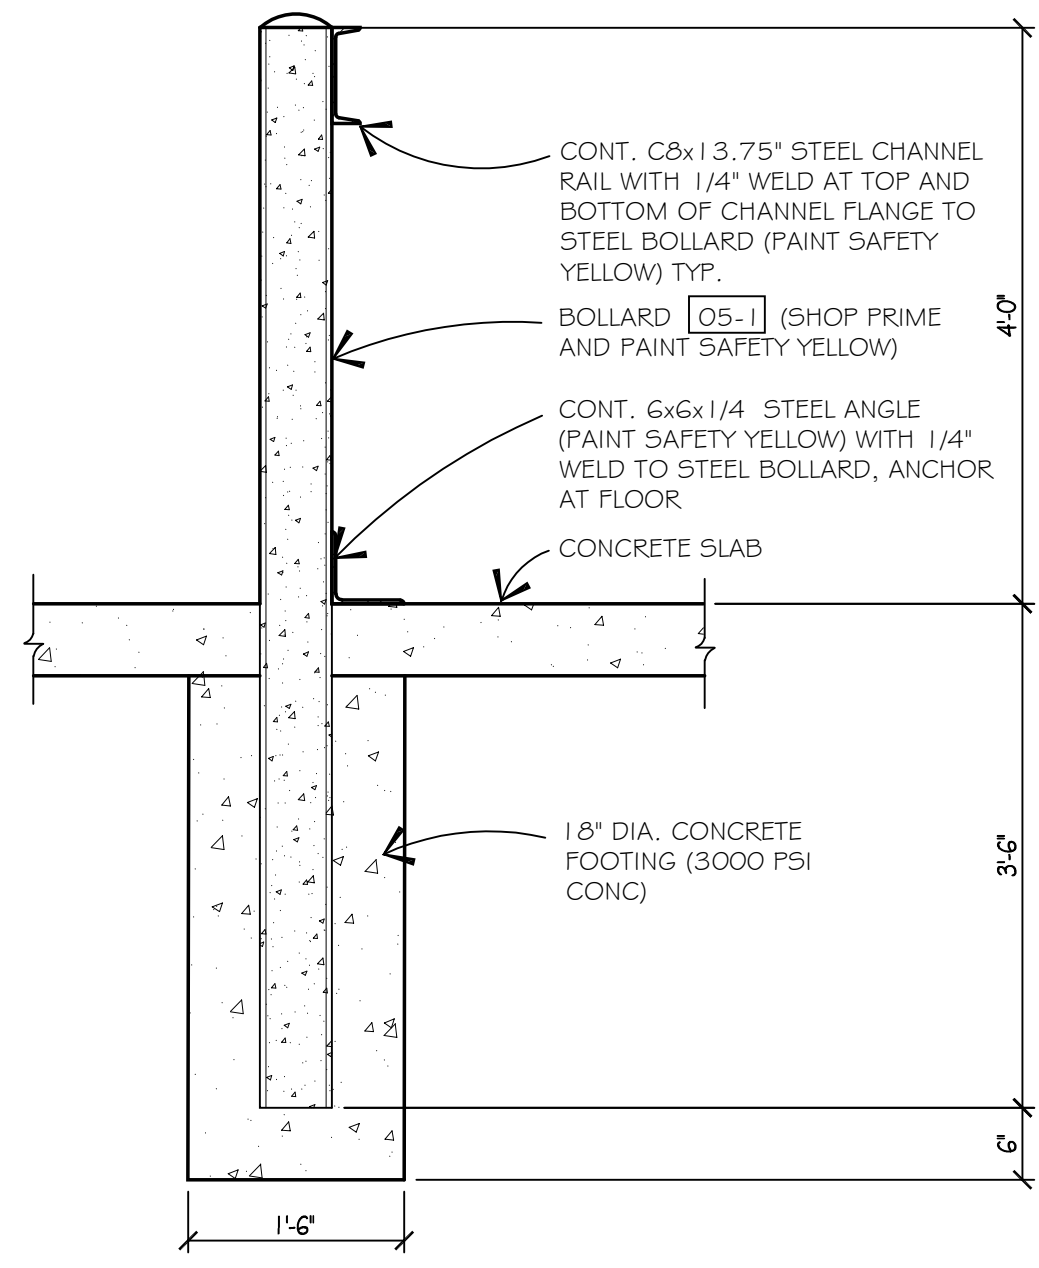


**BOLLARD DETAIL**  
SCALE: 3/4" = 1'-0"

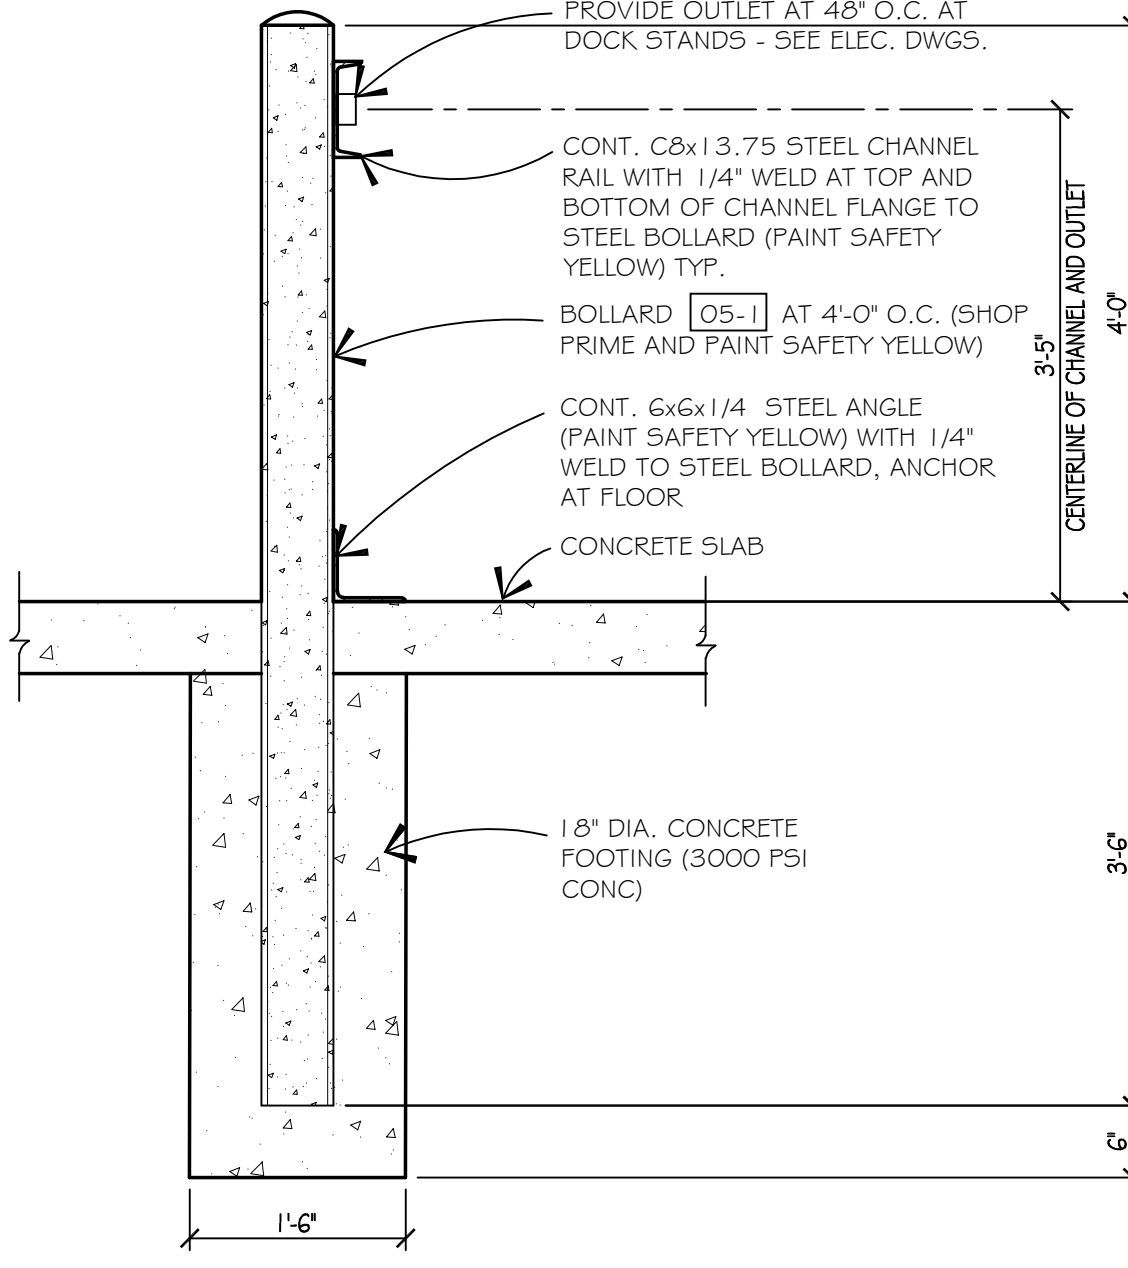


**BOLLARD DETAIL**  
SCALE: 3/4" = 1'-0"

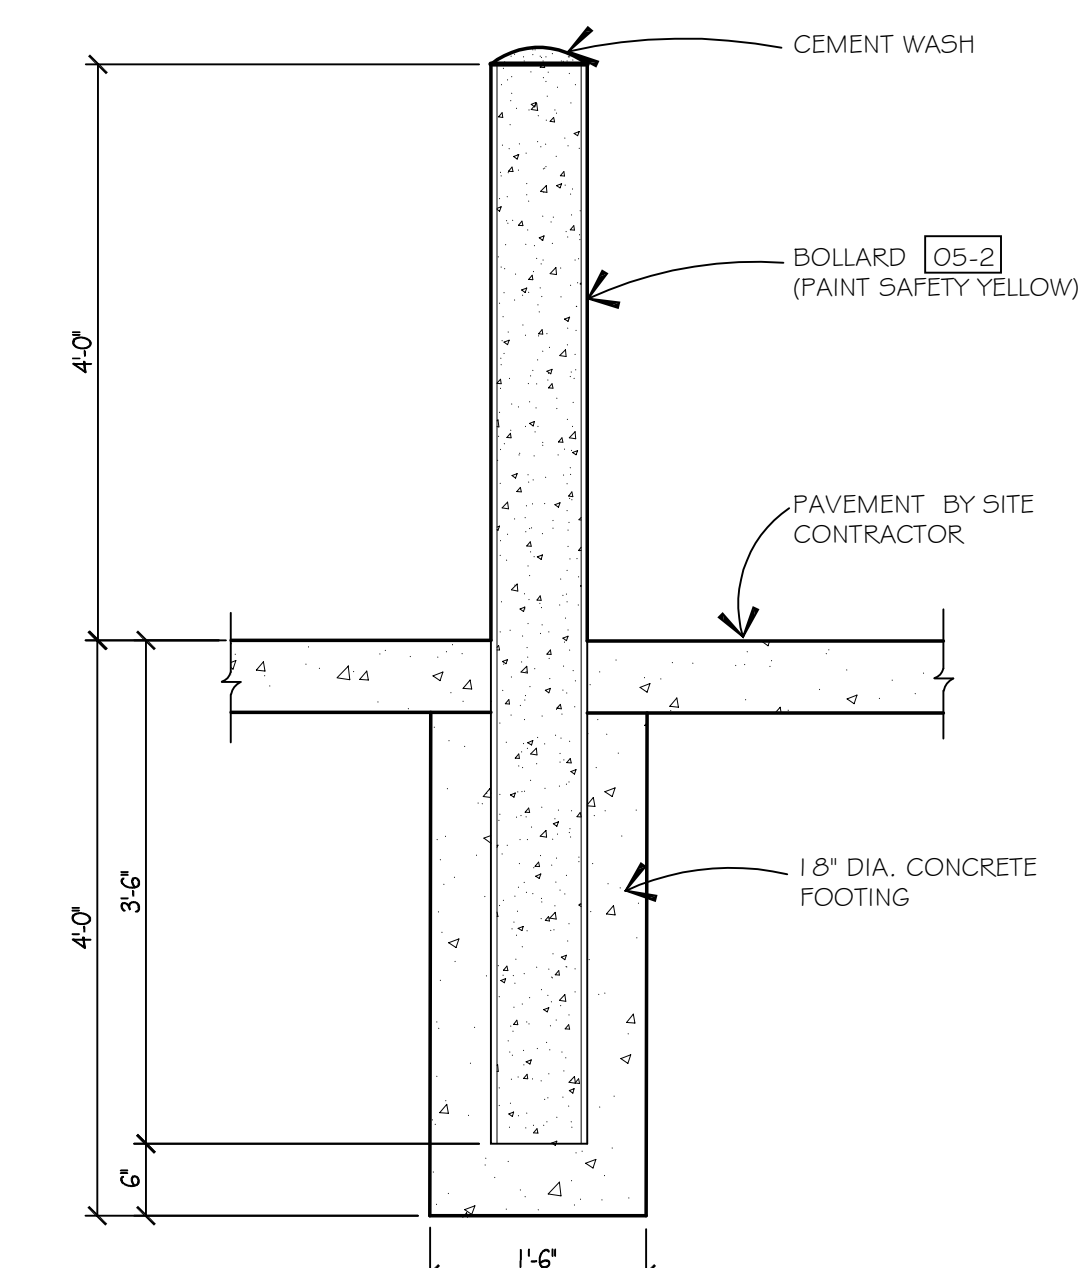


**BOLLARD DETAIL**  
SCALE: 3/4" = 1'-0"

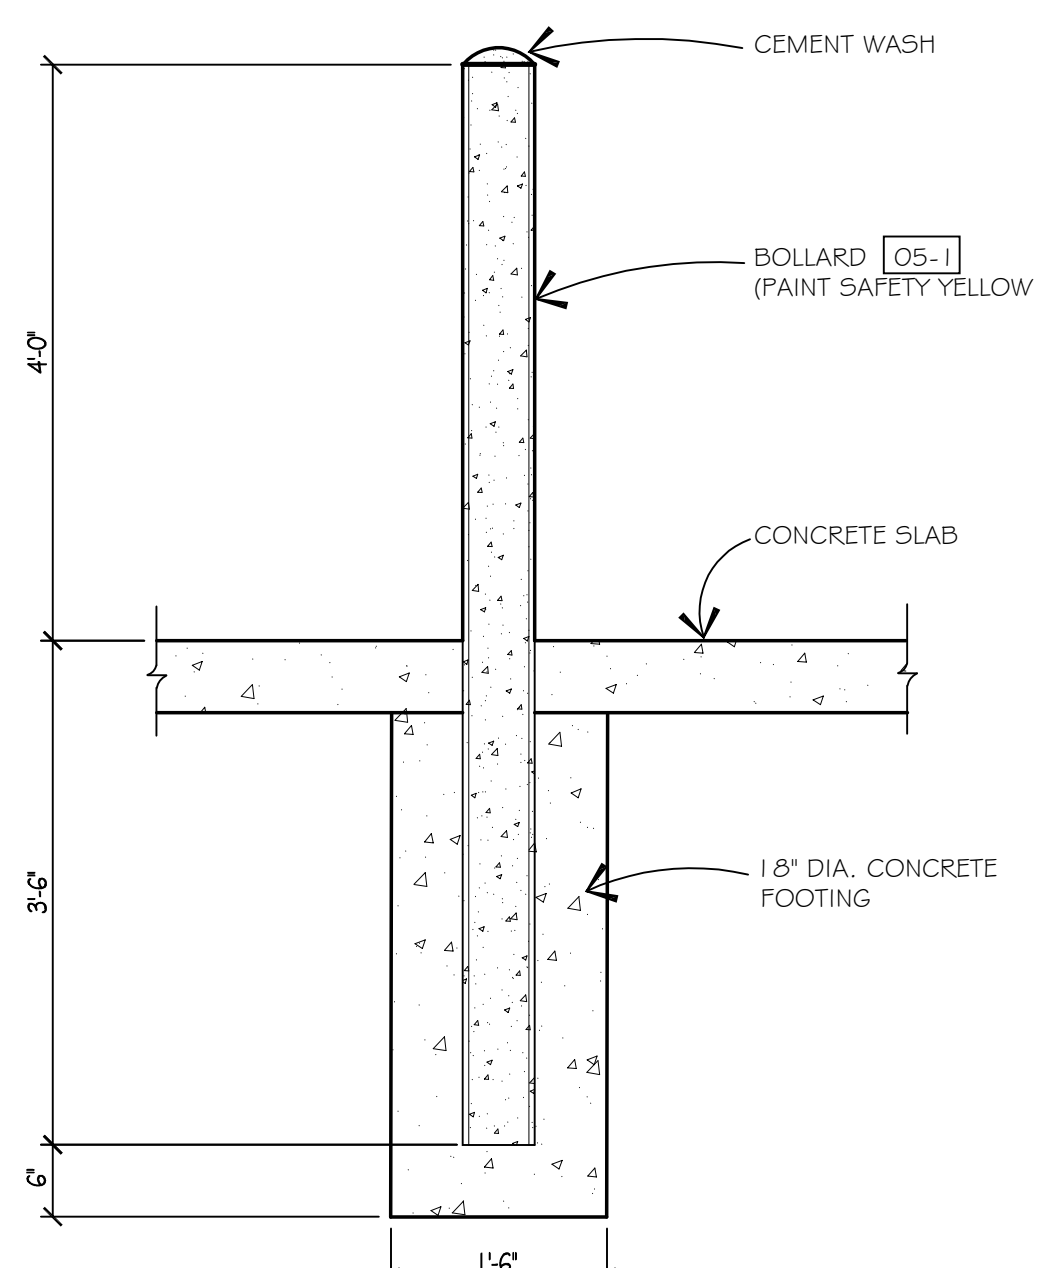

**BOLLARD DETAIL**  
SCALE: 3/4" = 1'-0"

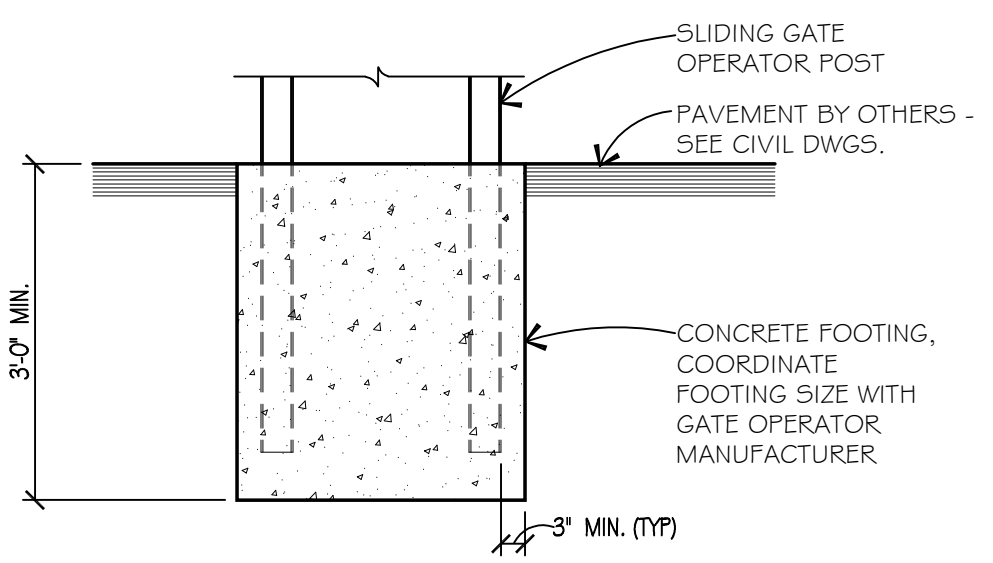

**GATE OPERATOR FOOTING DETAIL**  
SCALE: 1/2" = 1'-0"

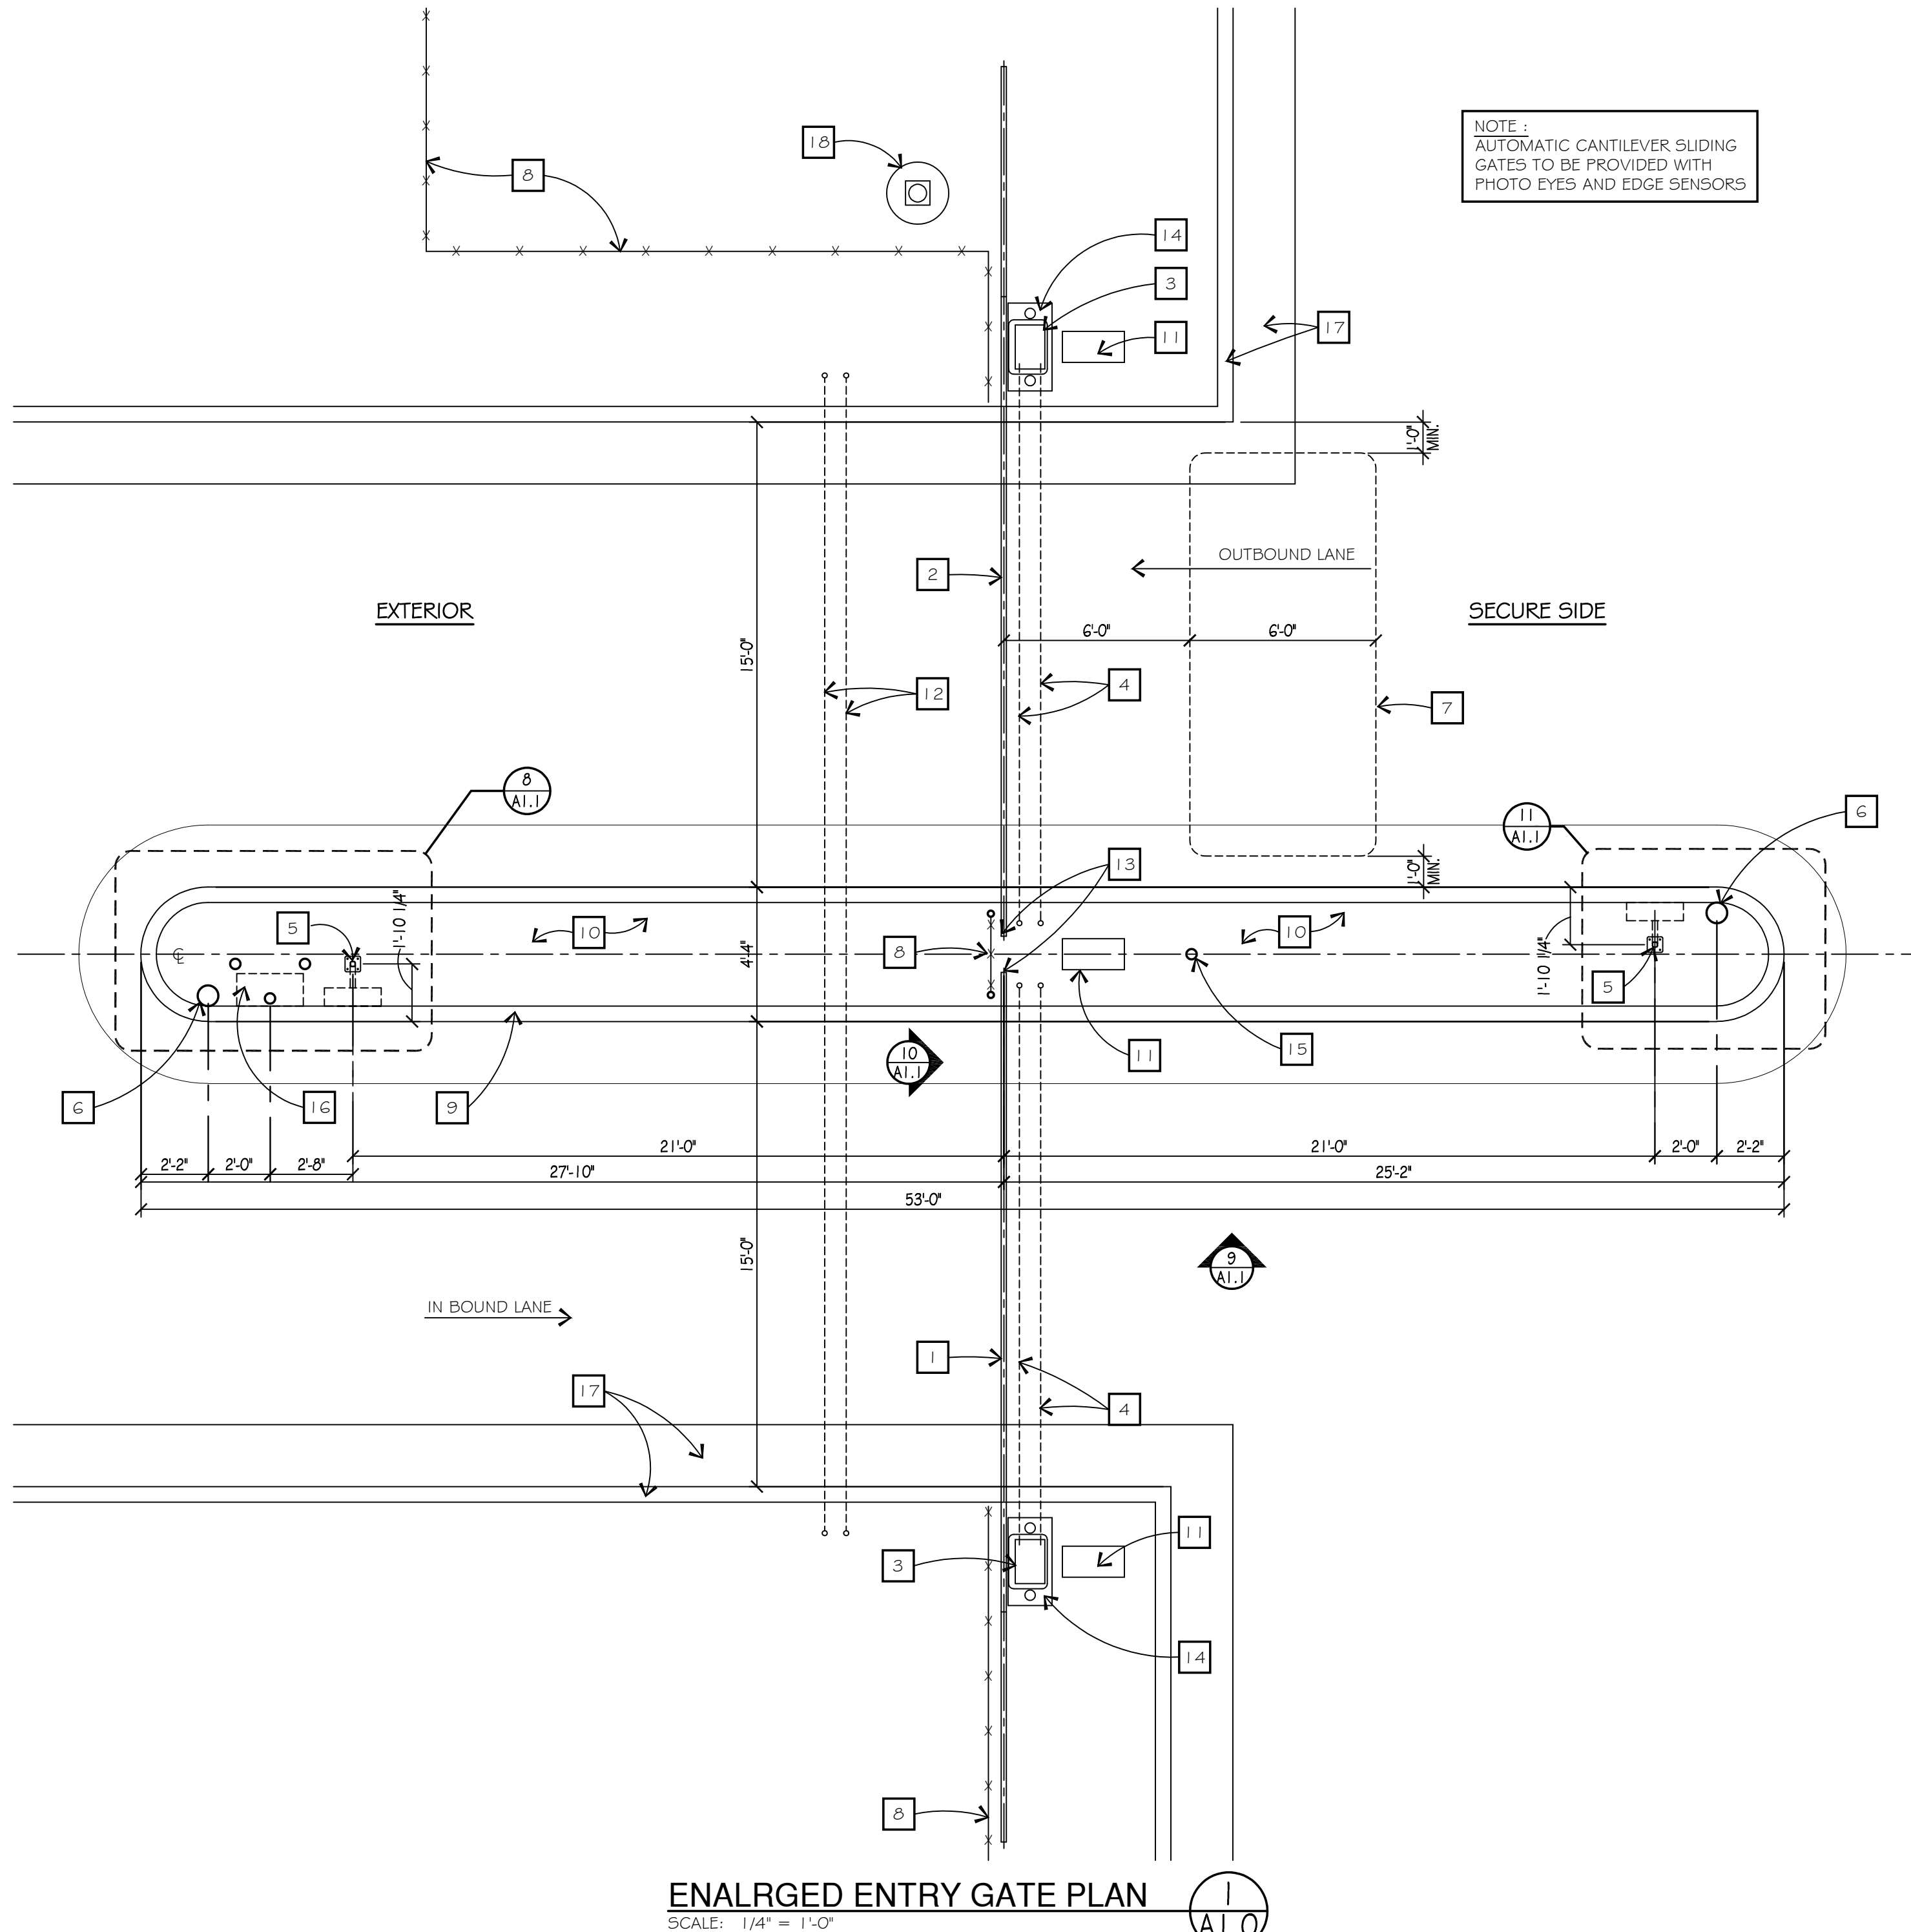

**ENLARGED ENTRY GATE PLAN**  
SCALE: 1/4" = 1'-0"

## ENTRY GATE PLAN KEY NOTES

- INBOUND FULL CANTILEVER SLIDING ENTRY GATE.
- OUTBOUND FULL CANTILEVER SLIDING ENTRY GATE.
- INBOUND AND OUTBOUND GATE OPERATOR, PROVIDE RAISED MOUNTING PLATE MOUNT AT 30" ABOVE GRADE PER MANUFACTURERS DETAILS. GROUND BOX AND CONDUIT STUBS PER MANUFACTURER. SEE ELECTRICAL DRAWINGS FOR ADDITIONAL INFORMATION. SEE DETAIL 2 ON A1.1 FOR OPERATOR FOOTING INFORMATION.
- (2) 1" CONDUITS AND PULL STRINGS FROM EACH GATE OPERATOR TO ENTRY ISLAND FOR PHOTO EYES. COORDINATE WITH GATE OPERATOR MANUFACTURER.
- CARD READER PEDESTAL PROVIDED BY R.L. CARRIERS, GENERAL CONTRACTOR TO PROVIDE ANCHOR BOLTS AND CONDUIT STUB. SEE DETAILS AND ELECTRICAL DRAWINGS FOR ONE-LINE DIAGRAM AND ADDITIONAL INFORMATION.
- 8" DIAMETER 7'-0" HIGH STEEL BOLLARD (PAINT SAFETY YELLOW) SEE REFERENCE NOTE [05-3].
- UNDER PAVEMENT EXIT LOOP, TIE TO OUTBOUND GATE OPERATOR. COORDINATE WITH MANUFACTURER.
- PERIMETER CHAINLINK FENCE WITH BARB WIRE - SEE CIVIL DWGS.
- 10" HIGH CURB ISLAND. SEE CIVIL DRAWINGS.
- 6" CONCRETE PAVEMENT [03-2].
- INGROUND JUNCTION BOX - SEE ELECTRICAL DRAWINGS.
- (2) 2" CONDUITS AND PULL STRING(S) - STUB 6" ABOVE GRADE.
- GENERAL CONTRACTOR TO PROVIDE AND INSTALL LATCH POST ASSEMBLY PER MANUFACTURES DETAILS.
- GATE OPERATOR CONCRETE FOOTING. SEE DETAIL 2 THIS SHEET.
- PROVIDE 4" DIAMETER GALVANIZED POST WITH CAP, 6'-0" TALL ABOVE FINISHED GRADE MINIMUM. PROVIDE 1-1/2" CONDUIT WITH PULL STRING FROM POST TO LOW VOLTAGE GROUND BOX. SEE ELECTRICAL DRAWINGS. VERIFY LOCATION OF POST WITH OWNER.
- INBOUND PNEUMATIC TUBE SYSTEM & CONTROLLER. SEE CIVIL DRAWINGS FOR TUBE SYSTEM INFORMATION AND MANUFACTURER DETAILS. GENERAL CONTRACTOR TO PROVIDE AND INSTALL COMPLETE PNEUMATIC TUBE SYSTEM AND SHALL COORDINATE ROUTING OF TUBE SYSTEM FROM ENTRY ISLAND UP INTO MAIN OFFICE FIRE RISER ROOM AND INTO DISPATCH ROOM. SEE SPECIFICATIONS FOR MANUFACTURER AND PRODUCT INFORMATION.
- CONCRETE CURB AND GUTTER. SEE CIVIL DRAWINGS.
- LIGHT POLE AND BASE, SEE CIVIL DRAWINGS.



MATERIAL REQUIREMENTS				
REBAR SCHEDULE				
BAL. NO.	QUANTITY	LENGTH (IN.)	DESCRIPTION	WEIGHT
A	56	114	# 5 @ 12 O.C.	555
B	40	162	# 5 @ 12 O.C.	561
C	56	52	# 5 @ 12 O.C.	253
D	20	162	# 5 @ 12 O.C.	282
E	30	170	# 5 @ 12 O.C.	443
F	30	162	# 5 @ 12 O.C.	422
G	16	34	# 5 @ 8 O.C.	47
H	16	24	# 5 @ 8 O.C.	33
J	16	25	# 5 @ 8 O.C.	35
K	48	52	# 5 @ 12 O.C.	217
L	12	138	# 5 @ 12 O.C.	144
TOTAL WEIGHT OF REBAR (LBS.)				2995
TOTAL LENGTH OF REBAR (FT.)				2871
CONCRETE SCHEDULE				
			VOLUME (CUBIC YARDS)	
APPROACHES			10.4	
FLOOR			7.6	
PIERS			2.0	
WALLS			9.1	
TOTAL			29.0	
MISC. STEEL				
PIT COPING	3 X 3 X 1/4		49 LN .FT	240 LBS

NOTES:





1. DESIGN STRESS:  
1.1) CONCRETE:  $f_c = 3000$  PSI @ 28 DAYS, MAXIMUM SLUMP 4".  
1.2) REINFORCING STEEL: DEFORMED BARS ASTM A615 GRADE 60, UNLESS OTHERWISE NOTED.  
1.3) STEEL: STRUCTURAL ASTM A36
2. CONTRACTOR NOTE:  
2.1) STRUCTURAL CONCRETE MEMBERS ARE DESIGNED FOR "IN PLACE" LOADS. CONTRACTOR IS RESPONSIBLE FOR BRACING ALL STRUCTURAL ELEMENTS (AS REQUIRED AT ANY STAGE OF CONSTRUCTION) UNTIL COMPLETION OF THIS PROJECT. CONTRACTOR SHALL BE RESPONSIBLE TO ARCHITECT/ENGINEER FOR APPROVAL (3 SETS REQUIRED).  
2.2) REMOVE STATES REQUIRE CONCRETE CLEANOUTS. CHECK WITH STATE AND LOCAL CODES PRIOR PROCEEDING WITH CONSTRUCTION.  
2.3) MONOLITHIC POUR OF SLAB AND PIERS IS ALLOWED. AT CONTRACTORS DISCRETION.  
2.4) STATE AND LOCAL AGENCIES MAY HAVE VARIOUS REQUIREMENTS FOR BRACING RAMP, BRACING AND SHORING AT ALL STAGES OF CONSTRUCTION. PLEASE CHECK WITH ALL AGENCIES PRIOR TO CONSTRUCTION.

## DIVISION 2

3. SITE PREPARATION:
- 3.1) FOOTINGS SHALL BEAR ON NATURAL UNDISTURBED SOIL OR ENGINEERED FILL.
- 3.2) DEVELOP AND MAINTAIN SITE GRADES WHICH WILL RAPIDLY DRAIN SURFACE AND ROOF RUN-OFF AWAY FROM FOUNDATION.
- 3.3) ALL FILL SHALL BE COMPACTED TO 95 - 98 PERCENT OF STANDARD PROCTOR DENSITY (ASTM D 1557).
- 3.4) FOOTINGS HAVE BEEN DESIGNED FOR A MINIMUM SOIL PRESSURE OF 3000 PSF IN LIEU OF SOIL BORINGS. IT WILL BE THE RESPONSIBILITY OF OTHERS TO VERIFY THIS VALUE.

### DIVISION 3

4. CONCRETE:
- 4.1) CODE FOR REINFORCED CONCRETE ACI 318 LATEST EDITION.
- 4.2) WHERE REINFORCING BARS ARE SHOWN AS CONTINUOUS, LAP SPICE BARS 40 DIAMETERS.
- 4.3) NOT SHOWN OTHERWISE, PROVIDE 2" CONCRETE COVER ON ALL REINFORCING STEEL (3" AT FOOTING/PIERS).
- 4.4) PROVIDE SUITABLE SUPPORT OF ALL REINFORCING TO PREVENT DISPLACEMENT DURING CONCRETING.
- 4.5) ALL CONCRETE TO HAVE 5-8% AIR ENTRAINMENT BY VOLUME.
- 4.6) CONCRETE SHOULD NOT CONTAIN FLY ASH.
- 4.7) PORTLAND CEMENT: ASTM C150, TYPE I; AGGREGATE - 3/4".
- 4.8) ALL ACID, CORROSIVE, VOLATILE AND HIGHLY DELETERIOUS AMOUNTS OF ACIDS, ALKALINES AND ORGANIC MATERIALS.
- 4.9) CONCRETE SHALL BE MAINTAINED ABOVE SEOF, AND IN A MOIST CONDITION FOR AT LEAST 7 DAYS AFTER PLACEMENT. DAYS FOR HIGH-EARLY STRENGTH CONCRETE HOT AND COLD WEATHER PROTECTION ASTM C-94.
- 4.10) THE CONCRETE SUPPLIER OR HIS REPRESENTATIVE SHALL TAKE A SET OF 3 CYLINDERS FOR EACH 100 CYCLES OF CONCRETE Poured OR A MINIMUM OF ONE SET PER ANY ONE POUR. THE CYLINDERS WILL BE MARKED WITH THE LOCATION OF WHERE THEY WERE TAKEN, THE NUMBER OF THE TRUCK THAT HAULED THE CONCRETE AND THE DATE AND TIME THE CYLINDERS WERE TAKEN.
- 4.11) CYLINDERS ARE NOT TO BE TAKEN FROM THE CONCRETE FACIES BY C-31, C-39 AND C172 USING APPROVED CYLINDER FORMS.
- 4.12) THE OWNER SHALL BE RESPONSIBLE FOR STORING THE CYLINDERS AND KEEPING THEM IN GOOD CONDITION.
- 4.13) THE OWNER SHALL HAVE ONE CYLINDER FOR EACH SET BROKE AT 7 DAYS AND A SECOND CYLINDER OF EACH SET BROKE AT 28 DAYS BY AN APPROVED TESTING COMPANY. THE THIRD CYLINDER OF EACH SET SHALL BE RETAINED AT THE SITE.
- 4.14) THE OWNER OR OWNER'S REP SHALL RECEIVE WRITTEN COPIES OF THE TESTING REPORTS AND PROVIDE THEM TO THE MANUFACTURER AT THEIR REQUEST.
- 4.15) CONTRACTOR MUST SUPPLY CONCRETE DESIGN MIX TO OWNER OR OWNER'S REP FOR APPROVAL PRIOR TO START OF CONSTRUCTION.
5. SLAB TO BE LEVEL WITHIN 1/4".
6. APPROACHES TO BE A COMMON PLANE WITHIN 1/4".
7. ALL ANCHORS TO BE EAS-ANCHOR TO BE INSTALLED AFTER FOUNDATION HAS CURED.
8. PROVISIONS FOR PROPER DRAINAGE OF PUMP MUST BE MADE. LOCATION OF ELECTRICAL FOR SUMP PUMP, AND ROD AND SUMP PUMP DICTATED BY SITE LOCATION AND/OR OWNER/BUILDER.
9. CONDUIT FOR HOMERUN CABLE/CABLES MUST BE POSITIONED AS SHOWN TO ALLOW ACCESS TO ALL CABLES WITHOUT THE NEED TO CUT THROUGH FOUNDATION WALLS.
10. 3/4" CONDUIT TO EXTEND PAST FOUNDATION WALL TO CONNECT FLEX CONDUIT FITTING TO

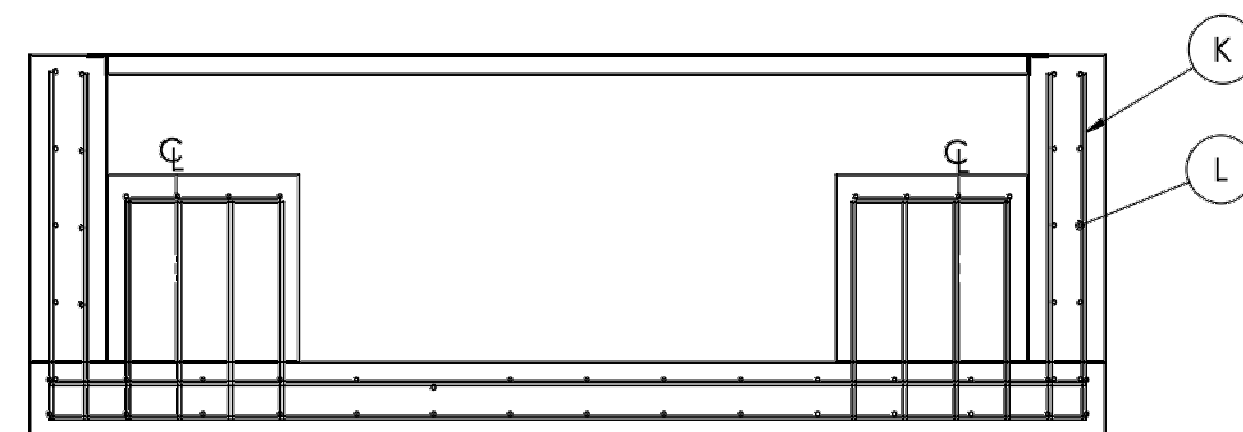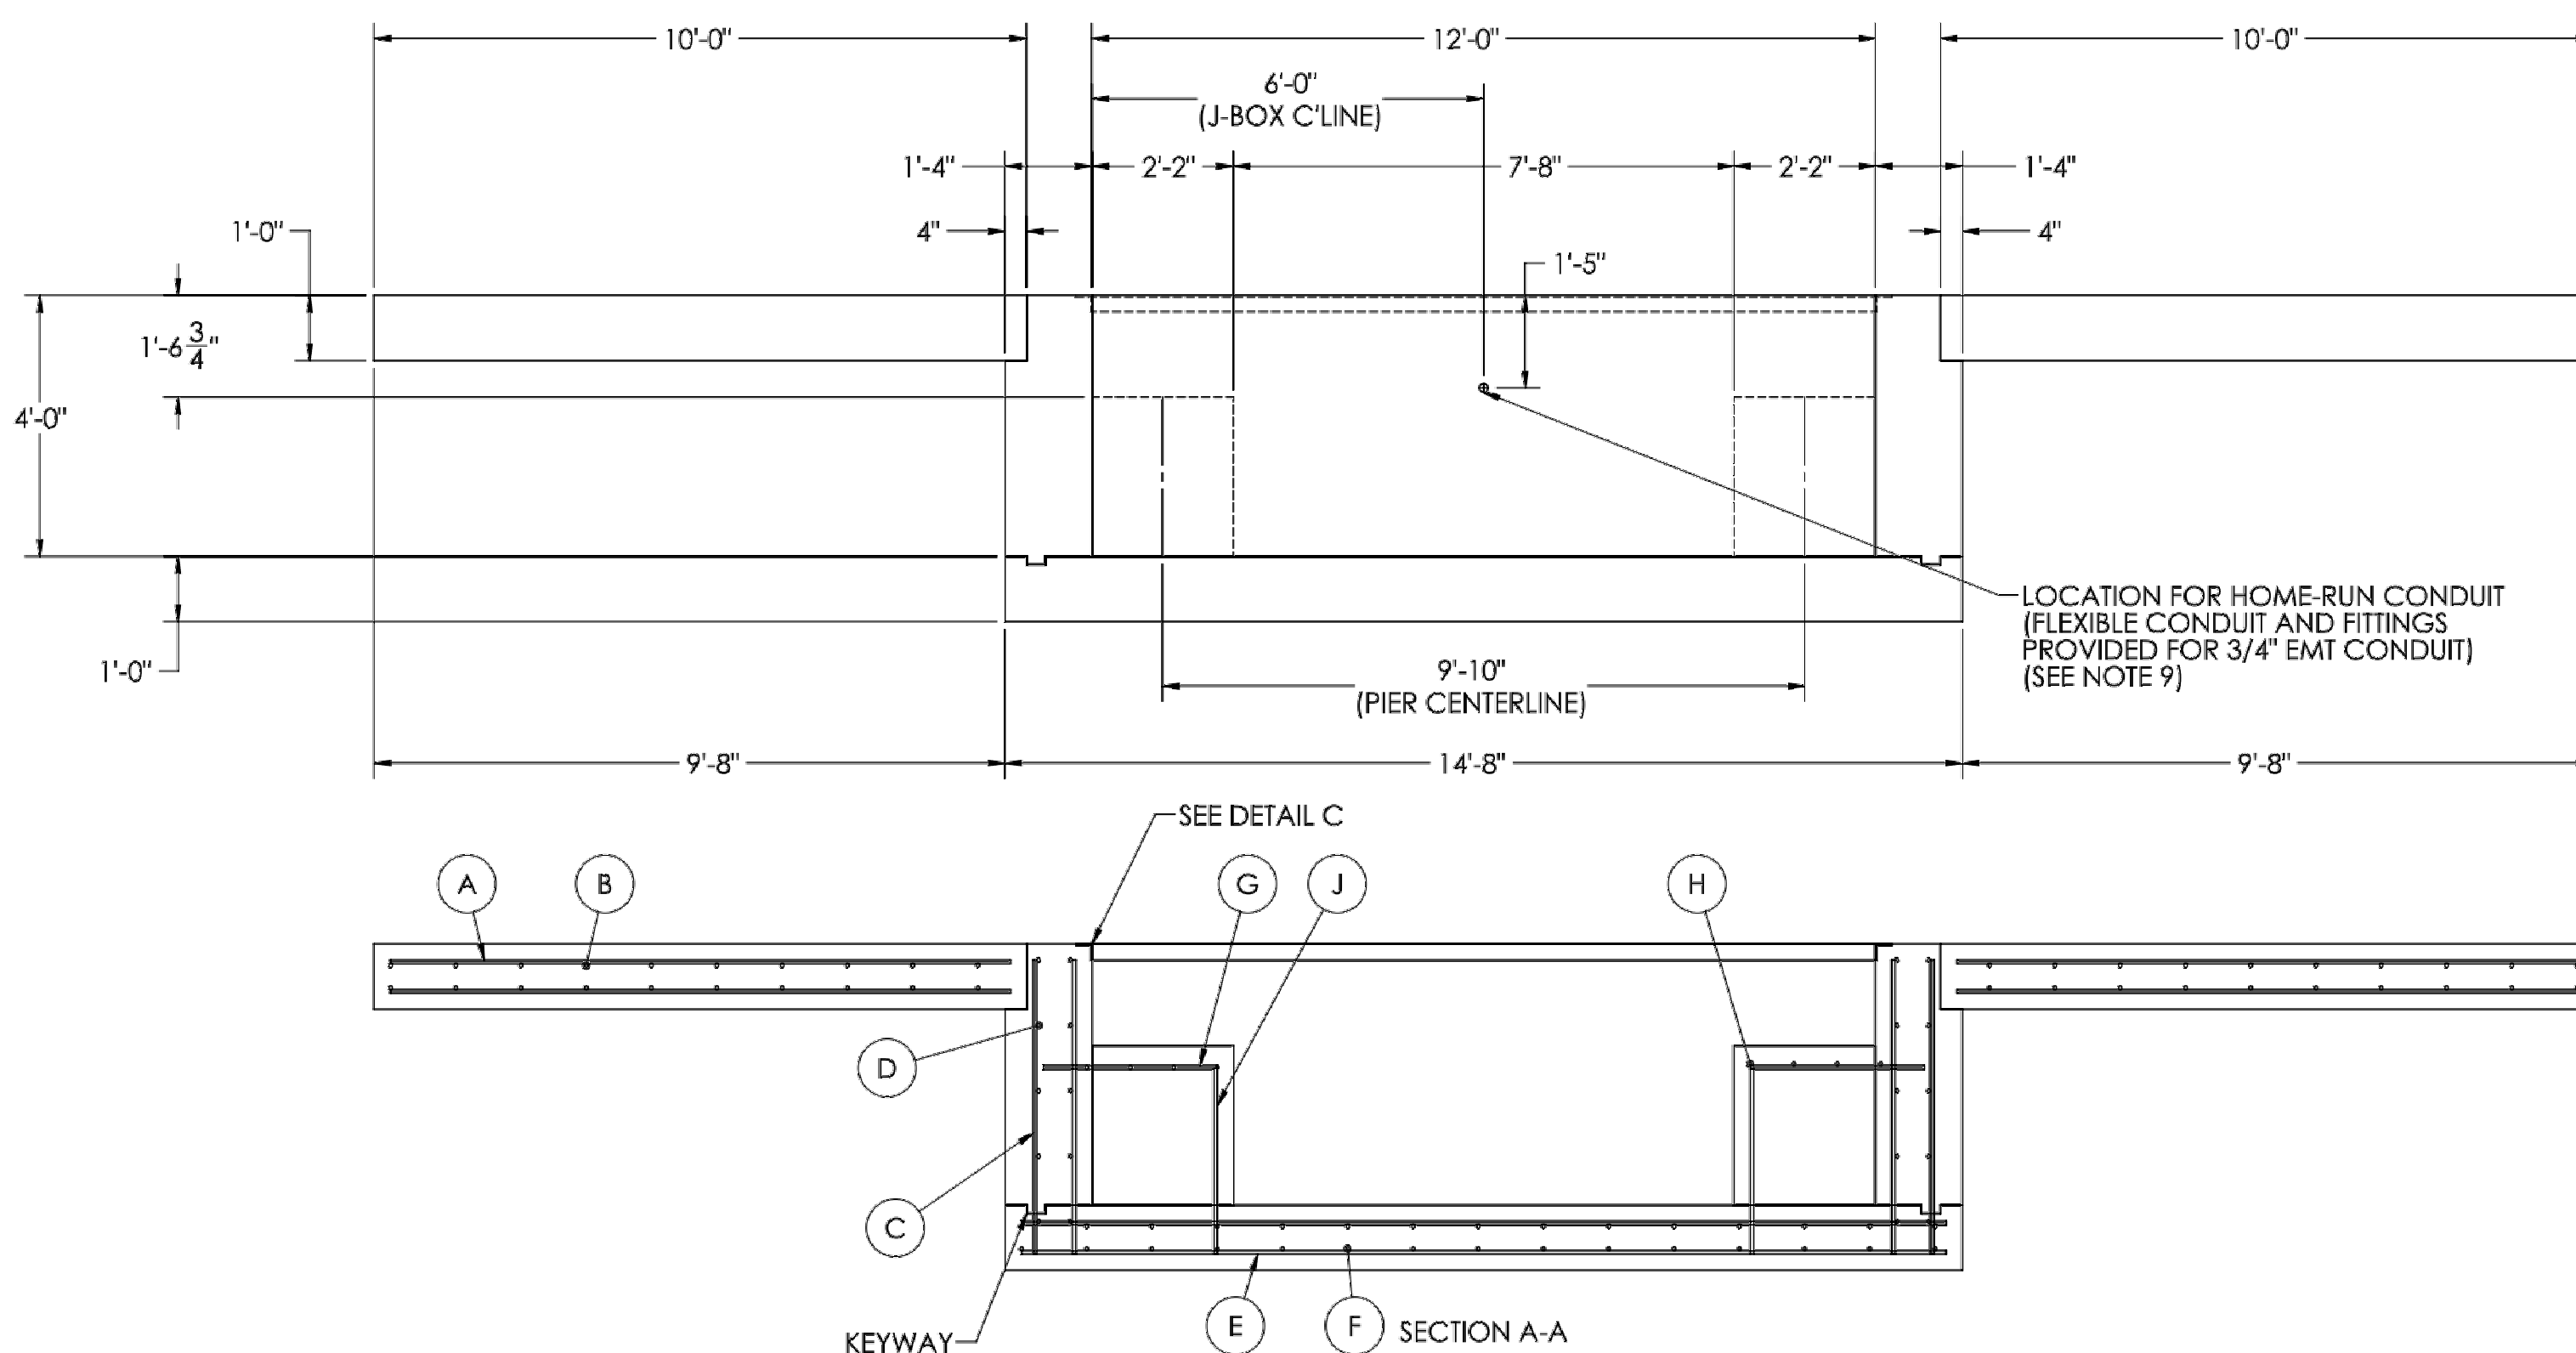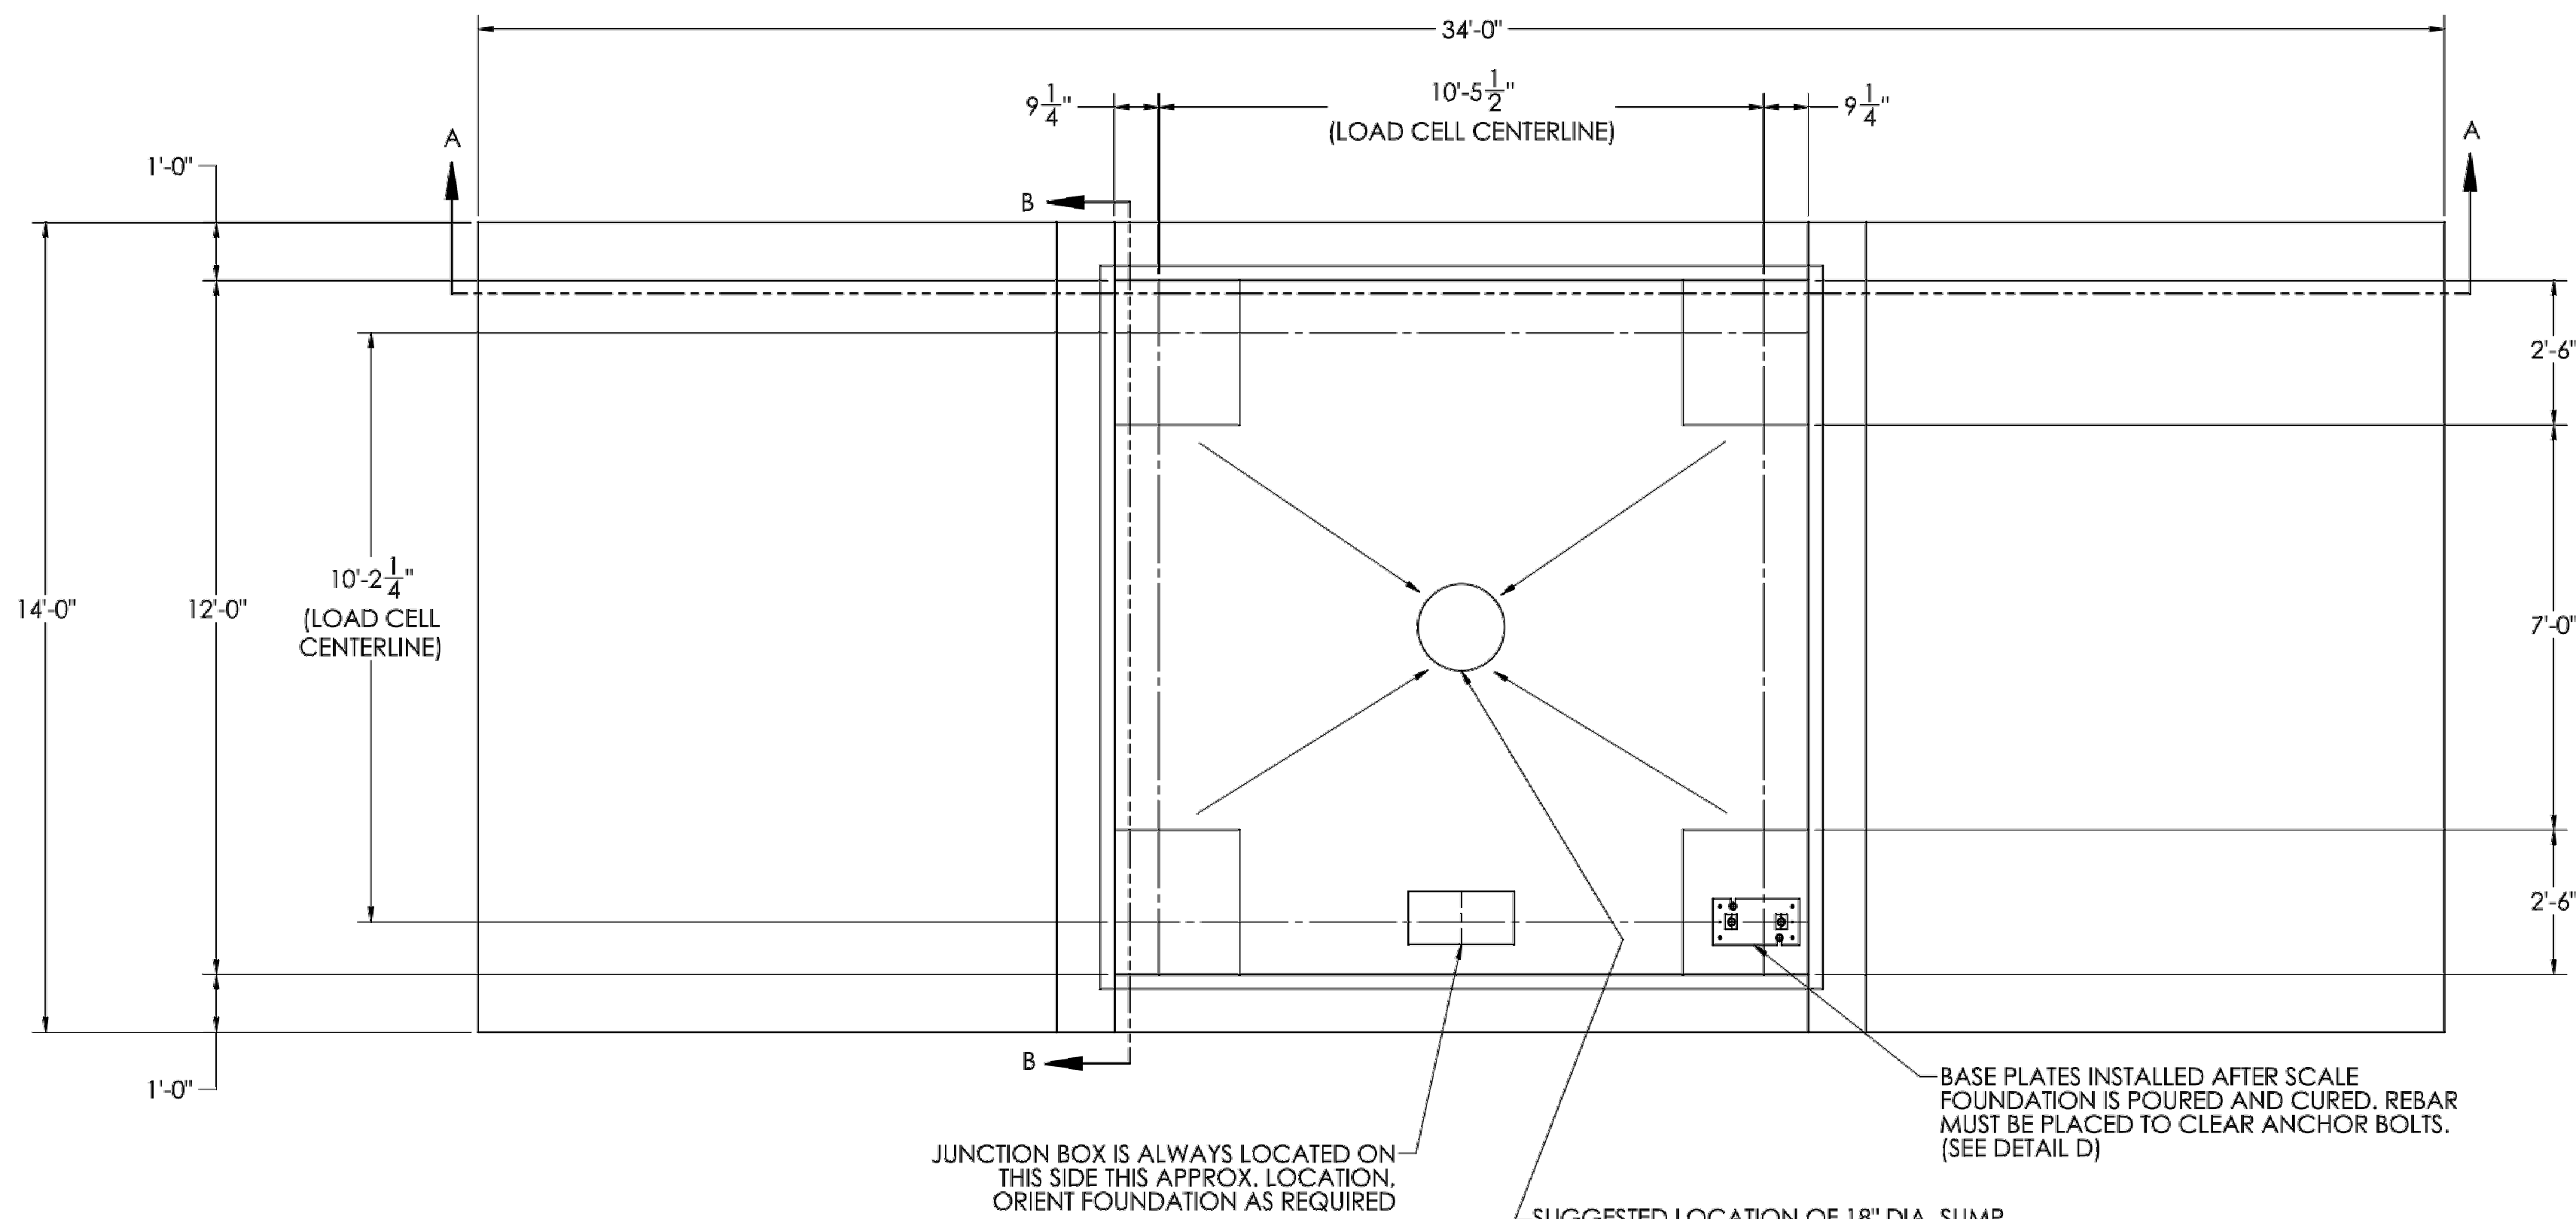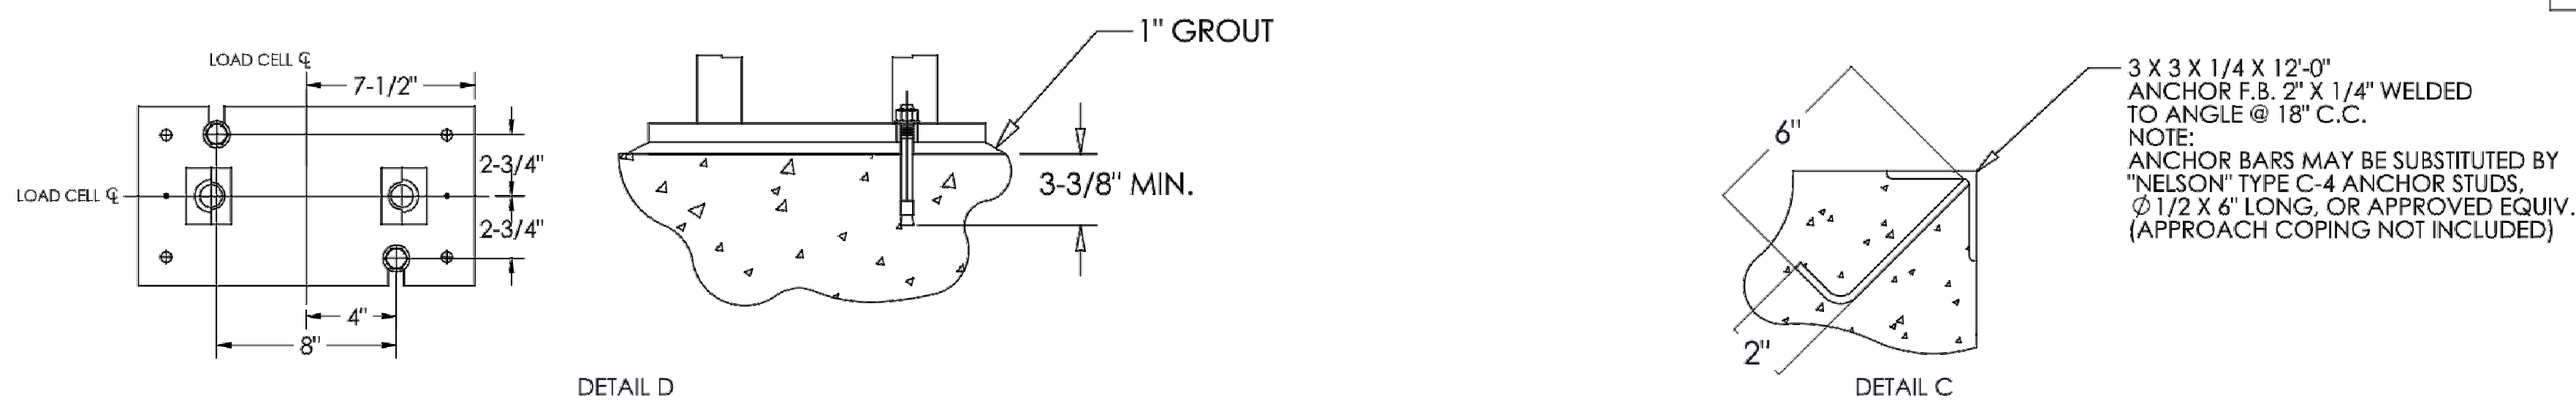

SECTION B-B

ISSUED BY DATE <b>S. JOHNSON</b> 10/05/2016		CHECKED BY DATE <b>S. JOHNSON</b> 10/05/2016		DRAWN BY DATE <b>S. JOHNSON</b> 10/05/2016	
SPECIES <b>NONE</b>		INFO REGARDING AND INFORMATION CONTAINED HEREIN IS THE PROPERTY OF RICE LAKE WEIGHING SYSTEMS, INC. INFORMATION CONTAINED HEREIN IS UNCLASSIFIED EXCEPT WHERE SHOWN OTHERWISE. IT IS TO BE CONTAINED HEREIN AND IS NOT TO BE REPRODUCED OR TRANSMITTED IN ANY FORM OR BY ANY MEANS, ELECTRONIC OR MECHANICAL, INCLUDING PHOTOCOPYING, RECORDING, OR BY ANY INFORMATION STORAGE AND RETRIEVAL SYSTEM, WITHOUT PERMISSION IN WRITING FROM RICE LAKE WEIGHING SYSTEMS, INC.		UNLESS OTHERWISE SPECIFIED ALL MEASUREMENTS ARE TO BE IN INCHES. ALL DIMENSIONS ARE TO BE TO THE CENTERLINE UNLESS OTHERWISE SPECIFIED.	
NUMBER OF COPIES <b>ONE</b>		TOLERANCES DIMENSIONS UNLESS OTHERWISE SPECIFIED FINISH DO NOT SCALE DIMENSIONS UNLESS OTHERWISE SPECIFIED FINISH DO NOT SCALE DIMENSIONS UNLESS OTHERWISE SPECIFIED FINISH		FOUNDATION, CONCRETE PIT 12' X 12' OR SERIES TRUCK SCALE	
DIMENSION CLASS CAPACITY <b>10000</b>		SCALE <b>1:48</b>		BEAM <b>1 OF 1</b>	
DIMENSIONED MEASURE (POUNDS) <b>179376</b>		ANGLE <b>XXX:</b> <b>ANGLE:</b>		DRAW ANGLE POSITION <b>179376</b>	
				REV <b>C</b>	

OWNER SUPPLIES WEIGH SCALE,  
WEIGH SCALE CONTRACTOR INSTALLS  
WEIGH SCALE AND COMPONENTS.  
GENERAL CONTRACTOR IS  
RESPONSIBLE FOR WEIGH SCALE PAD  
AND RECESSED PIT PER DRAWING. PIT  
DRAINAGE CAN BE FROM SIDE OF PIT,  
COORDINATE WITH CIVIL DRAWINGS.

REVISION				
REV	ECO	DESCRIPTION	INIT	DATE
A		ENGINEERING RELEASE	SPJ	10/05/2016
B		ADDED GROUT, CHANGED PROFILE HEIGHT, CHANGED NOTE PER CUSTOMER	SPJ	10/05/2016
C		REVERTED BACK	SPJ	10/05/2016

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**Architects & Planners**  
42400 GRAND RIVER AVENUE, SUITE 200  
NOVI, MICHIGAN 48375  
PHONE 248-489-9160

PROJECT  
**R + L CARRIERS**  
EDINBURGH, INDIANA

Date Issued

Bids &amp; Permit Oct. 8, 2021




Job Number

5147

SHEET TITLE  
WEIGH SCALE  
PIT PLAN AND  
DETAILS

Sheet Number




A1.2

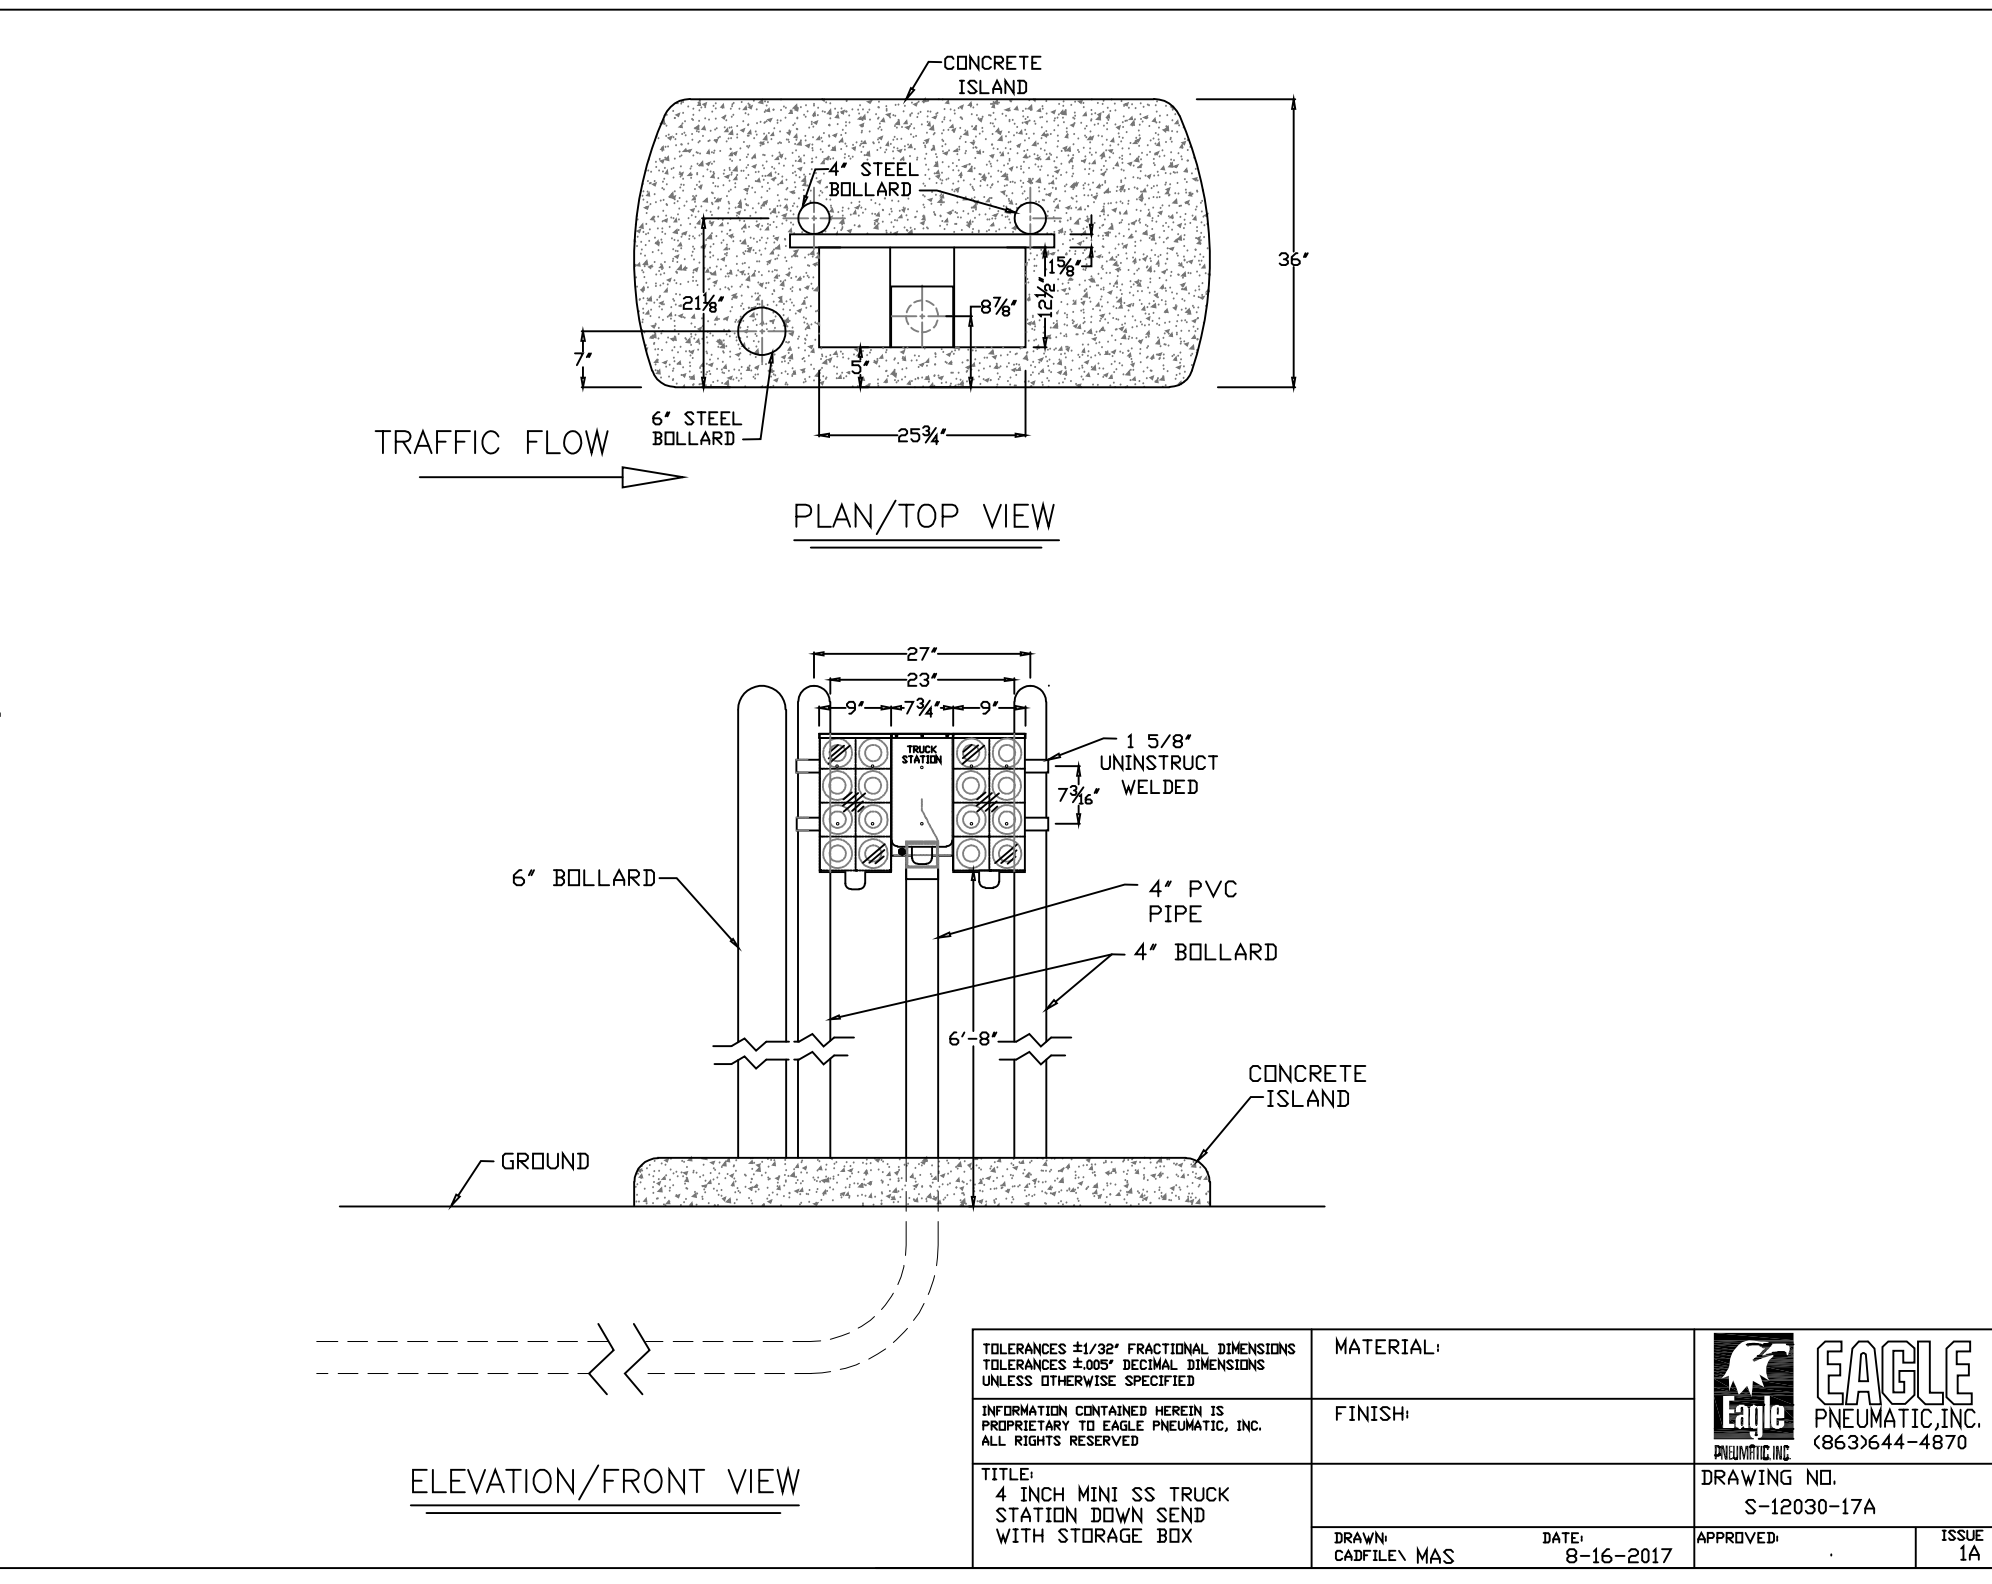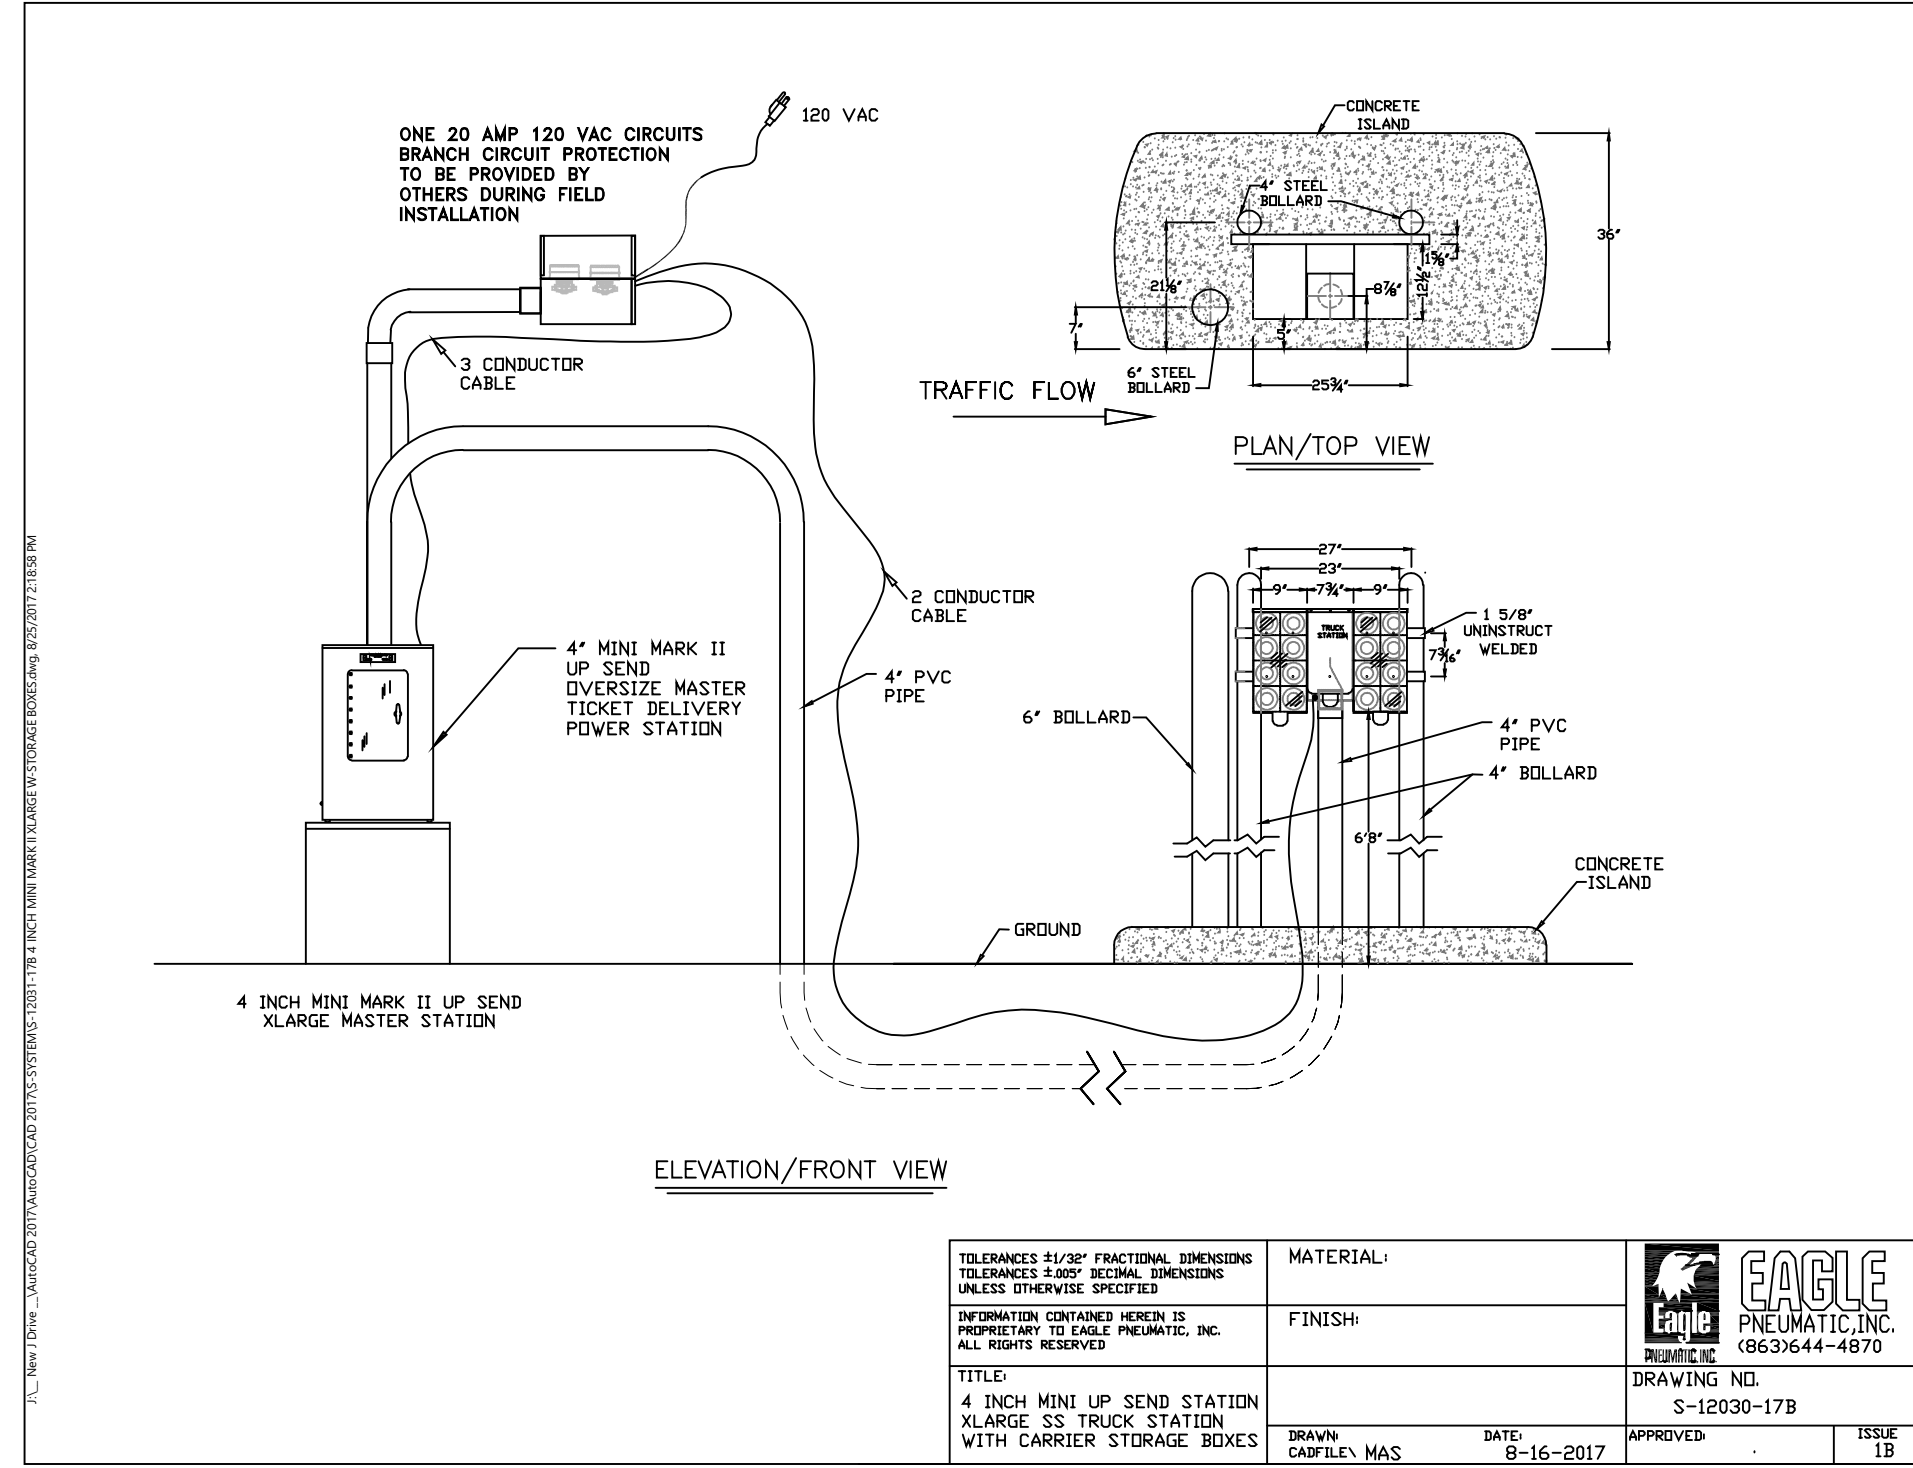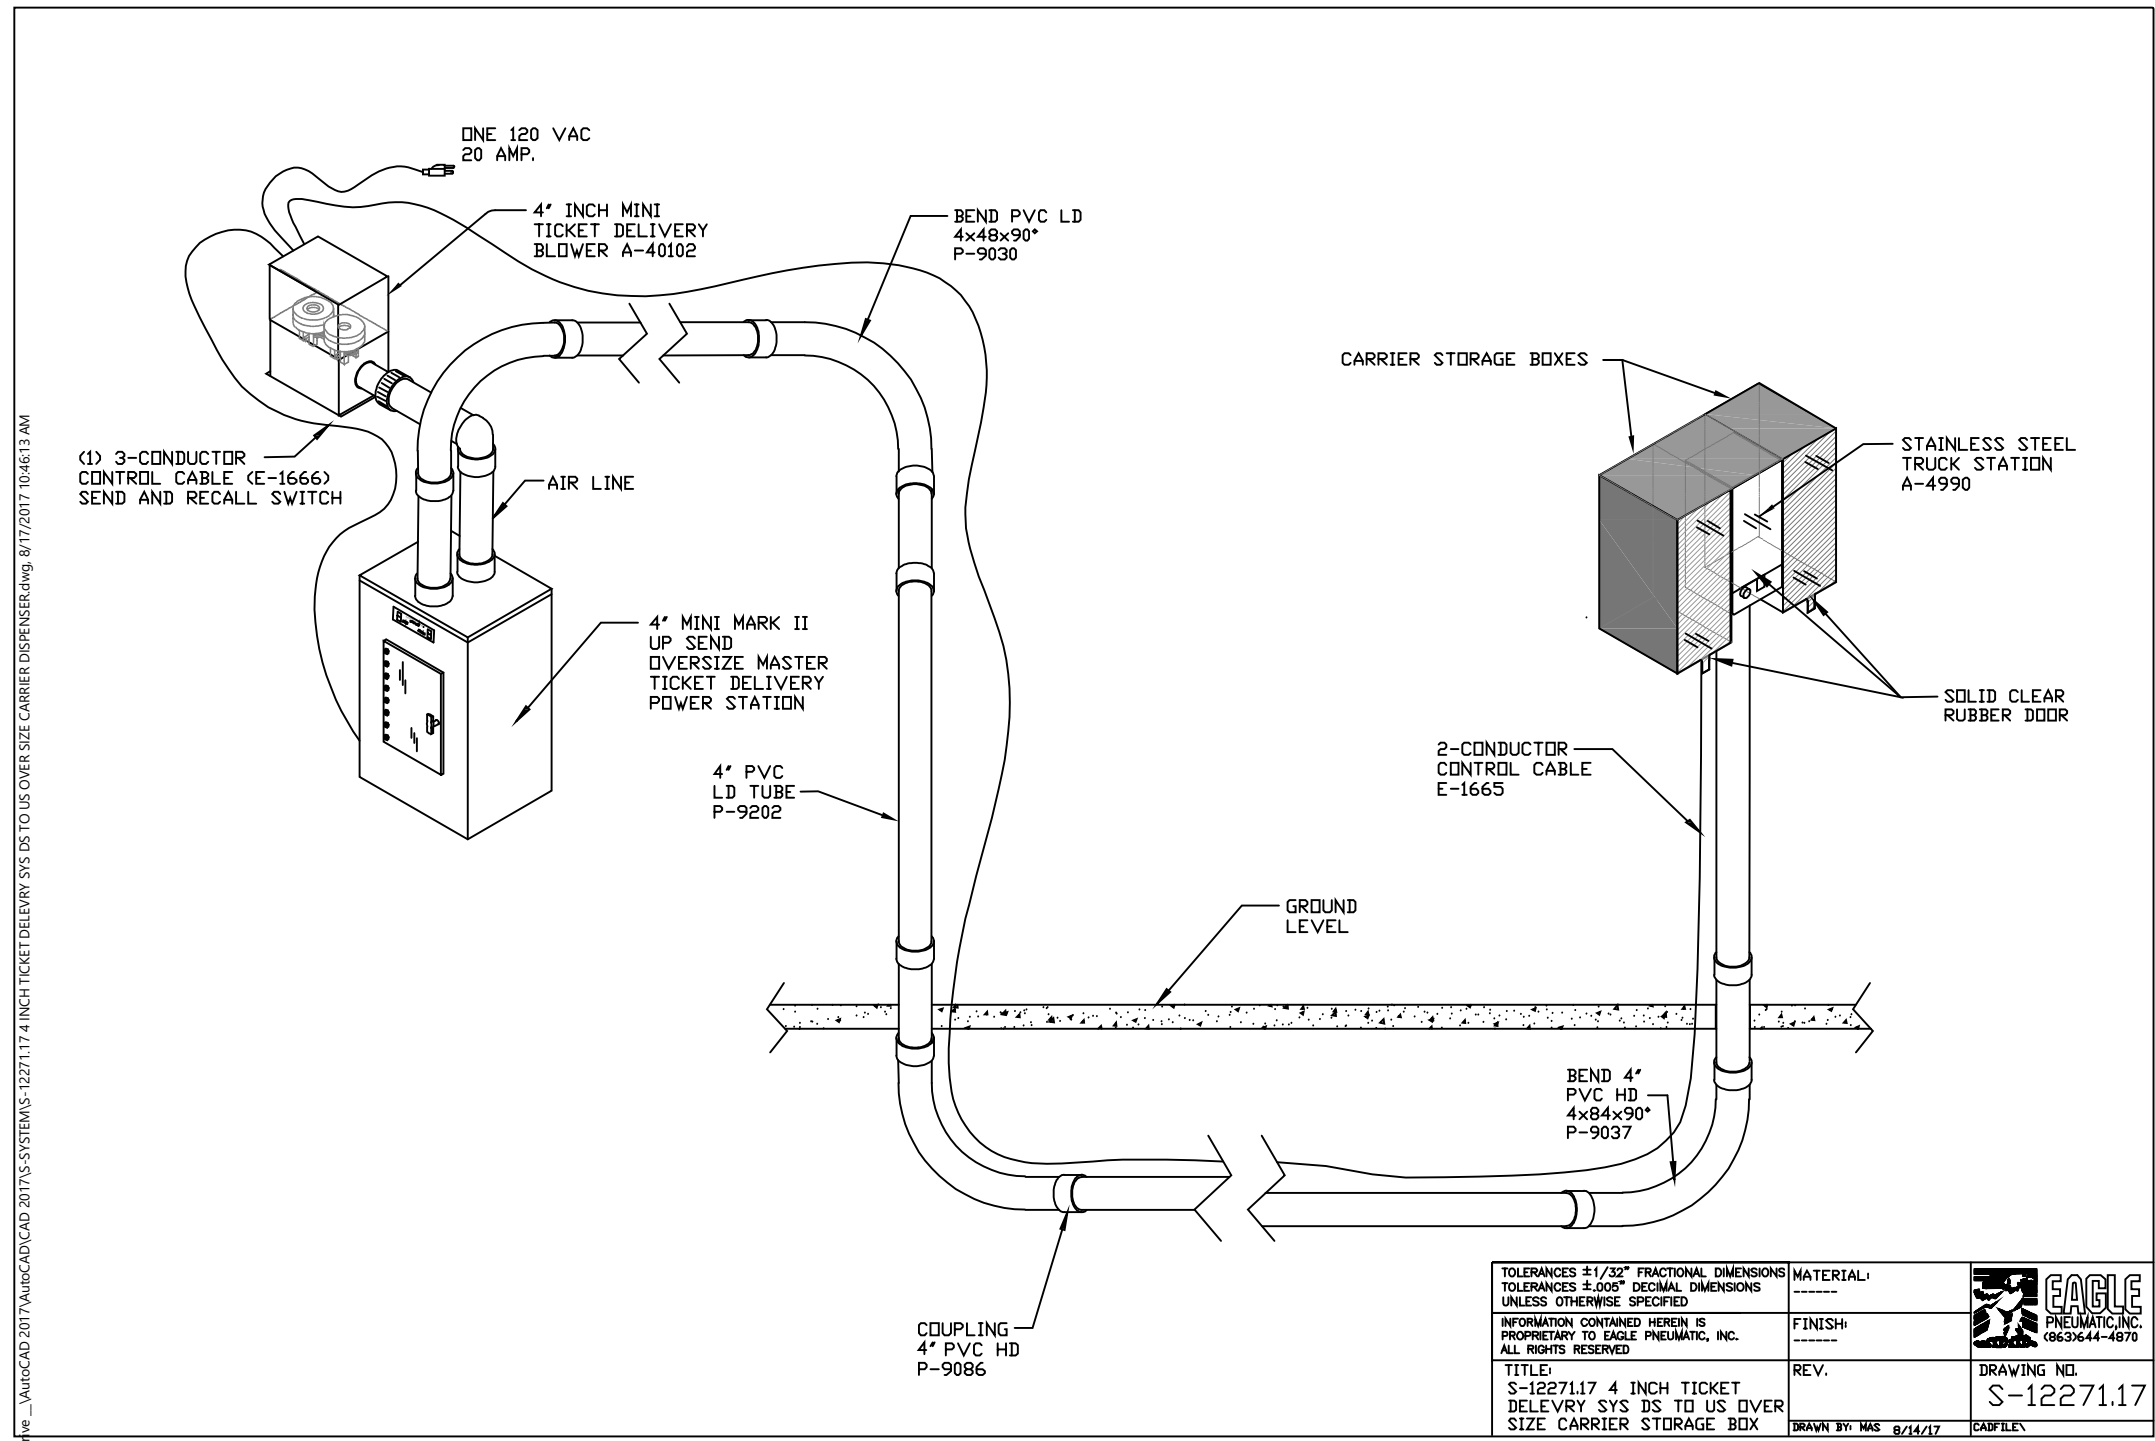

**PNEUMATIC TUBE SYSTEM DETAILS**  
SCALE: NONE

GENERAL CONTRACTOR IS TO PROVIDE AND INSTALL A COMPLETE PNEUMATIC TUBE SYSTEM. PNEUMATIC TUBE INFORMATION DETAILS ARE SCHEMATIC AND ARE FOR GENERAL REFERENCE ONLY. FINAL DESIGN IS BY EAGLE PNEUMATIC INC.

PNEUMATIC TUBE SYSTEM PROVIDE PNEUMATIC TUBE SYSTEM FROM TRUCK ENTRANCE CONTROL ISLAND TO OFFICE #100 AT FIRE RISER ROOM THEN ROUTED TO DISPATCH ROOM. SEE ENTRY GATE PLAN 1 ON SHEET A1.1 AND SPECIFICATIONS.




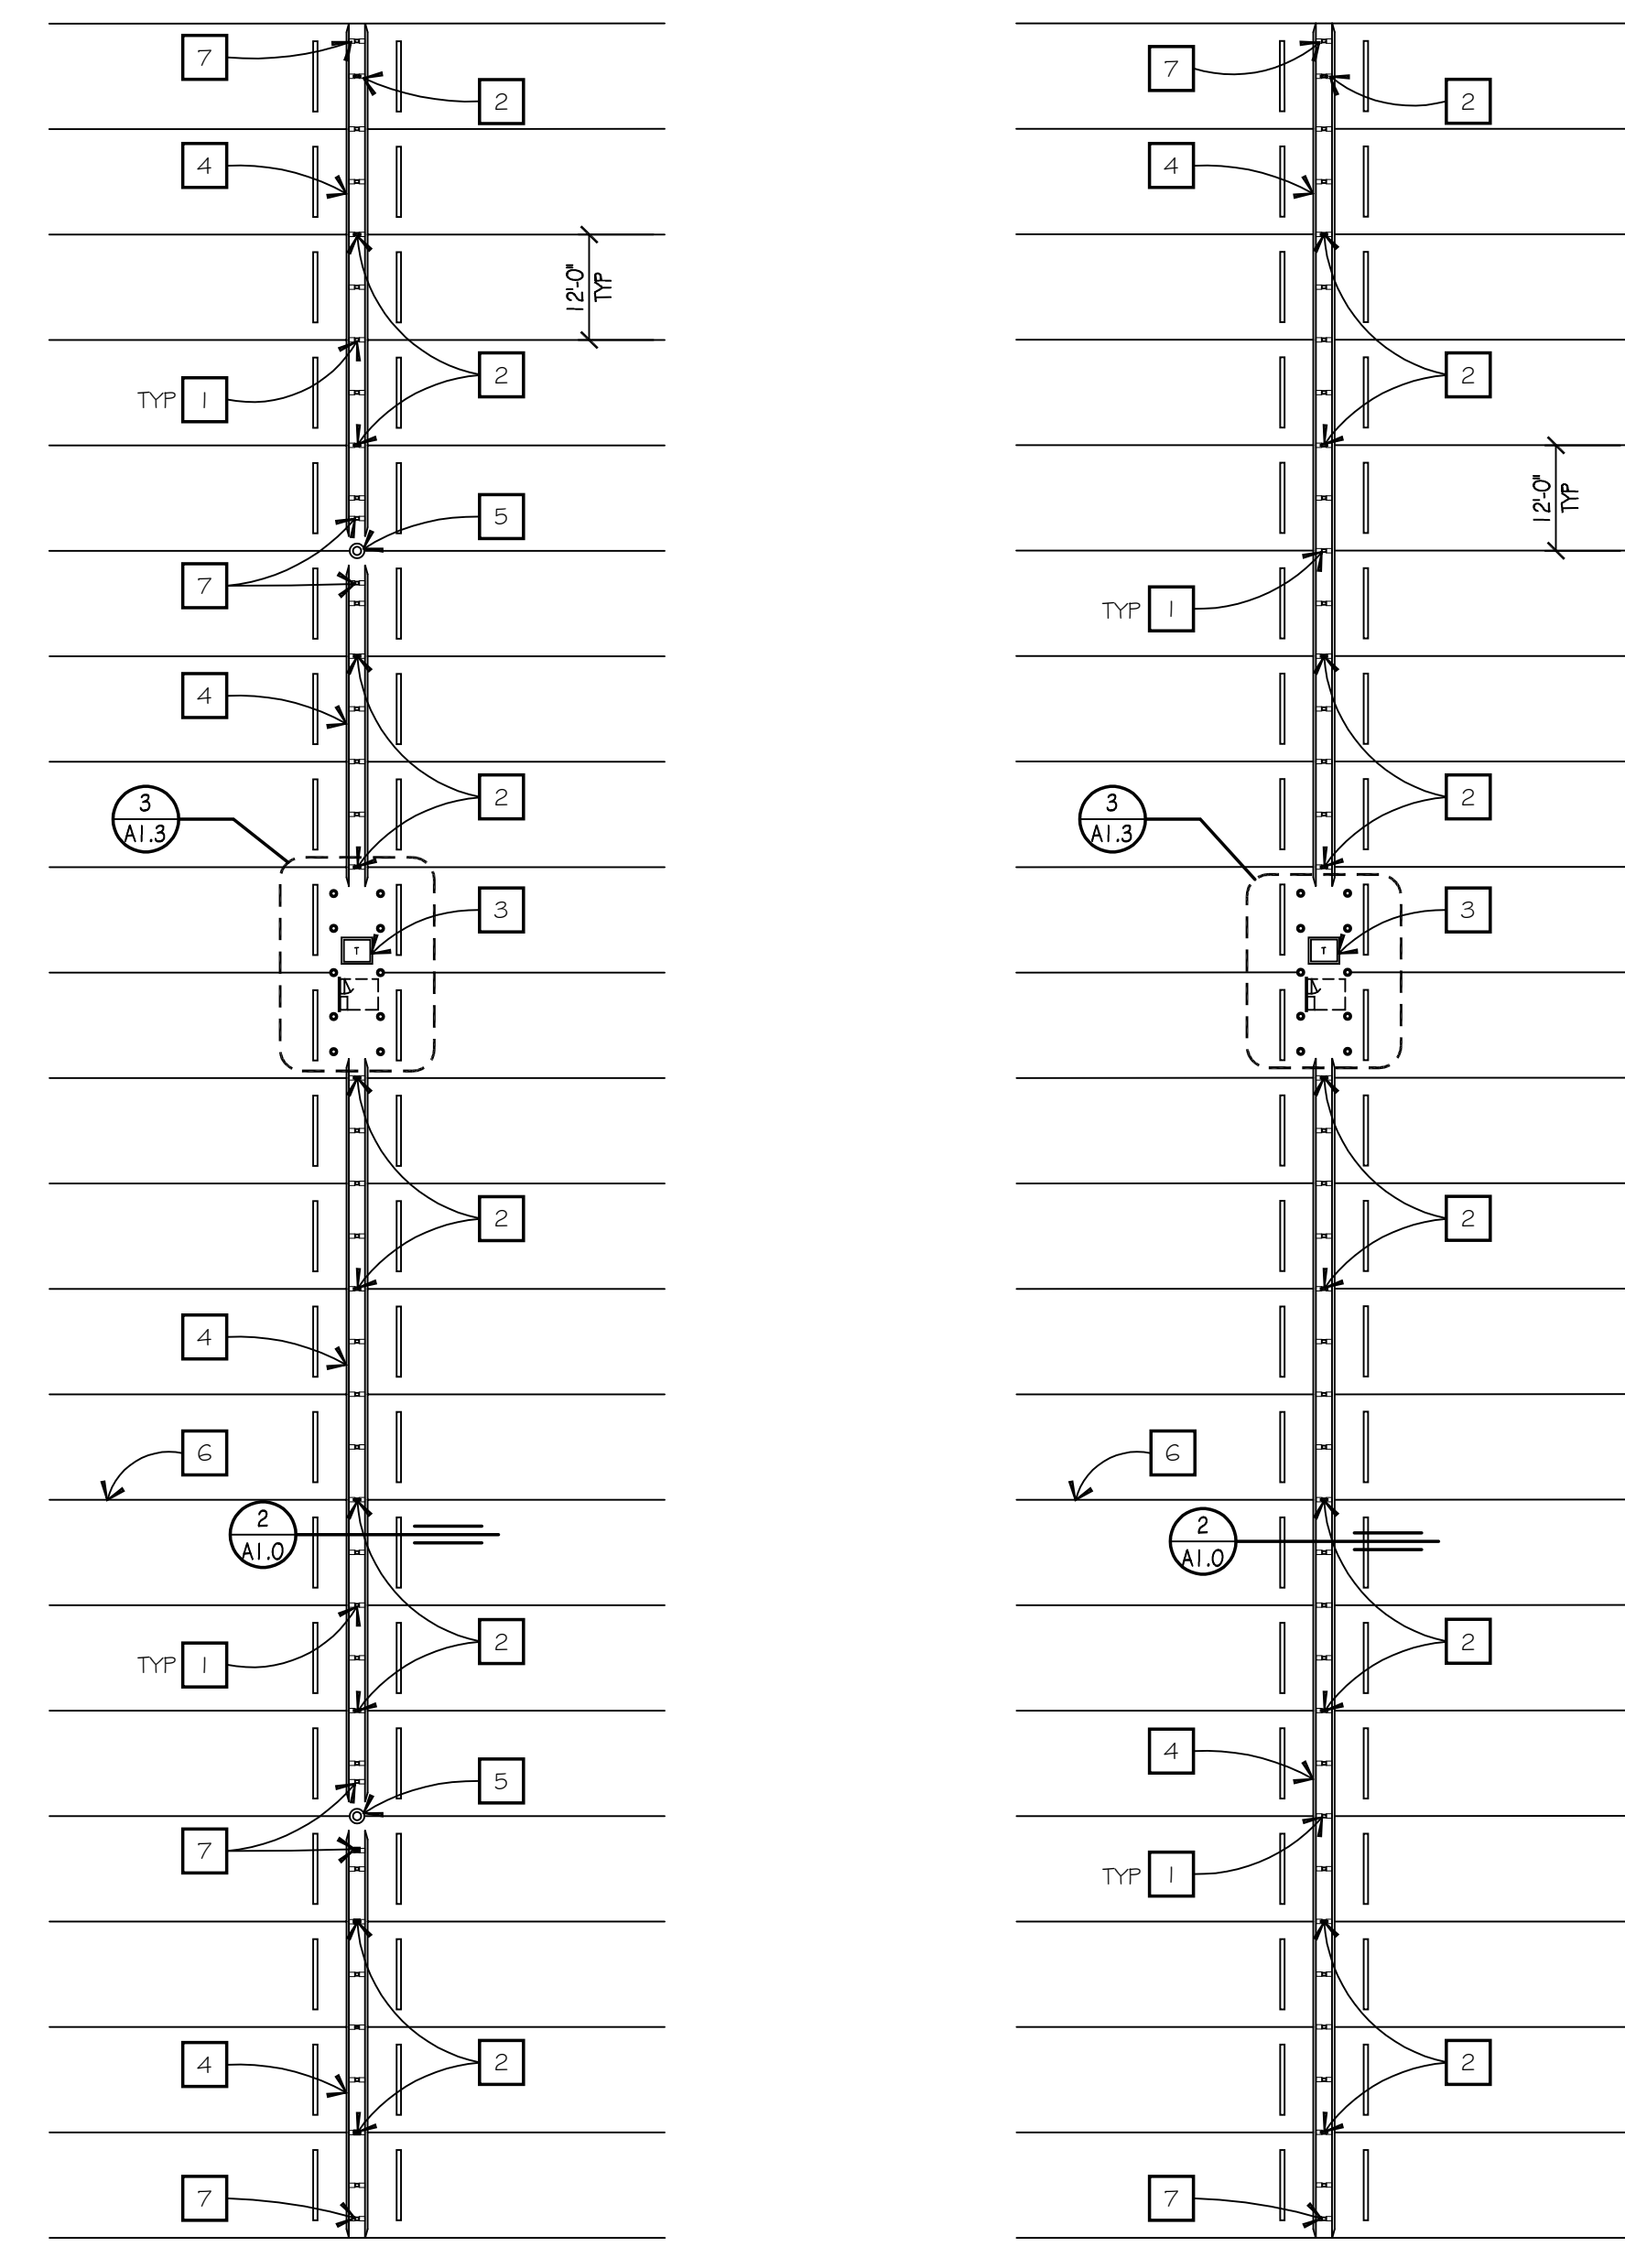
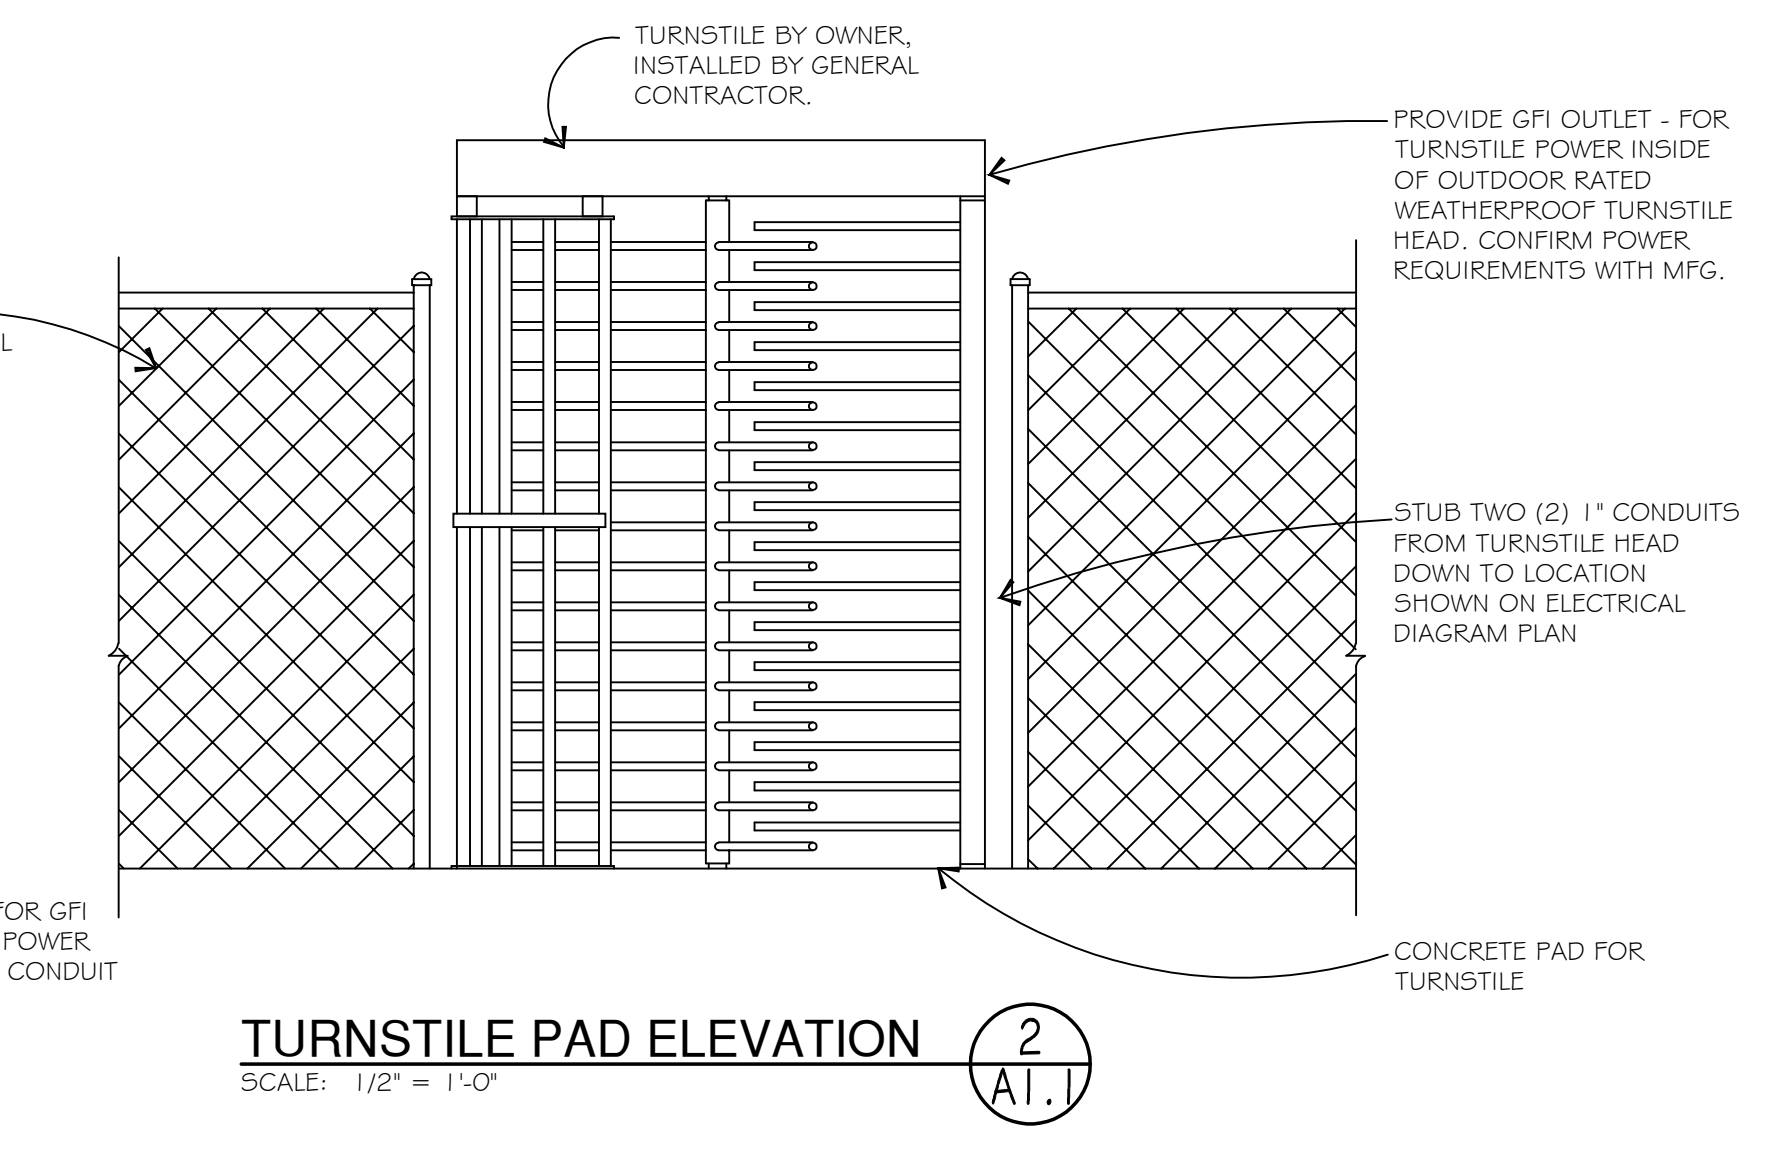
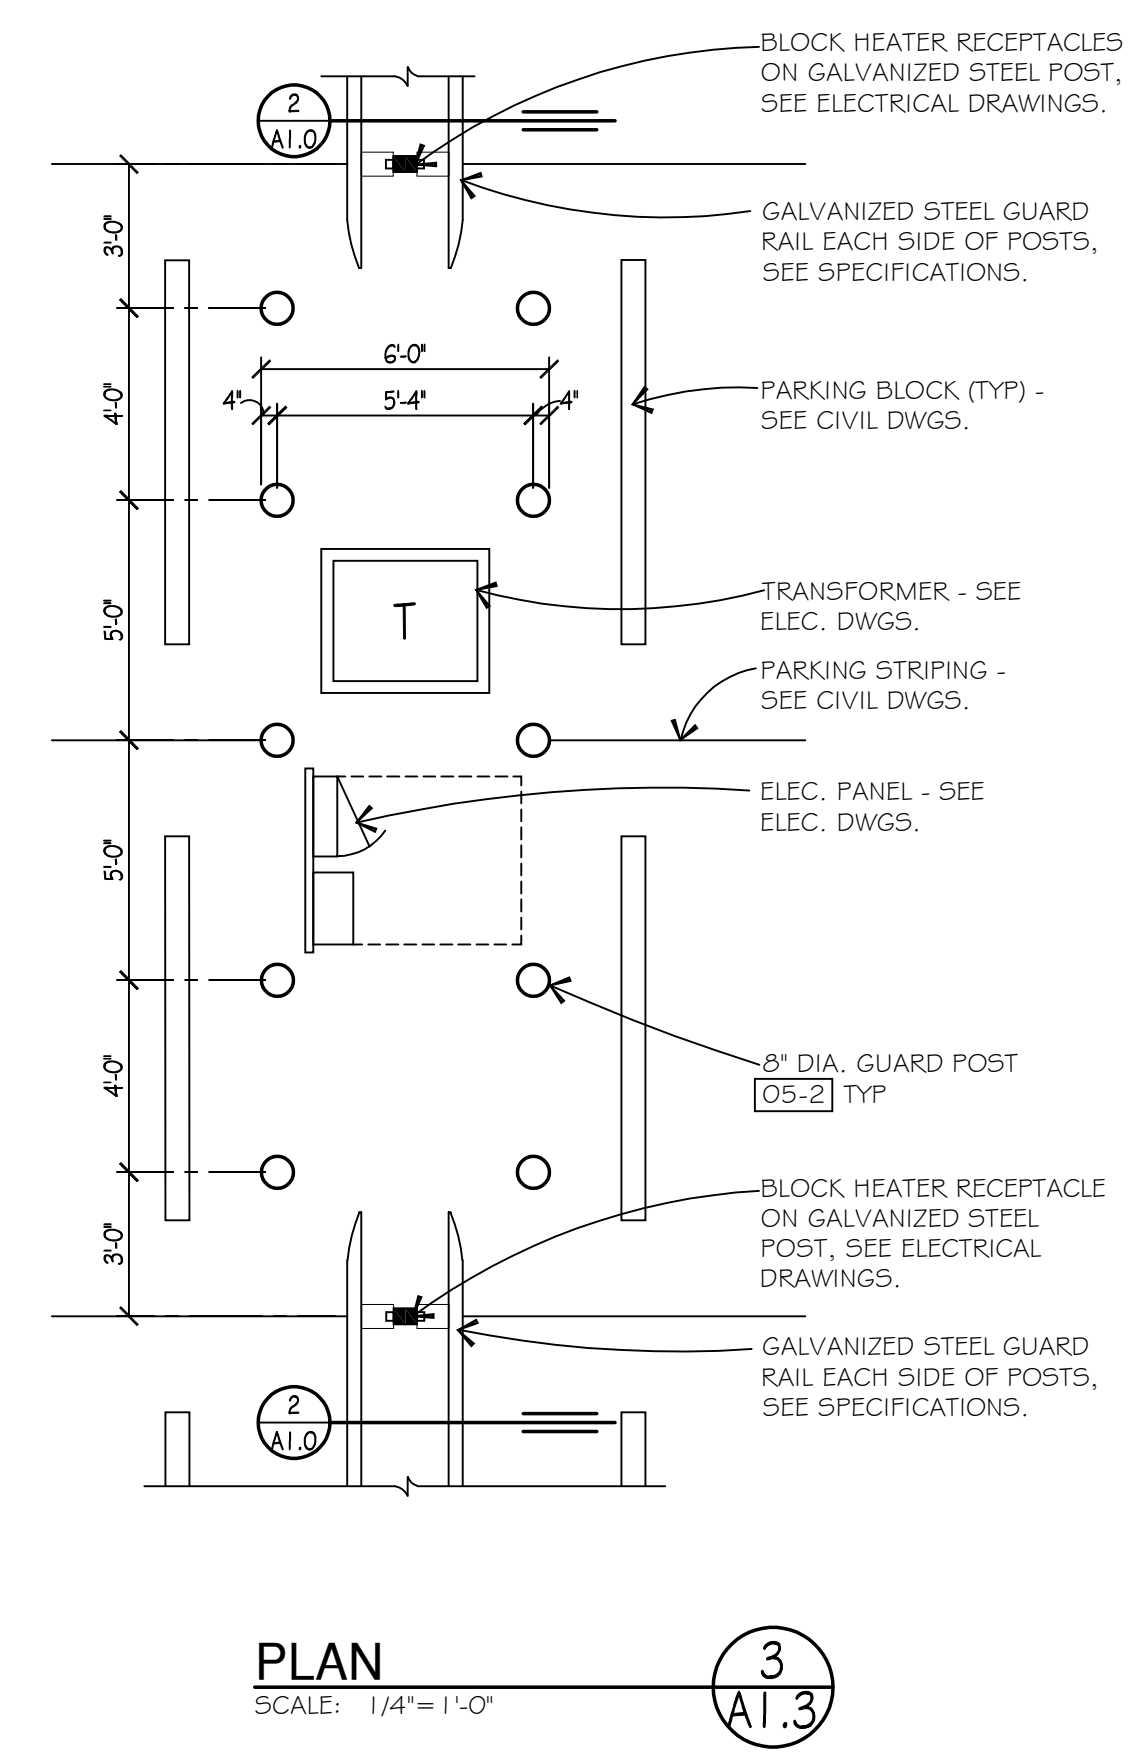










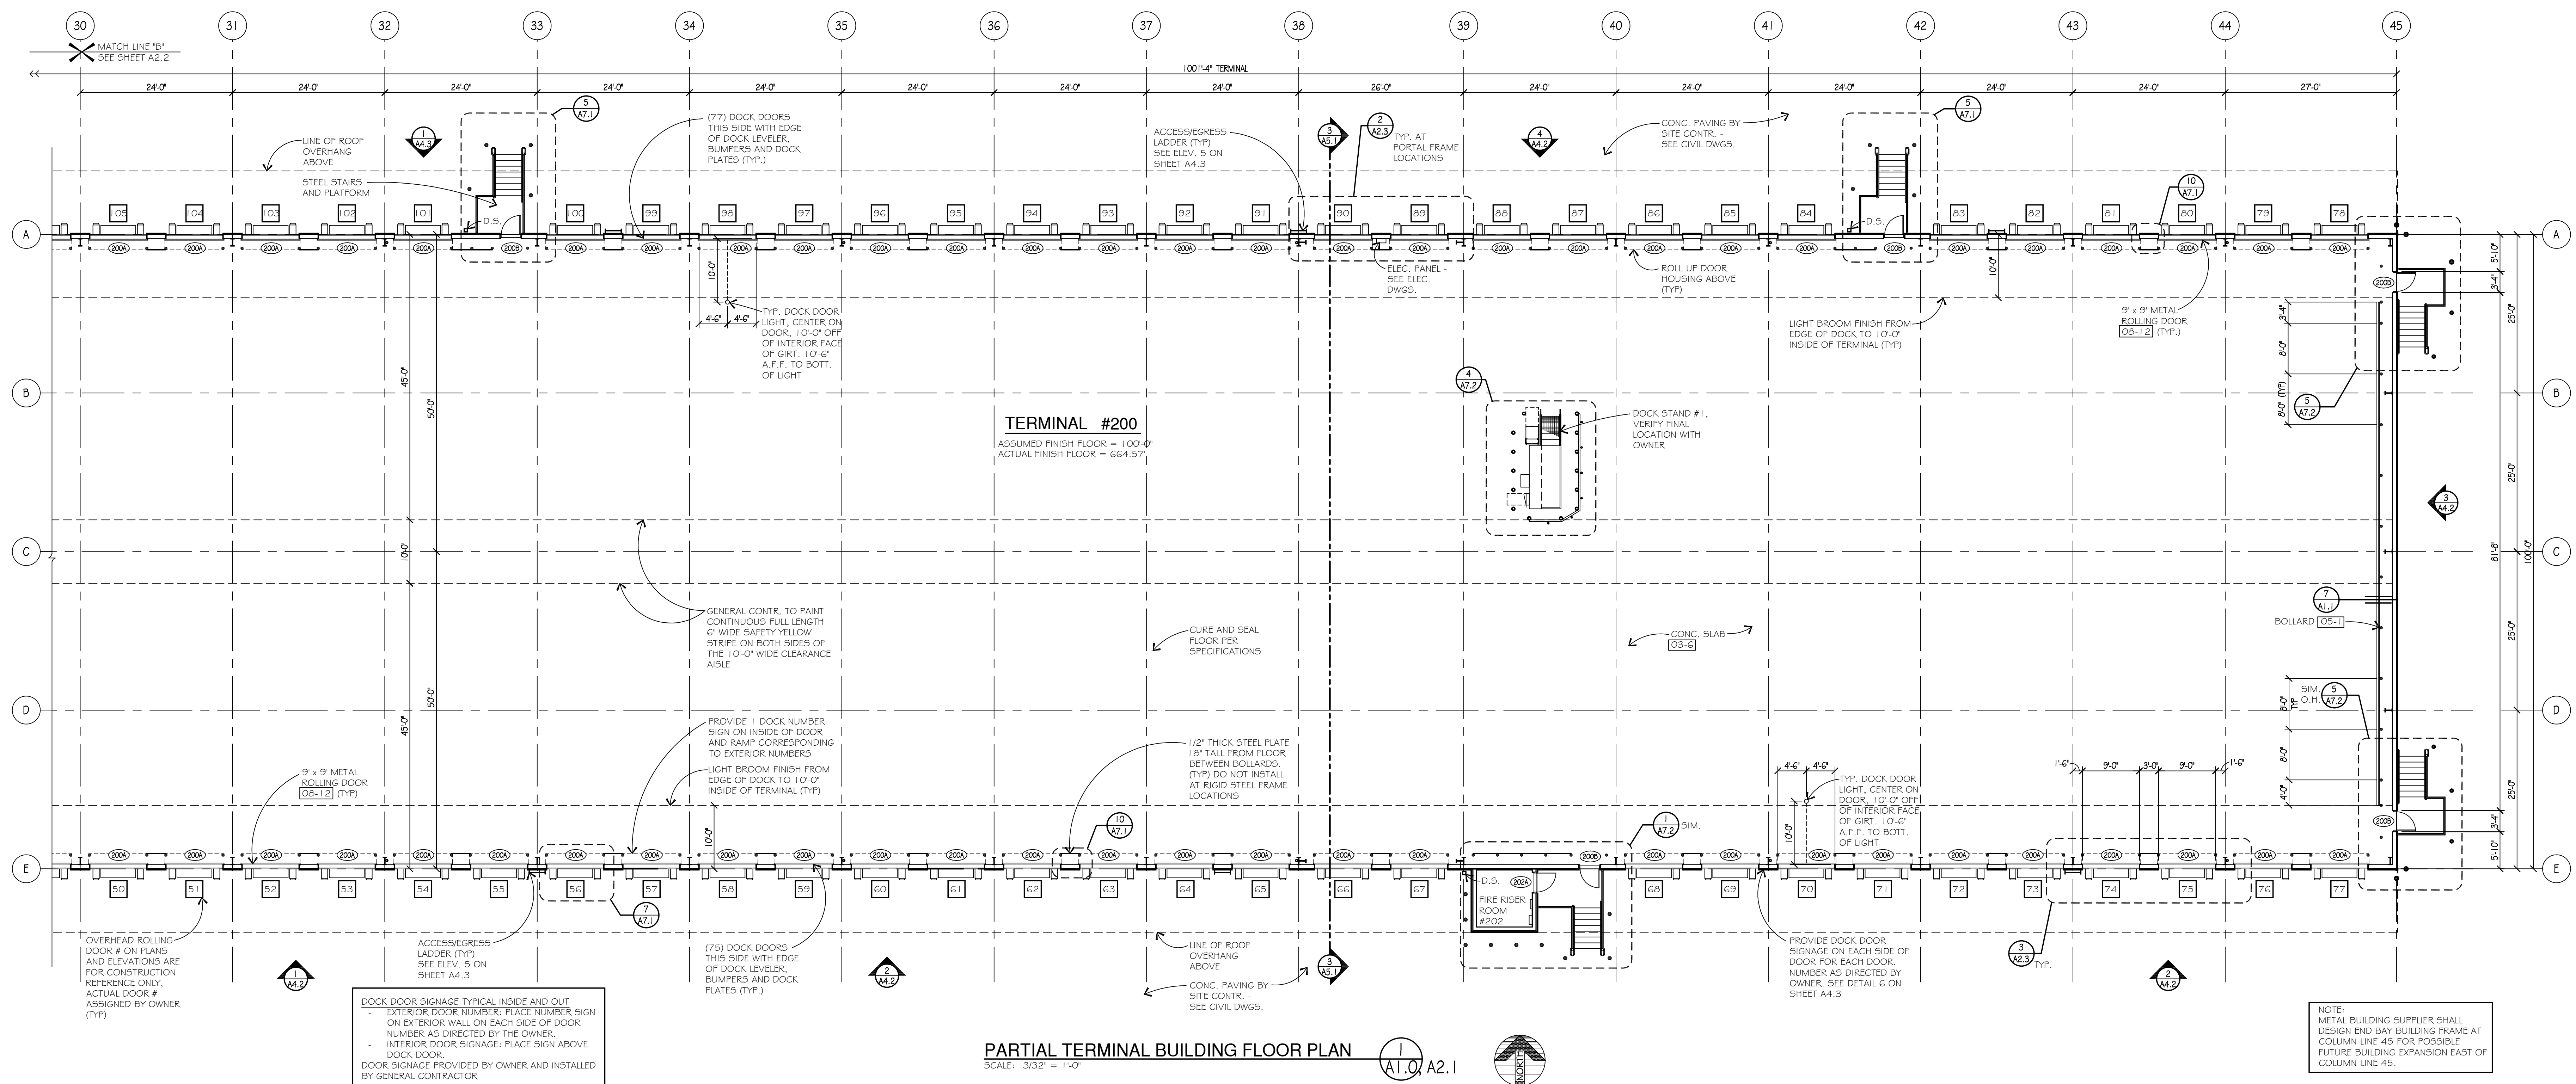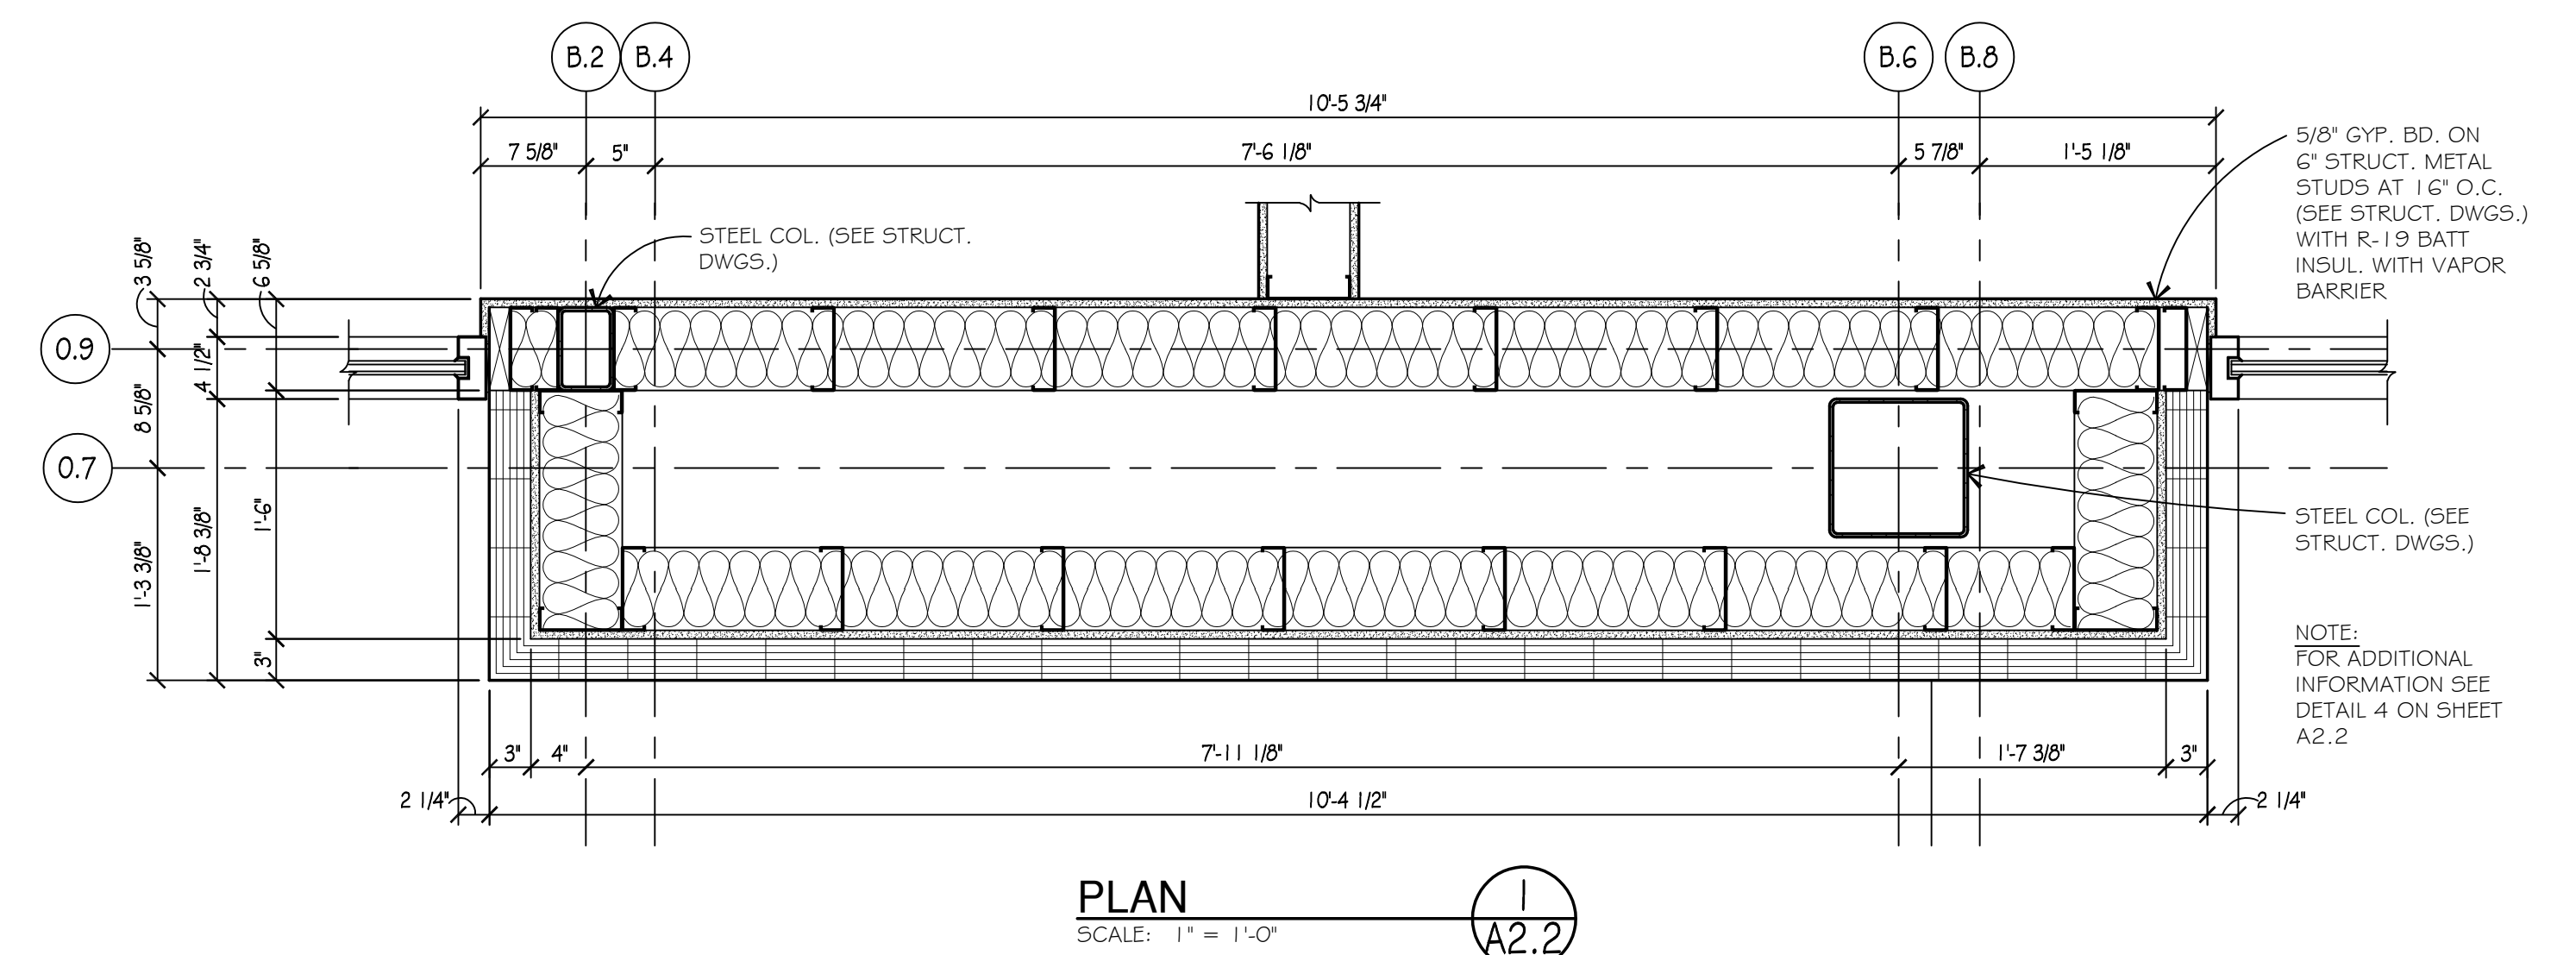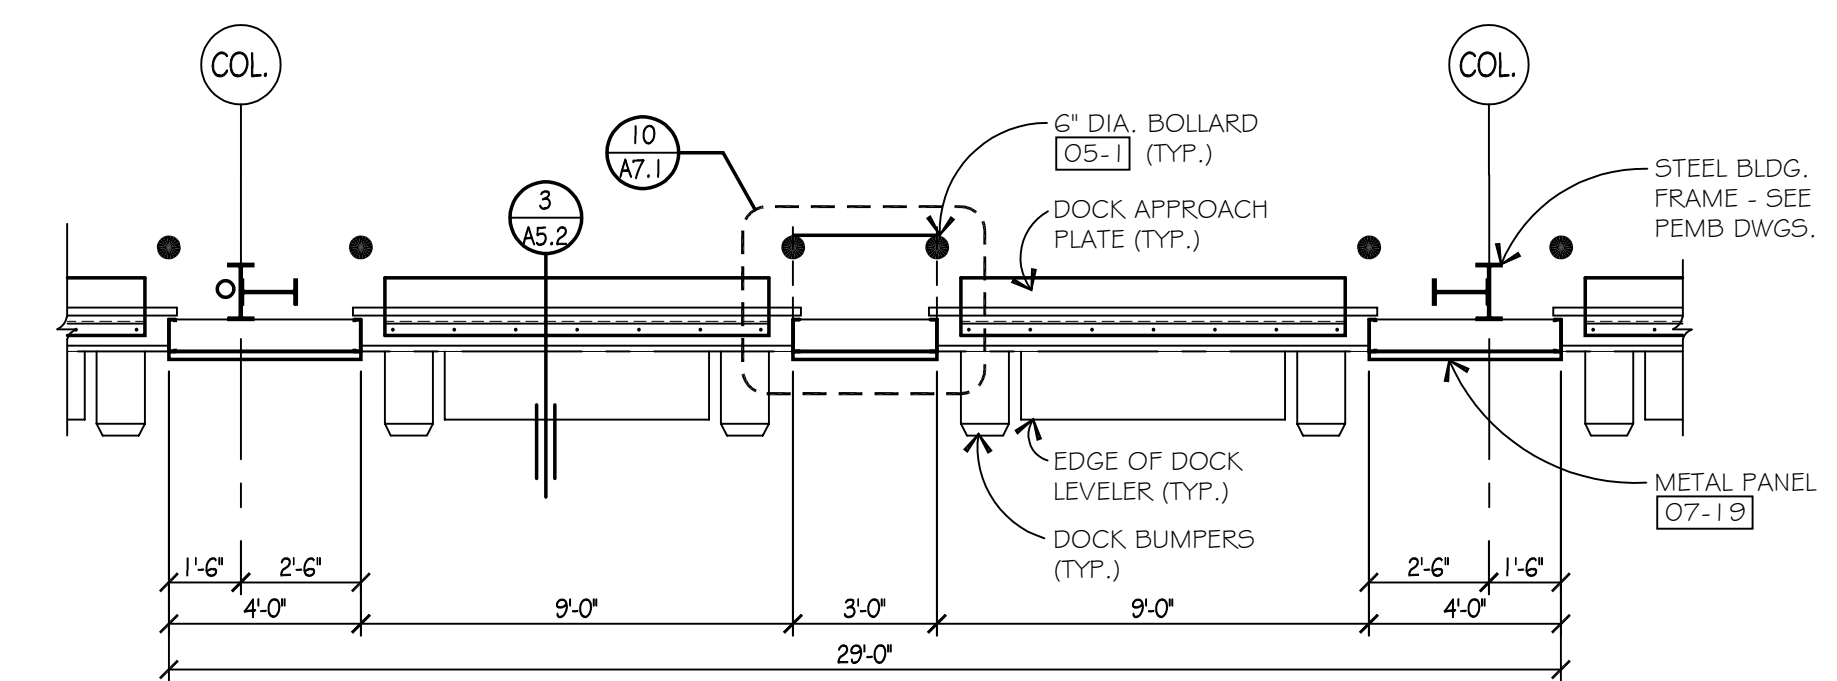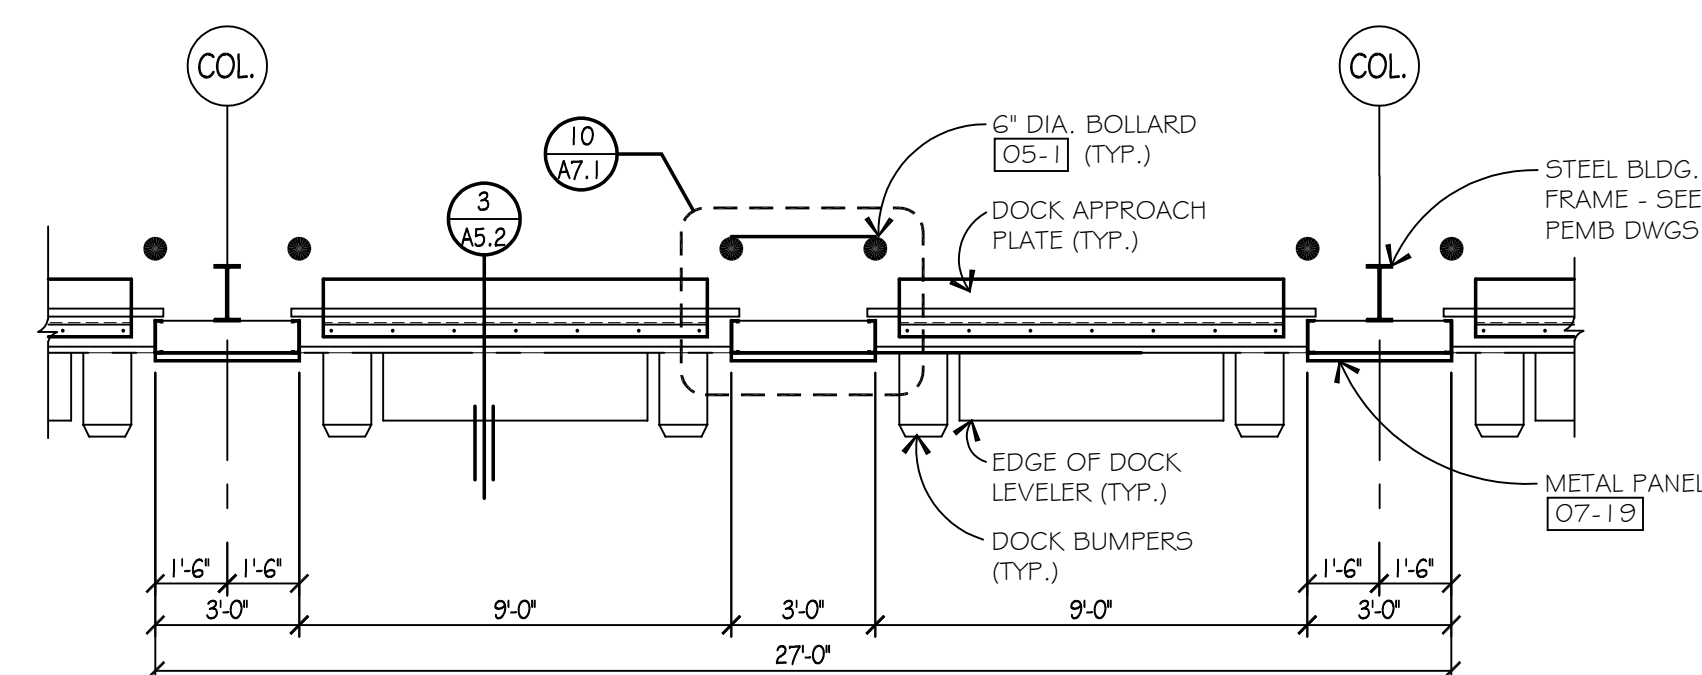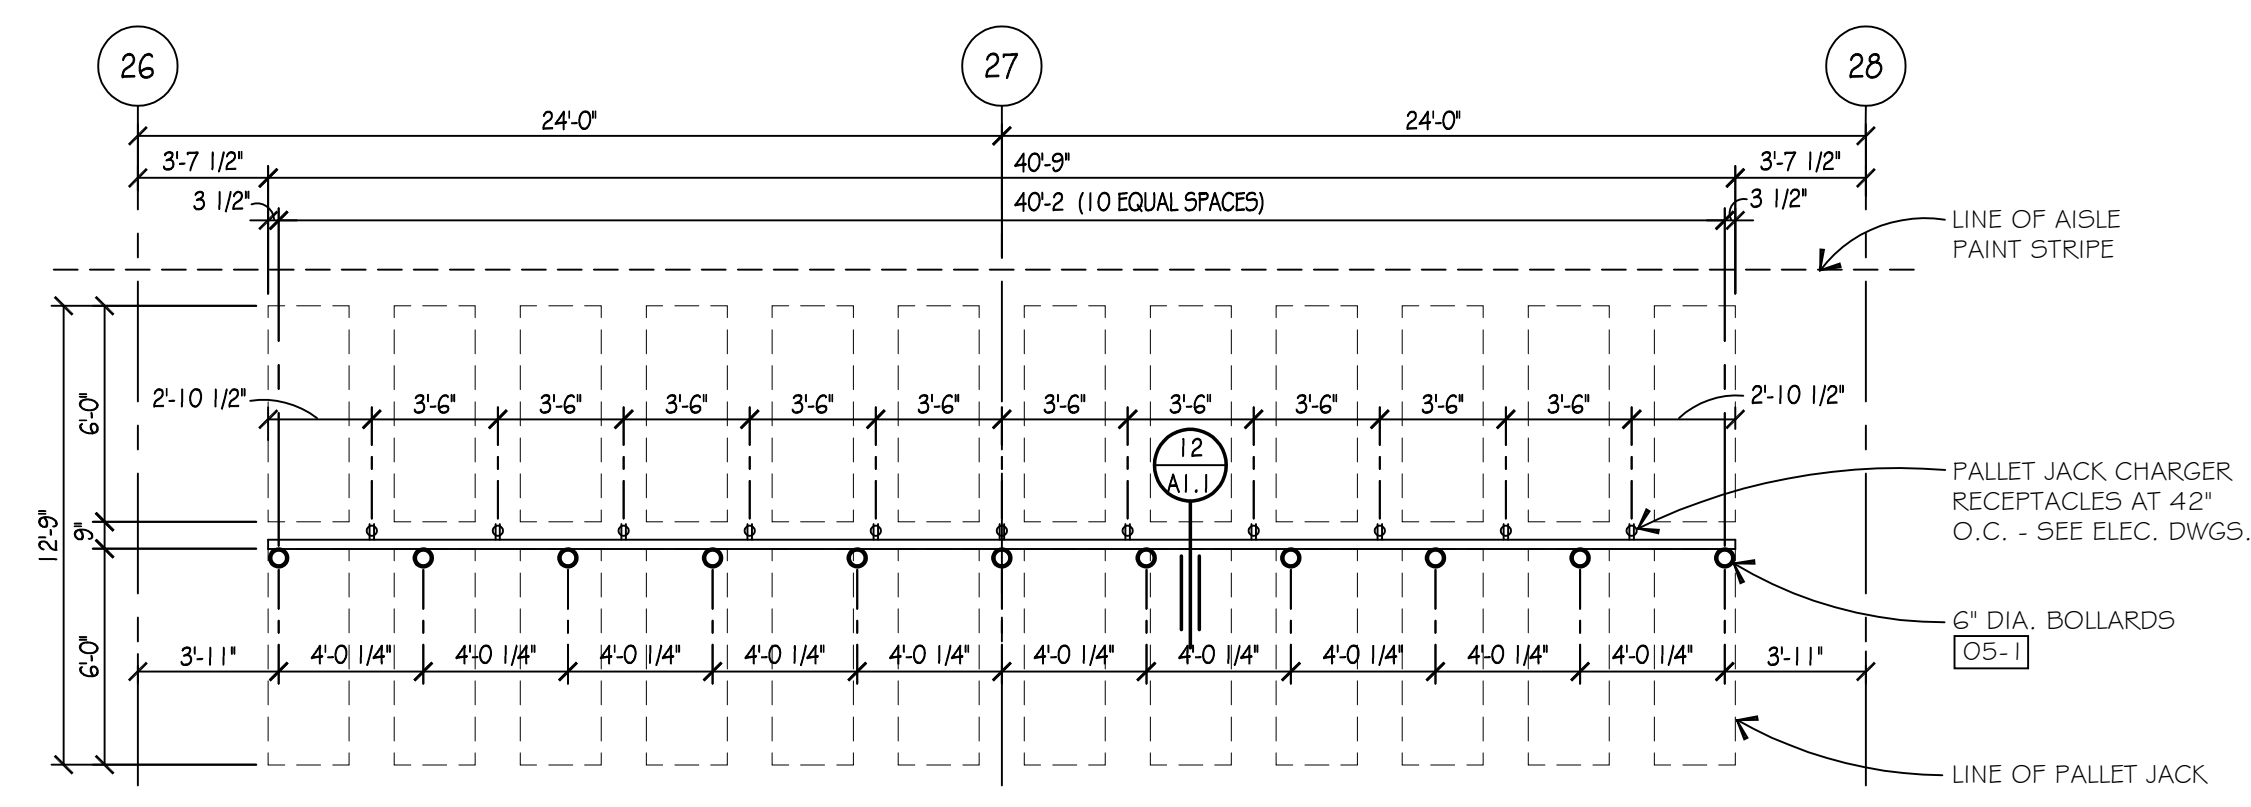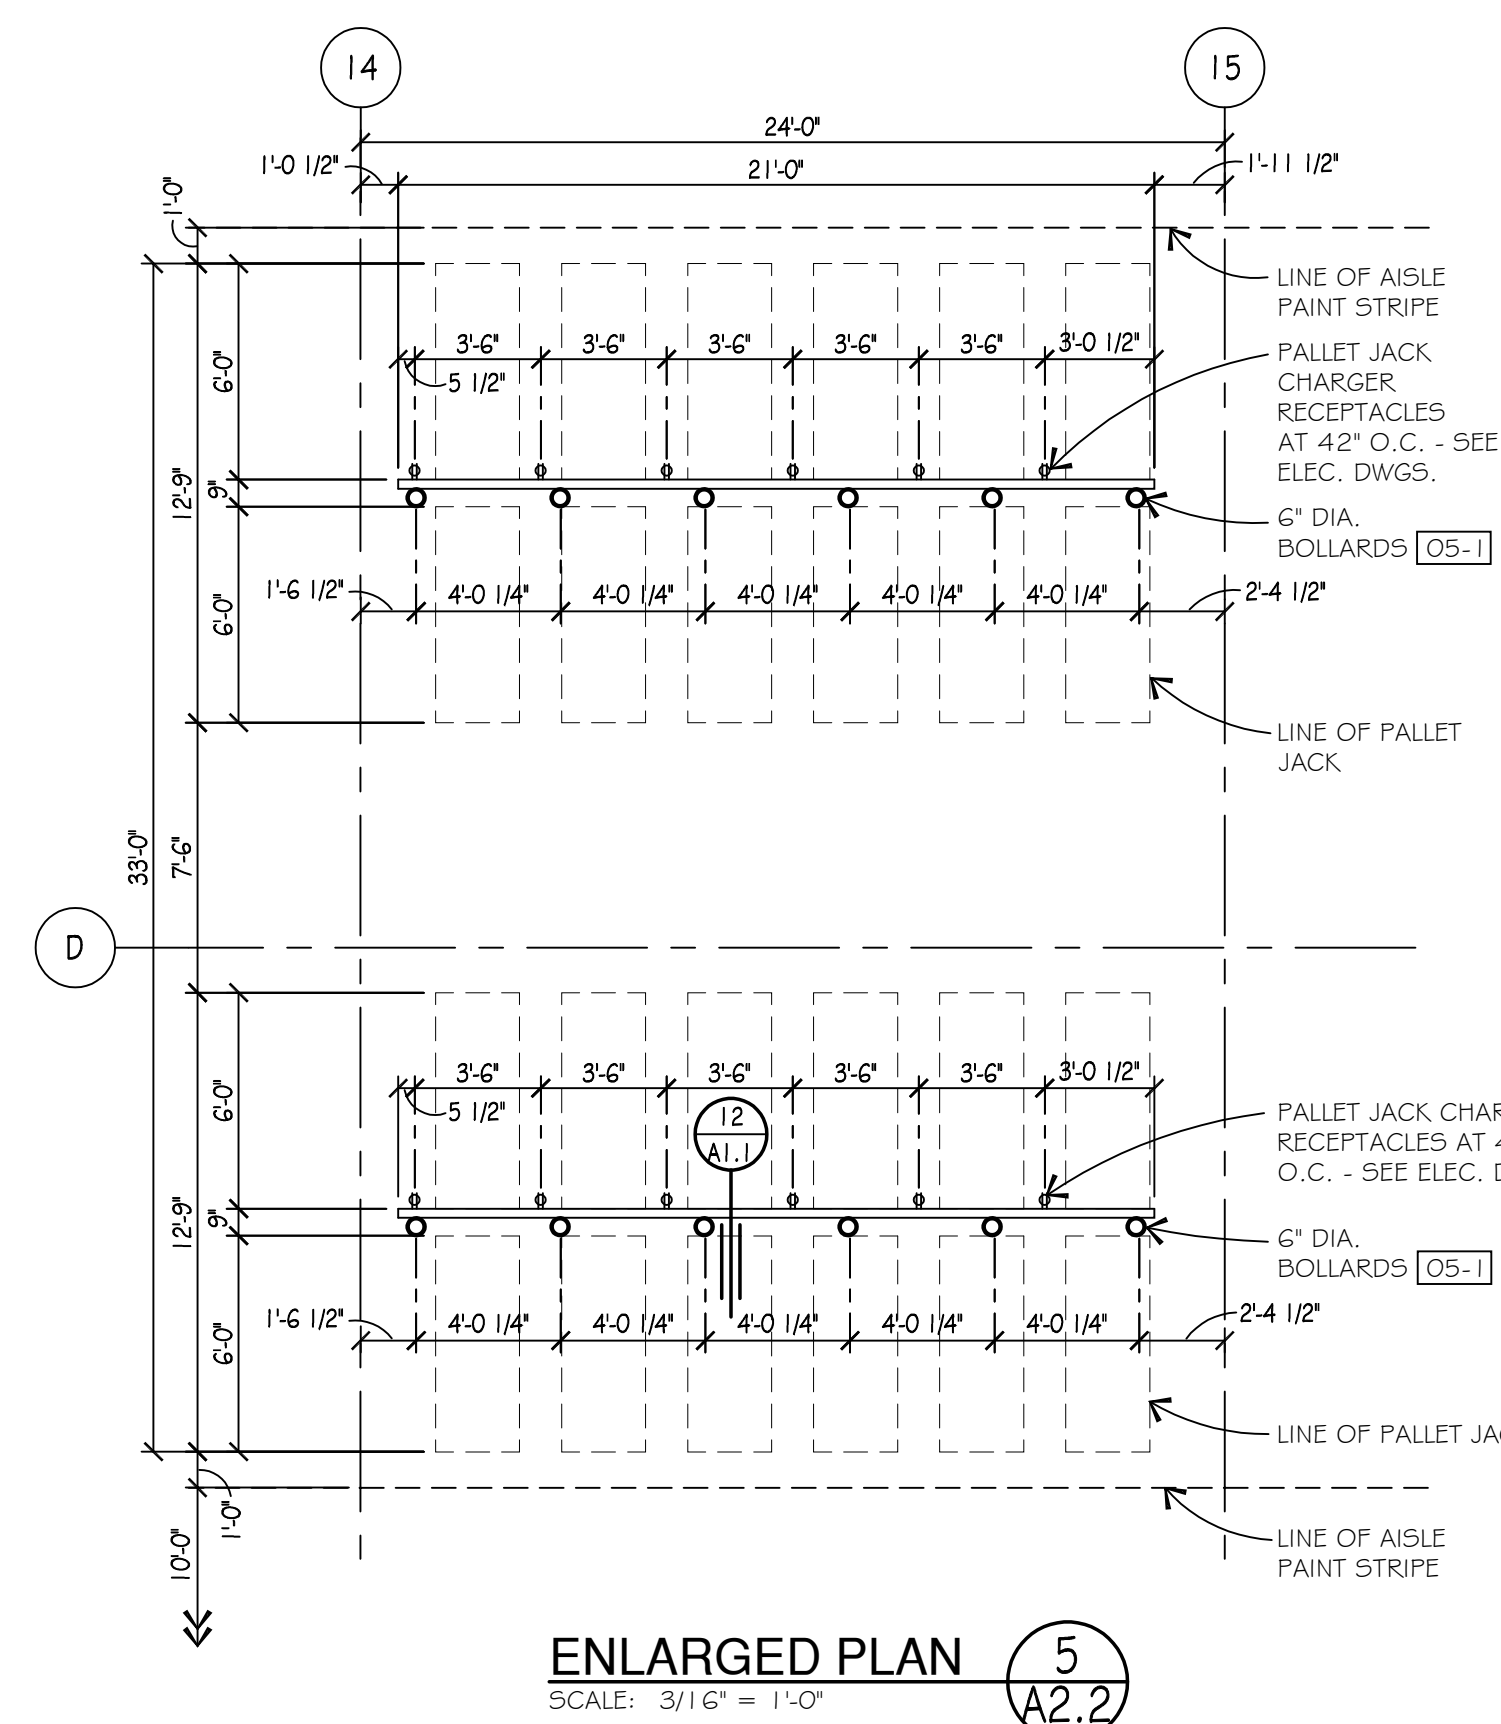

**Wah Yee Associates**  
**Architects & Planners**  
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 NOVI, MICHIGAN 48375  
 PHONE 248.489.9160

PROJECT  
R + L CARRIERS  
EDINBURGH, INDIANA

ate Issued

Job Number  
6147

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SHEET TITLE  
TERMINAL  
BUILDING 200  
FLOOR PLAN  
AND DETAILS

---

Sheet Number  
A2.3

	ROOM/AREA NAME	FLOORS			BASE		INT. WALLS				CEILING		REMARKS		
		FINISH			FINISH		FINISH				MATERIAL	HEIGHT			
ROOM NUMBERS		CONCRETE - SMOOTH, SEE SPCCS	POLISHED CONCRETE WITH NON-SLIP FINISH		NOIE	6" RUBBER BASE		CMU, PAINT	5/8" GYPSUM BOARD, PAINT MINITULL GRAY SW 7016	METAL WALL PANEL	CMU, EPOXY PAINT	GYP. BOARD - PAINT WHITE - FLAT LATEX	ACOUSTICAL TILE	OPEN TO STRUCTURE	NOTE: G.C. SHALL VERIFY PAINT COLORS, FINISH MATERIALS ANF FINISH MATERIAL LOCATIONS, ETC. WITH K.L. CARRIERS PRIOR TO COMMENCING
300	PARTS	●			●			●	●	●				●	
301	NORTH BAY	●			●			●	●	●				●	
302	SAFETY LANE	●			●			●		●					
303	SOUTH BAY	●			●			●	●	●				●	
304	OFFICE		●			●		●	●			CP1		9'-0"	
305	FIRE RISER		●		●			●	●				●	9'-0"	PROVIDE SIGNAGE ON DOOR INDICATING "FIRE RISER ROOM"
306	BREAKROOM		●		●	●		●	●			CP1		9'-0"	
307	OFFICE		●			●		●	●			CP1		9'-0"	
308	OFFICE		●			●		●	●			CP1		9'-0"	
309	COMPRESSOR	●			●			●				CP2		9'-0"	
310	ELECTRICAL		●		●			●				CP2		9'-0"	
311	JANITOR		●		●			●				CP2		9'-0"	
312	WOMEN		●		●					●		CP1		9'-0"	
313	SHOWER		●		●					●	●			9'-0"	
314	MEN		●		●					●		CP1		9'-0"	
315	CORRIDOR		●			●		●				CP1		9'-0"	
316	I.T. ROOM	●			●			●				CP2		9'-0"	

SCALE: 1/4" = 1'-0"


01	COFFEE MAKER, PROVIDED BY OWNER, INSTALLED BY GENERAL CONTRACTOR.
02	STAINLESS STEEL TRENCH DRAIN, SLOPE FLOOR TO DRAIN - SEE PLUMBING DRAWINGS.
03	PROVIDE LOUVERS IN HOLLOW METAL DOORS (24" X 24") AS SHOWN. VERIFY LOUVER SIZE PRIOR TO INSTALLATION.
04	HI-LO ADA COMPLIANT WATER FOUNTAINS. SEE PLUMBING DRAWINGS.
05	SAFETY EMERGENCY EYE WASH STATION. SEE PLUMBING DRAWINGS.
06	SERVICE SINK. SEE PLUMBING DRAWINGS.
07	PROVIDE PANTED HARDWOOD SILL AT INTERIOR OF WINDOW LOCATIONS.
08	PROVIDE LOCKERS IN MEN'S TOILET ROOM, 2 TIER, COMPOSITE MATERIAL (WITH BASE) TO MATCH TOILET PARTITIONS, (110 COUNT STANDARD HASP LOCK/KEY, SEE SPECIFICATIONS
09	ALL TOILETS/URINALS/FAUCET IN TOILET ROOM TO BE AUTOMATIC WITH BATTERY, BREAK ROOM SINK TO BE MANUAL. SEE PLUMBING DRAWINGS.
10	STAINLESS STEEL SINK. SEE PLUMBING DRAWINGS.
11	PLASTIC LAMINATE COUNTERTOP WITH WALL AND BASE CABINETS.
12	ADA FOLDING SHOWER SEAT. SEE SPECIFICATIONS
13	FLOOR MOUNTED ICE MAKER PROVIDED BY OWNER, INSTALLED BY GENERAL CONTRACTOR.
14	REFRIGERATOR, PROVIDED BY OWNER. INSTALLED BY GENERAL CONTRACTOR.
15	MICROWAVE ABOVE SINK, PROVIDED BY OWNER INSTALLED BY GENERAL CONTRACTOR.
16	COMPRESSOR NOTE: COMPRESSOR TO BE SUPPLIED & INSTALLED BY CONTRACTOR. SPECS. TO BE APPROVED BY OWNER. AIR LINES TO BE INSTALLED BY CONTRACTOR. OWNER WILL SUPPLY HOSE REELS, INSTALLED BY CONTRACTOR. 1/4" TURN VALVES TO BE INSTALLED AT EACH HOSE REEL.
17	4' X 6' X 3/4" F.R.T. PAINTED PLYWOOD BACK BOARD

1	8" CMU TO 1'-0" O.C. F.F., ABOVE 1'-0" TO DECK (OR STRUCT.) PROVIDE 6" METAL STUDS AT 1'-0" O.C. WITH 1 LAYER OF 5/8" GWS EACH SIDE. PROVIDE MOISTURE RESISTANT GAB ON SERVICE DAY SIDE. PROVIDE DEFLECTION TRACK AT WALL HEAD PER DETAIL 1'-0" MIN. ABOVE FINISH FLOOR.
1A	SAME AS WALL #1 WITH 6" BATT INSULATION FULL HEIGHT.
2	8" CMU TO 1'-0" O.C. F.F., REINFORCE PER STRUCTURAL. INTERIOR FINISHES AS NOTED ON SCHEDULE (TILE OR PAINT).
3	8" BLOCK MASONRY <u>04-48</u> FROM FOUNDATION TO 8'-0" ABOVE FINISH FLOOR WITH EXTERIOR PIPING WALL/ST SYSTEM WITH MPR VINYL COVERED R-25. R-10 MIN. BATT INSULATION FROM 8'-0" O.C. F.F. TO ROOF. INTERIOR SIDE TO BE 3-5/8" METAL STUDS AT 1'-0" O.C. WITH 1 LAYER 5/8" GWS TO 1'-0" F.F., FILL WITH R-13 BATT INSULATION WITH VAPOR BARRIER.

Architectural floor plan of the New Maintenance Building, 19,800 S.F. The plan shows a central building with various rooms including Parts, Safety Bay, Maintenance Bays, Trailer Bays, and Tractor Bays. It also includes a Service Bay and a South Bay. The building is surrounded by a parking area with marked spaces and a safety lane. The plan is oriented with North at the top. Dimensions are provided for the building and surrounding areas. A note indicates that the assumed finish floor is 100'-0" and the actual finish floor is 66'-00". A coordinate system is shown with letters A through L and numbers 1 through 17. A note at the top right states: "COORDINATE LOCATION OF WEIGH SCALE WITH CIVIL DRAWINGS". A note at the bottom right states: "NOTES: 1. GENERAL CONTRACTOR IS TO PROVIDE BLOCKING AS REQUIRED TO MOUNT THE WEIGH SCALE DISPLAY. SEAL ALL WALL PENETRATIONS WATERTIGHT. VERIFY FINAL MOUNTING HEIGHT AND LOCATION WITH E.I. CARRIERS". A note at the bottom left states: "BUILDING MOUNTED WEIGH SCALE DISPLAY. SEE NOTE 1". A note at the top left states: "WEIGH SCALE DISPLAY. SEE NOTE 1". A note at the bottom center states: "ASSUMED FINISH FLOOR = 100'-0" ACTUAL FINISH FLOOR = 66'-00"

SCALE: 1/16" = 1'-0"





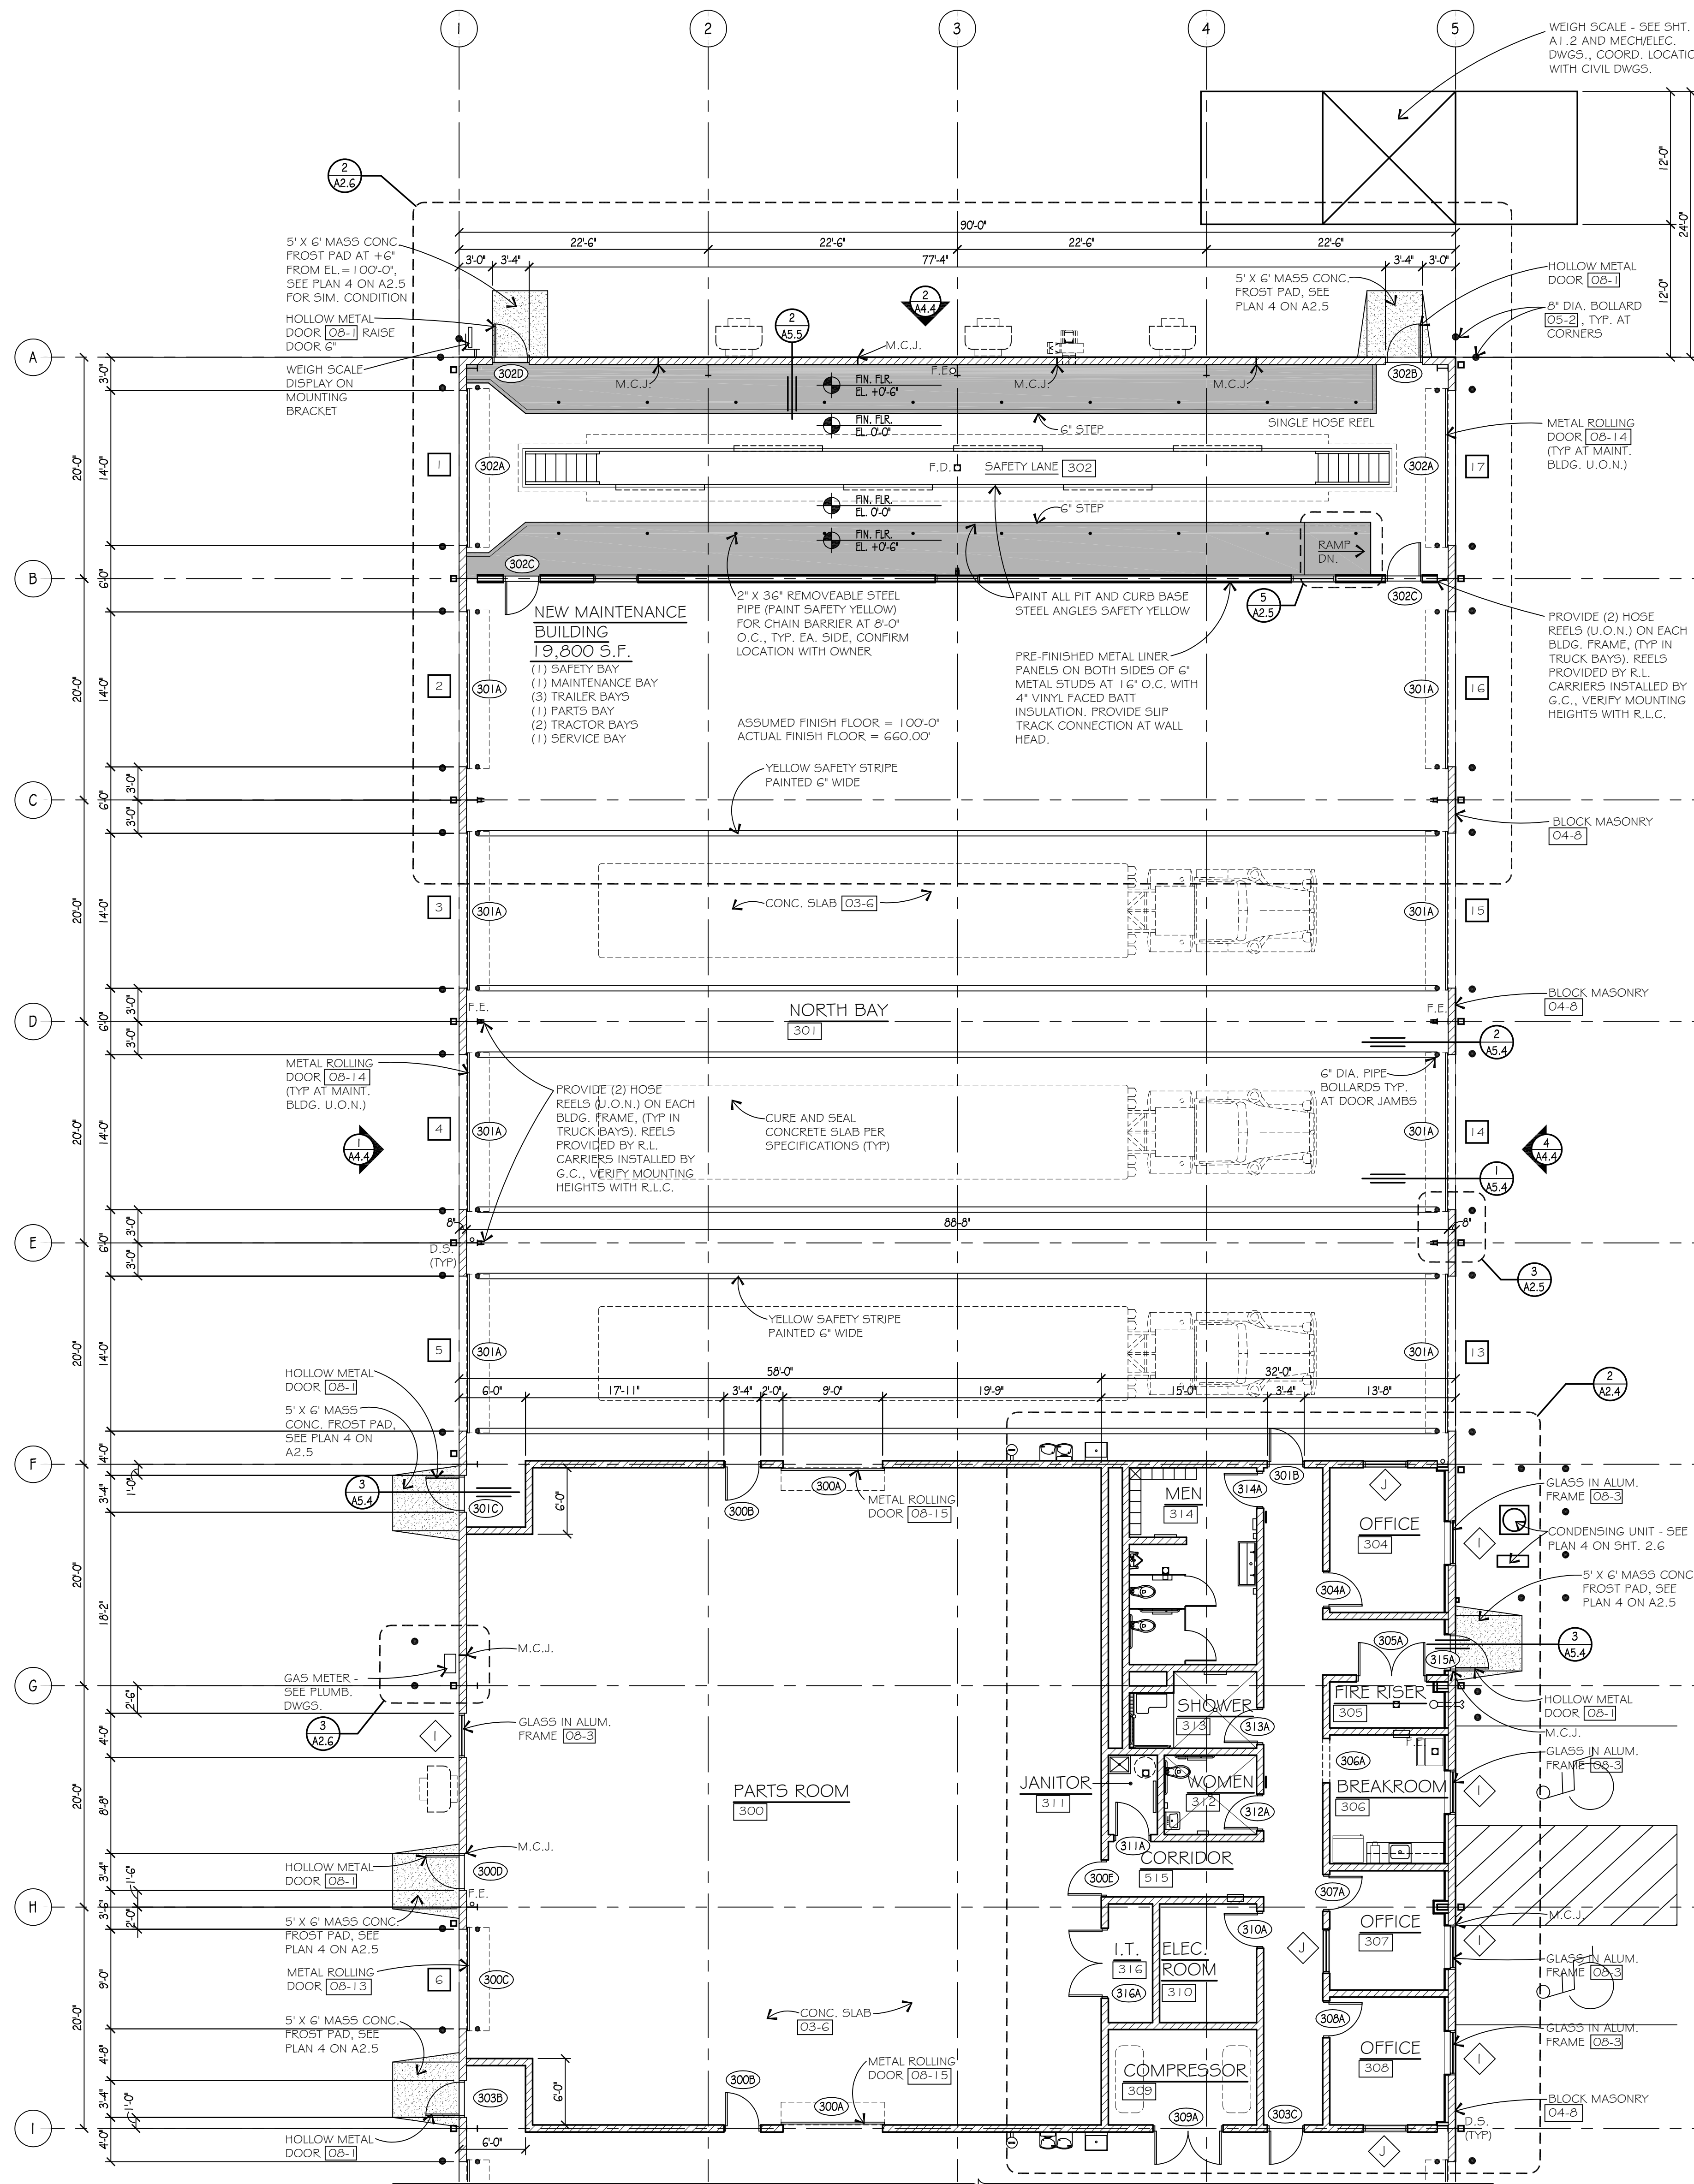

ENLARGED MAINTENANCE BUILDING 300 PLAN

SCALE: 1/8" = 1'-0"



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A2.4

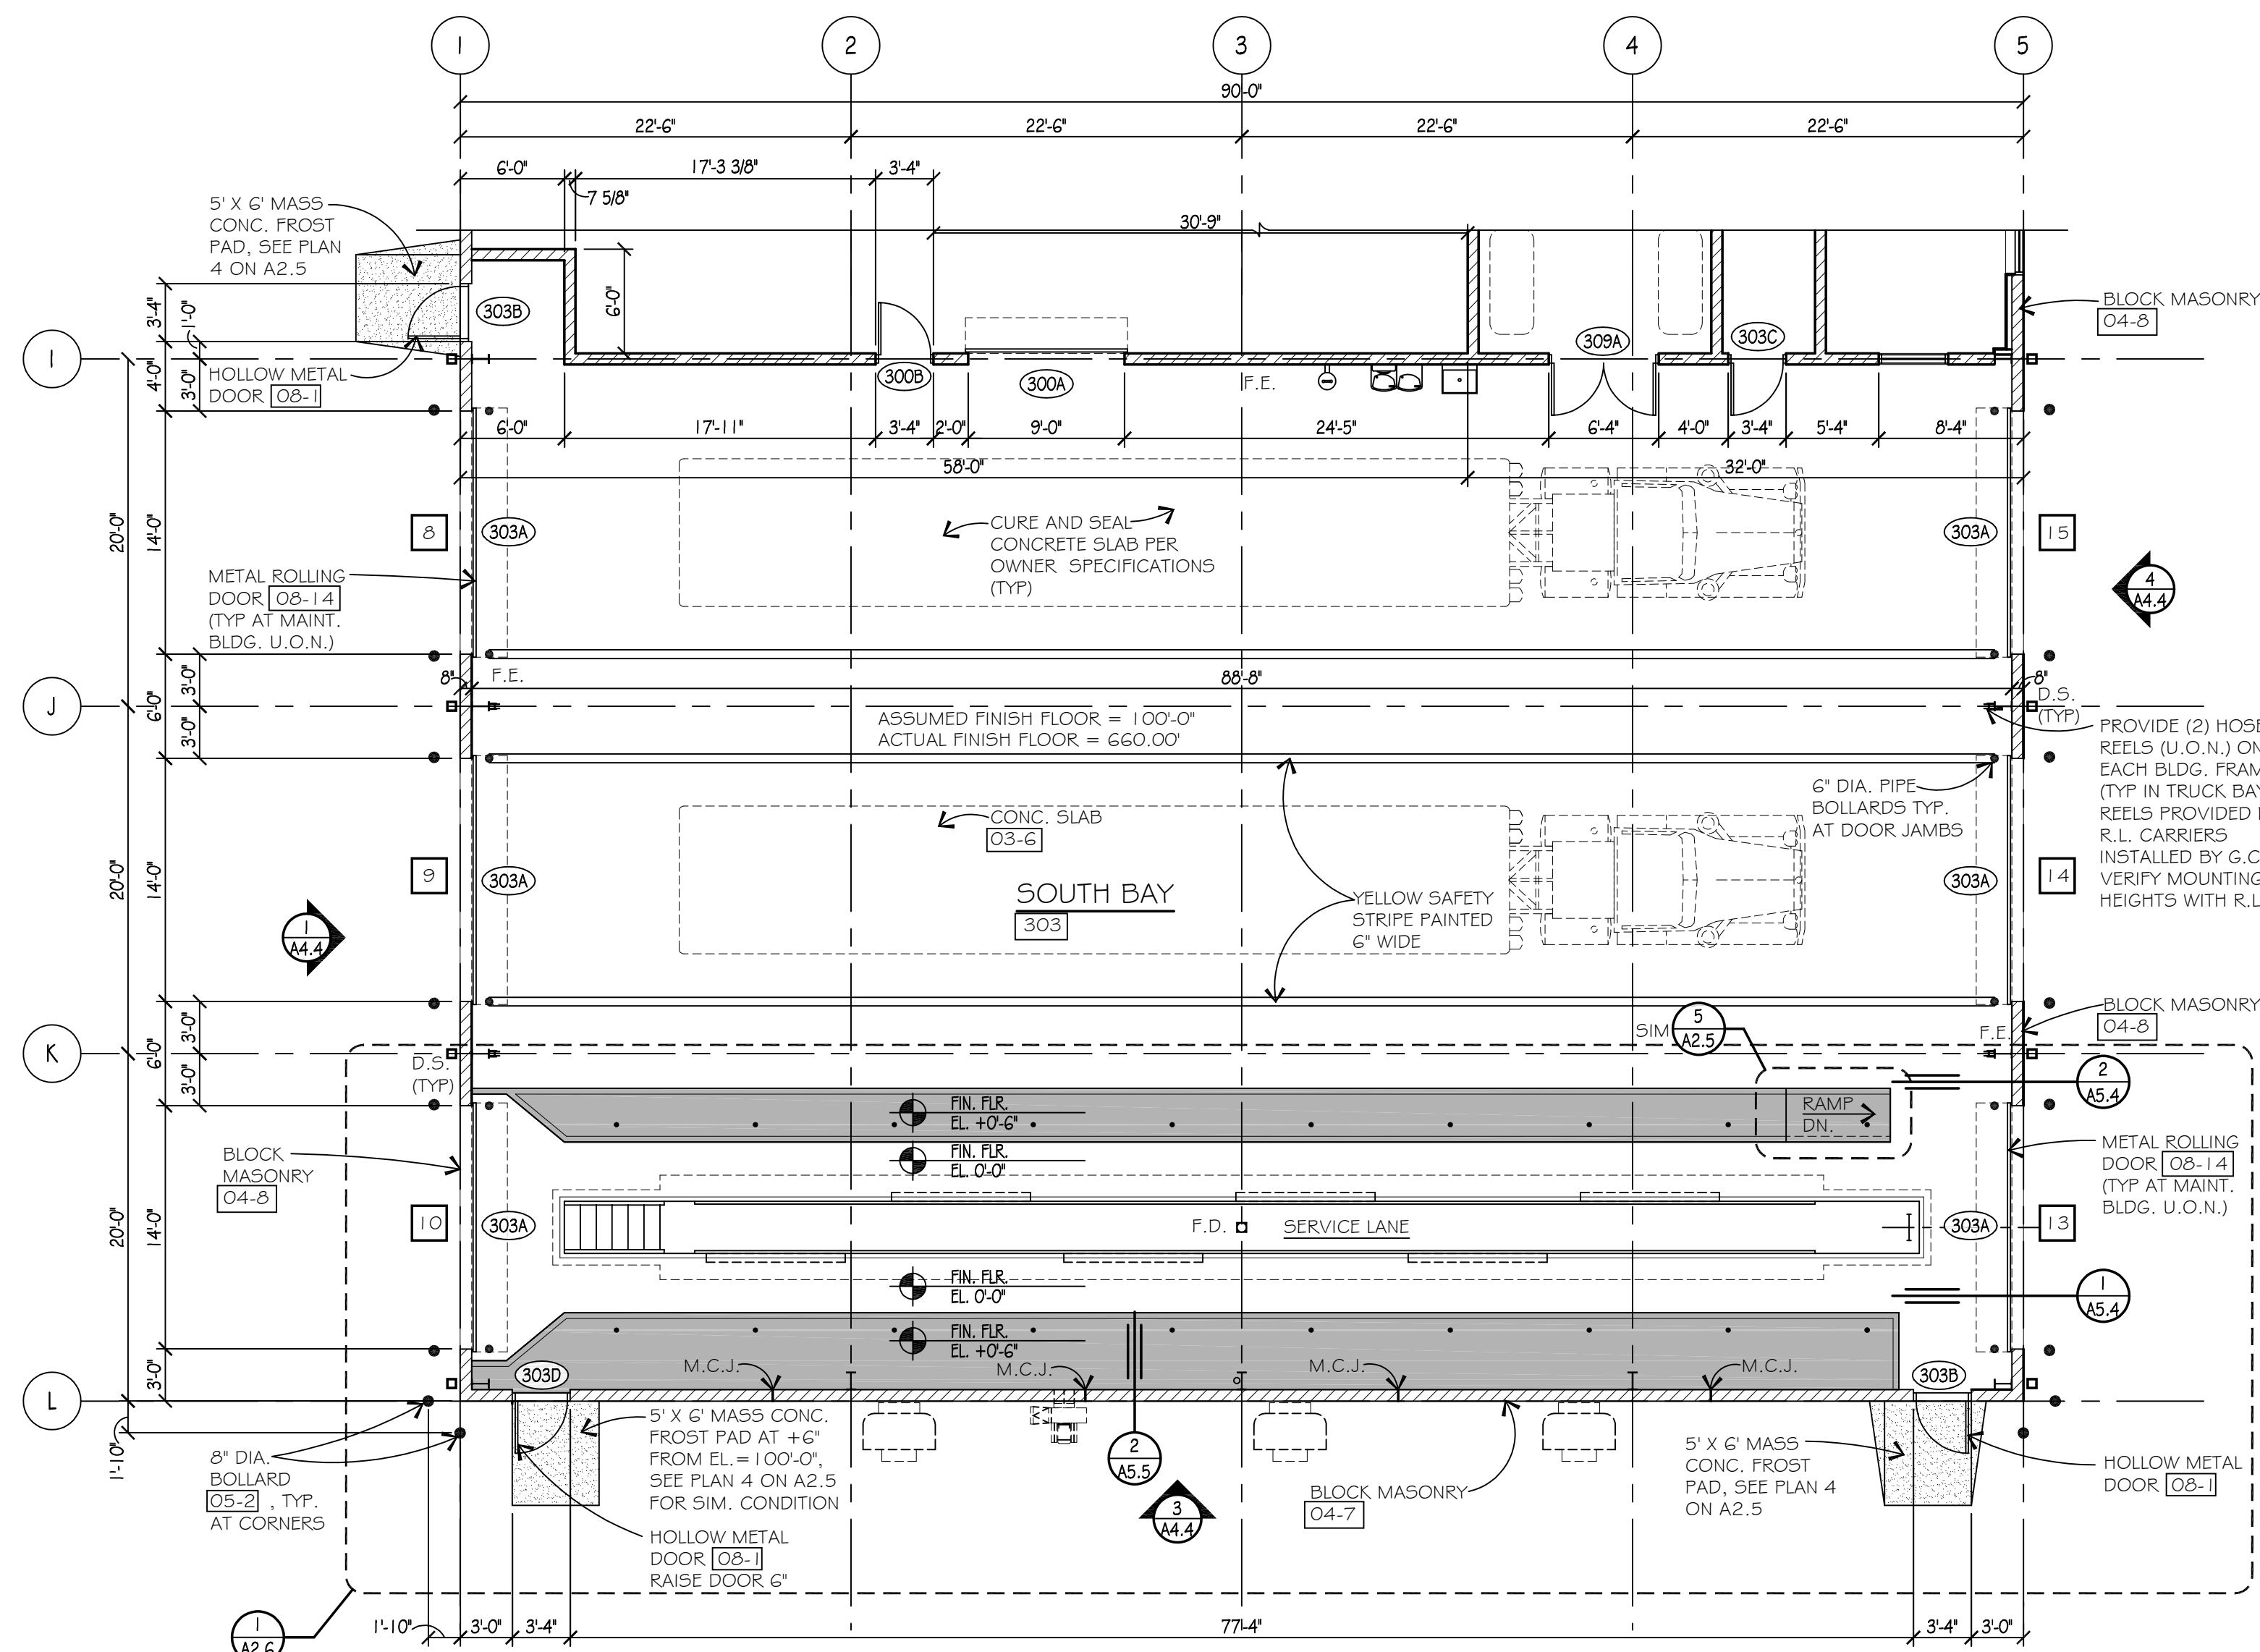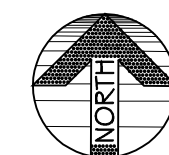

ENLARGED MAINTENANCE BUILDING 300 PLAN

SCALE: 1/8" = 1'-0"


1  
A2.4

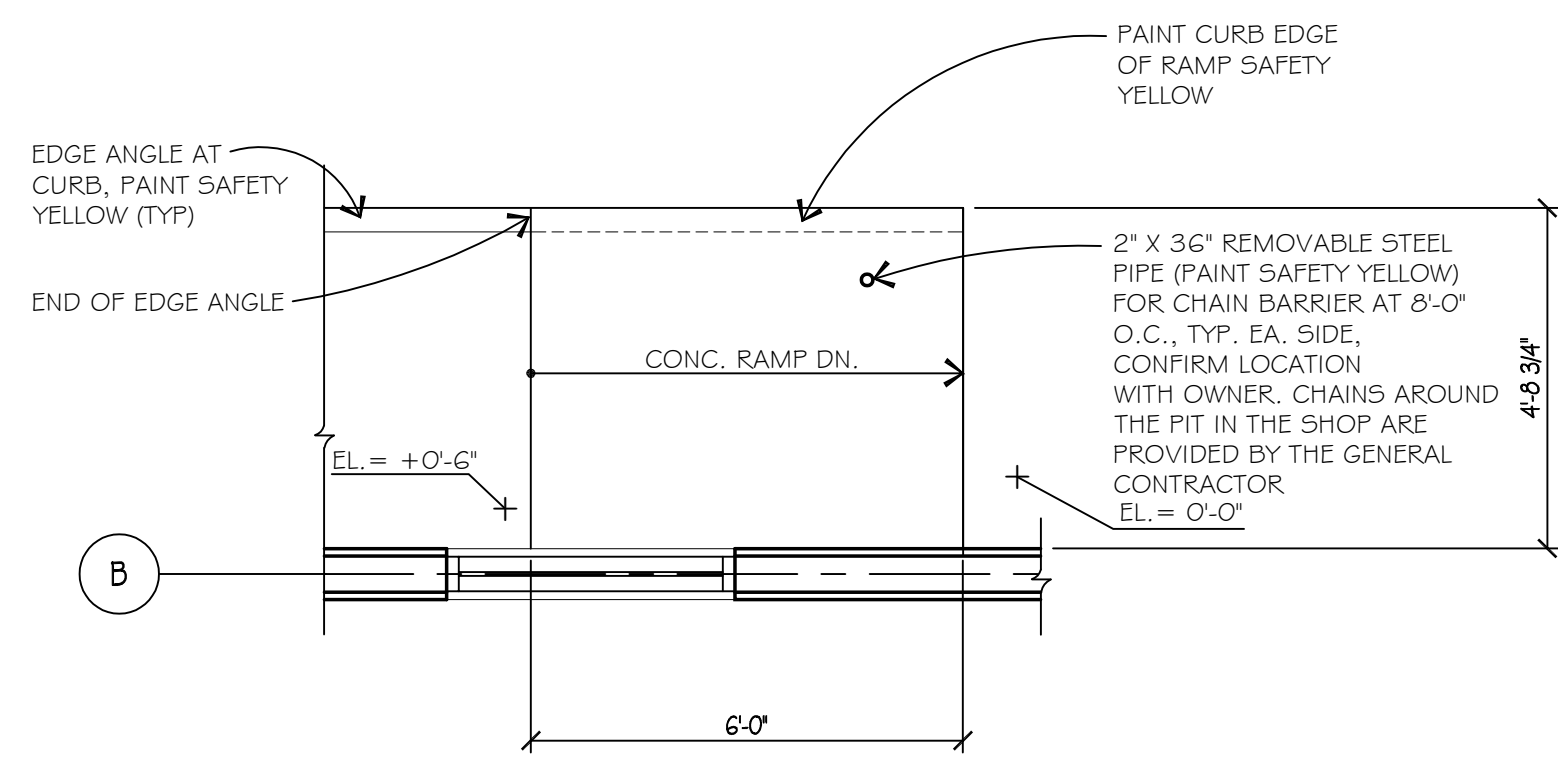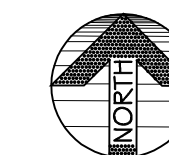

RAMP PLAN

SCALE: 3/8" = 1'-0"


5  
A2.5, A2.6

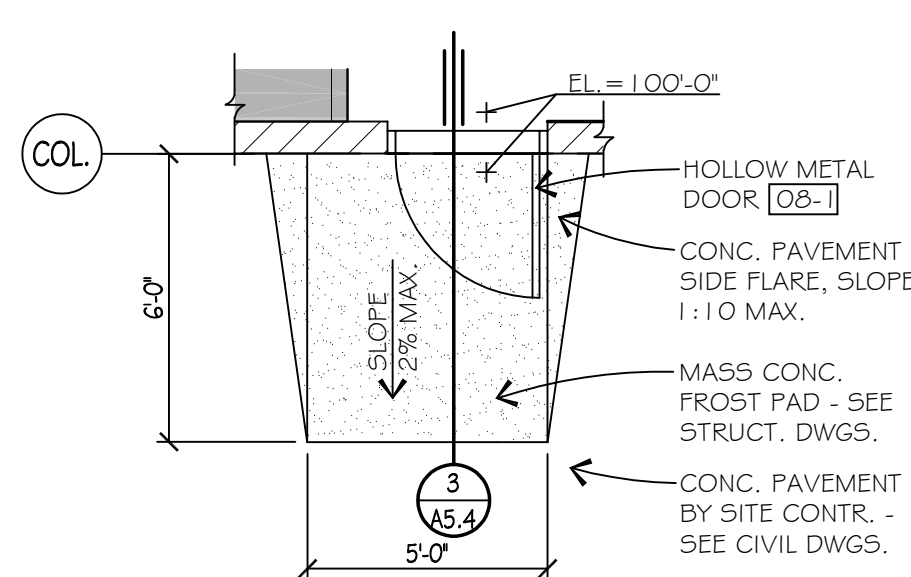

CONCRETE PAD PLAN

SCALE: 1/4" = 1'-0"


4  
A2.5, A2.6, A2.8

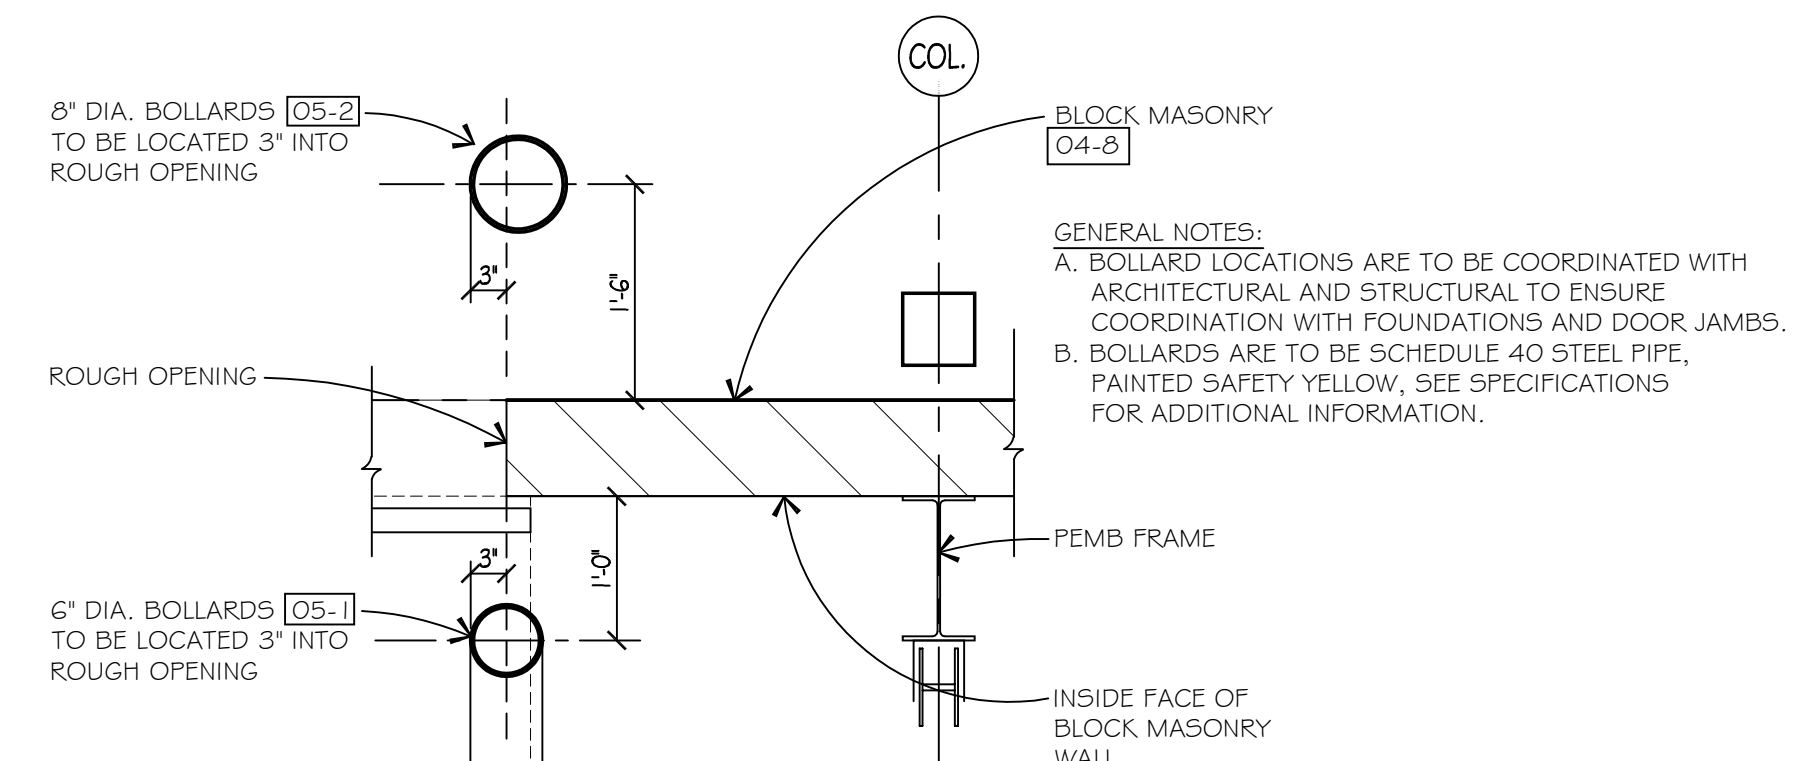


TYPICAL MAINTENANCE BUILDING OPENING PROTECTION

SCALE: 3/4" = 1'-0"


3  
A2.5, A2.6

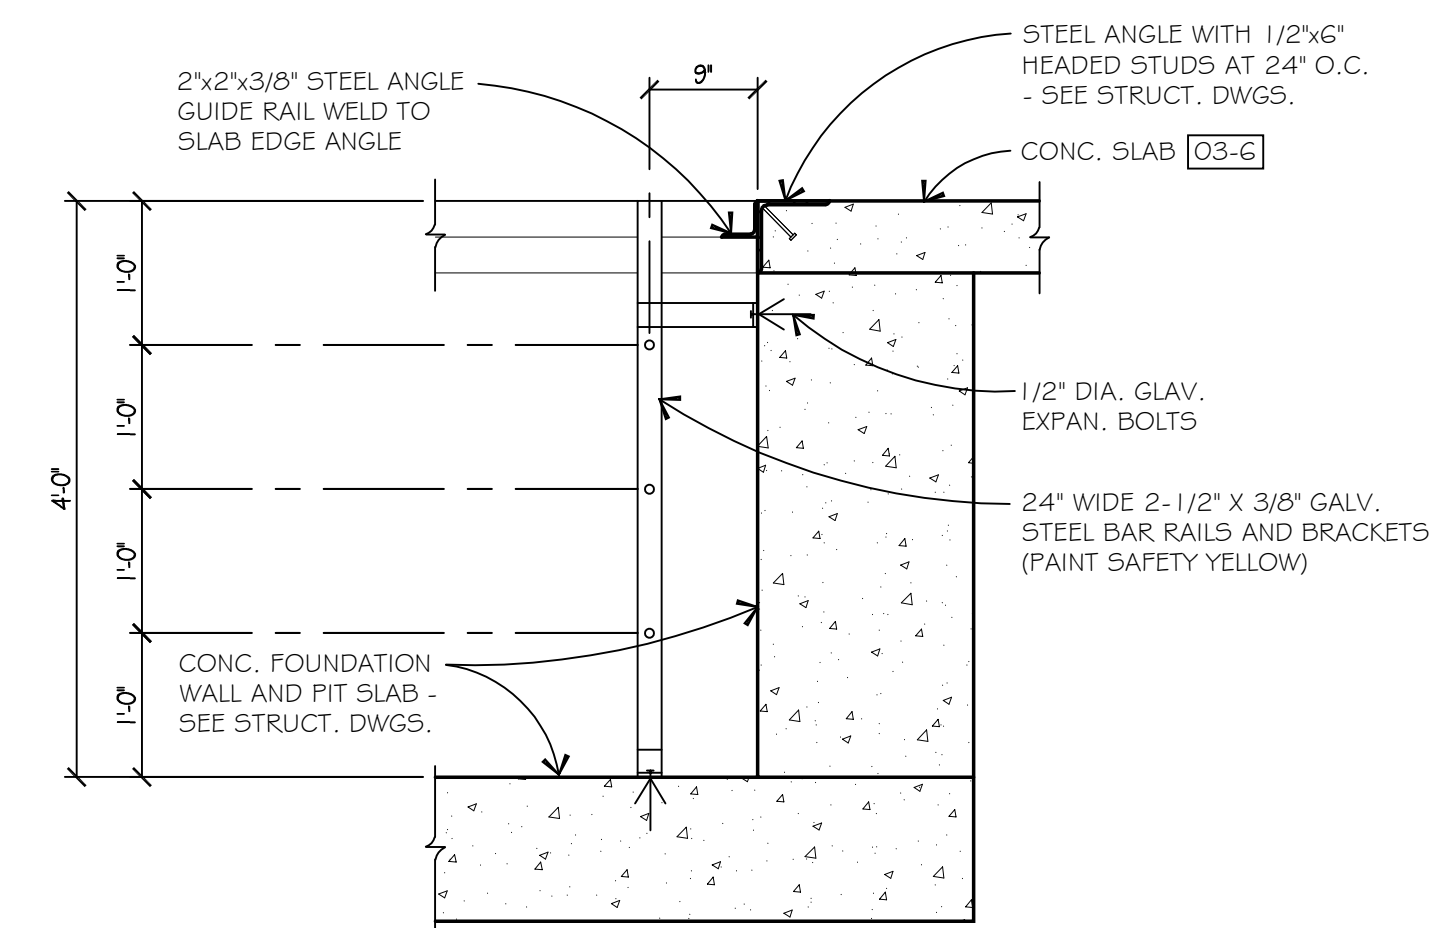


SECTION 6  
SCALE: 3/4" = 1'-0"

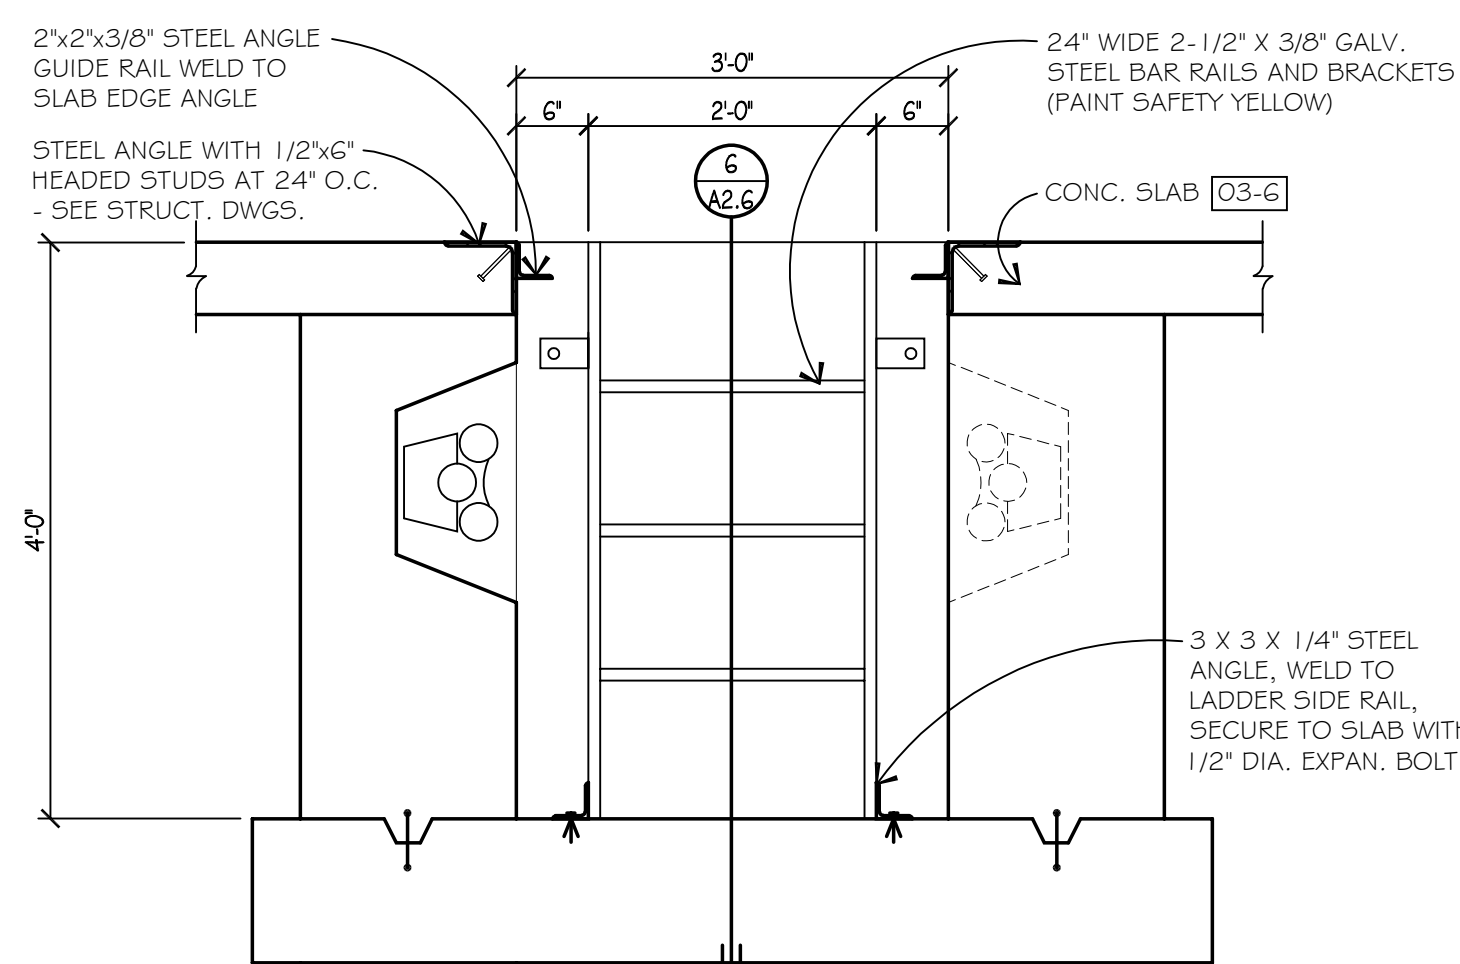


ELEVATION 5  
SCALE: 3/4" = 1'-0"

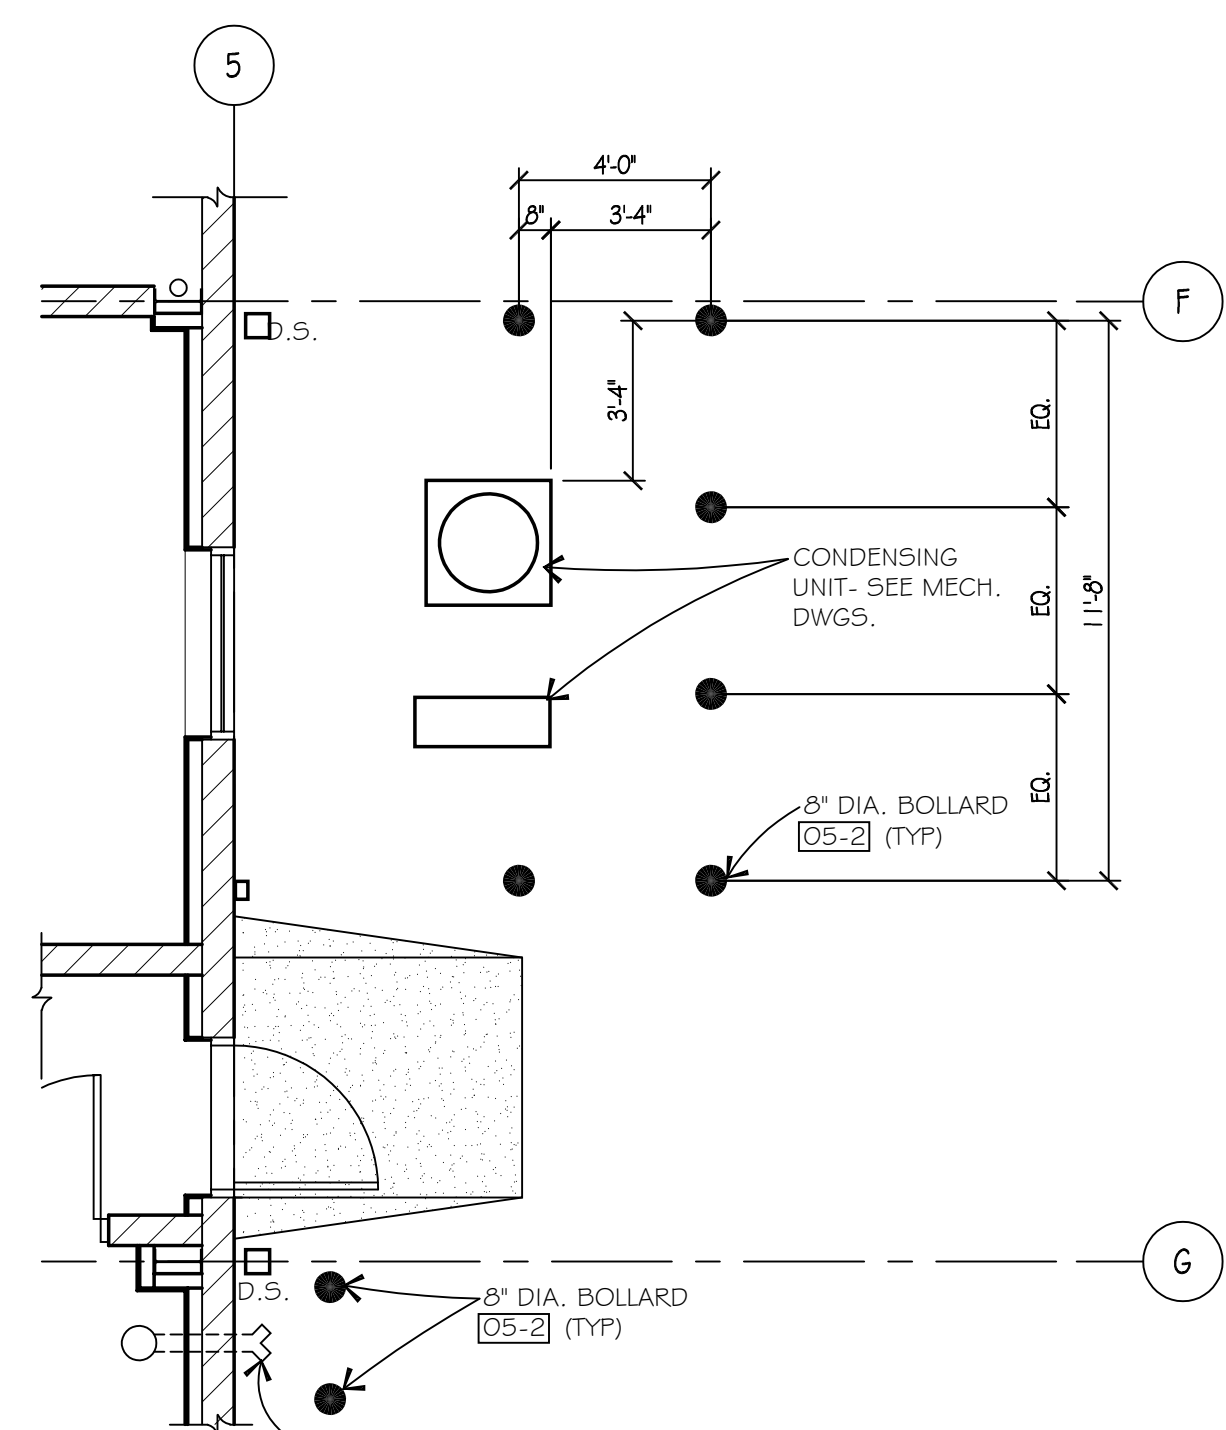


PLAN 4  
SCALE: 1/4" = 1'-0"

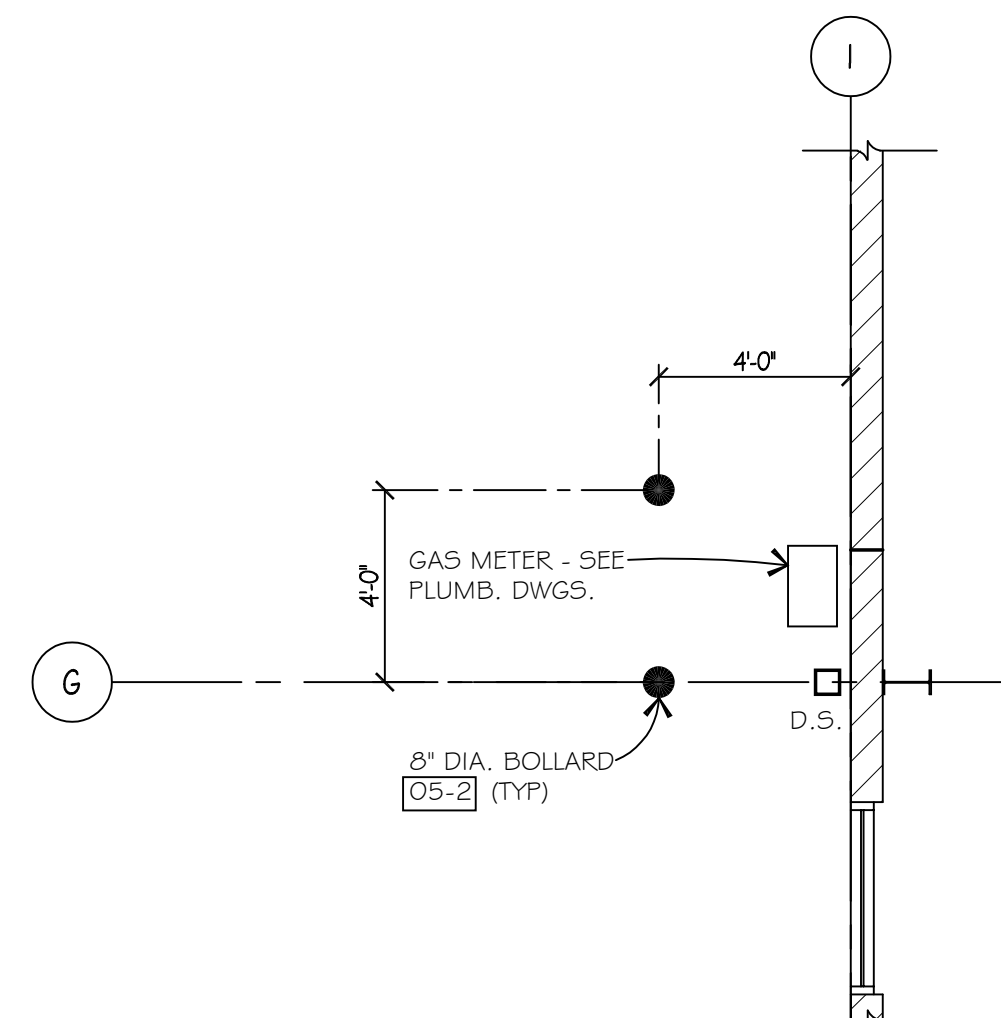

PLAN 3  
SCALE: 1/4" = 1'-0"

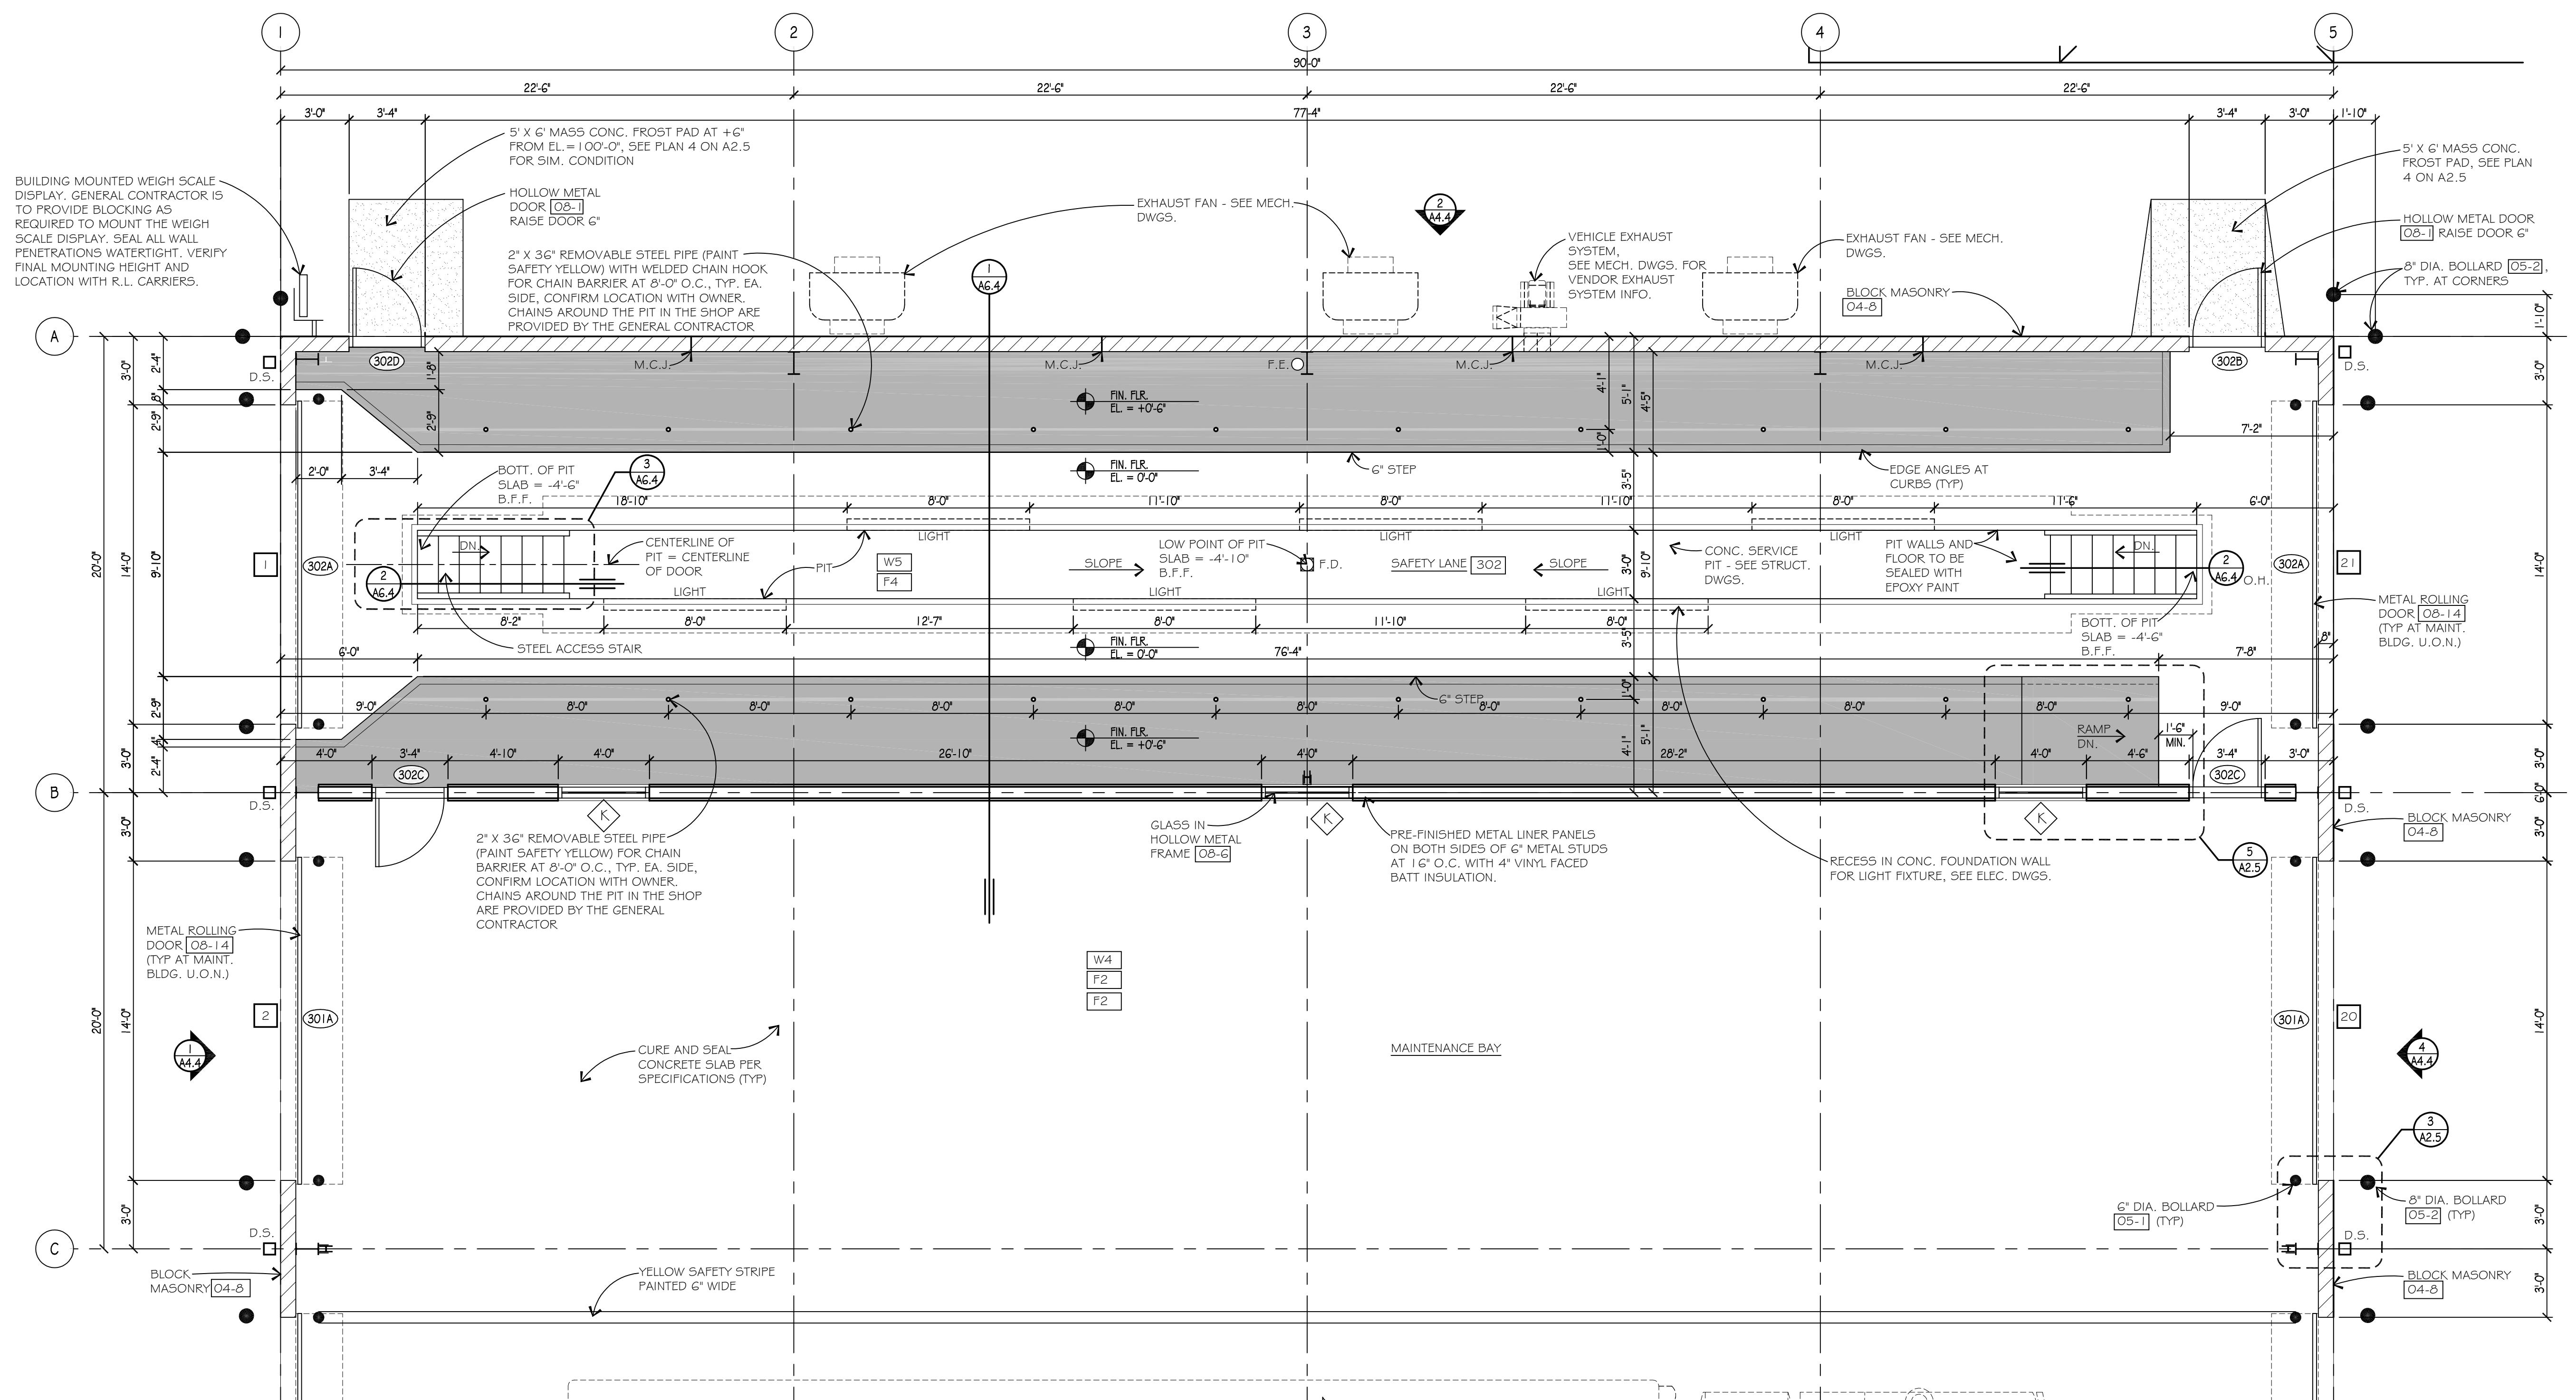


SAFETY BAY ENLARGED PLAN 2  
SCALE: 1/4" = 1'-0"

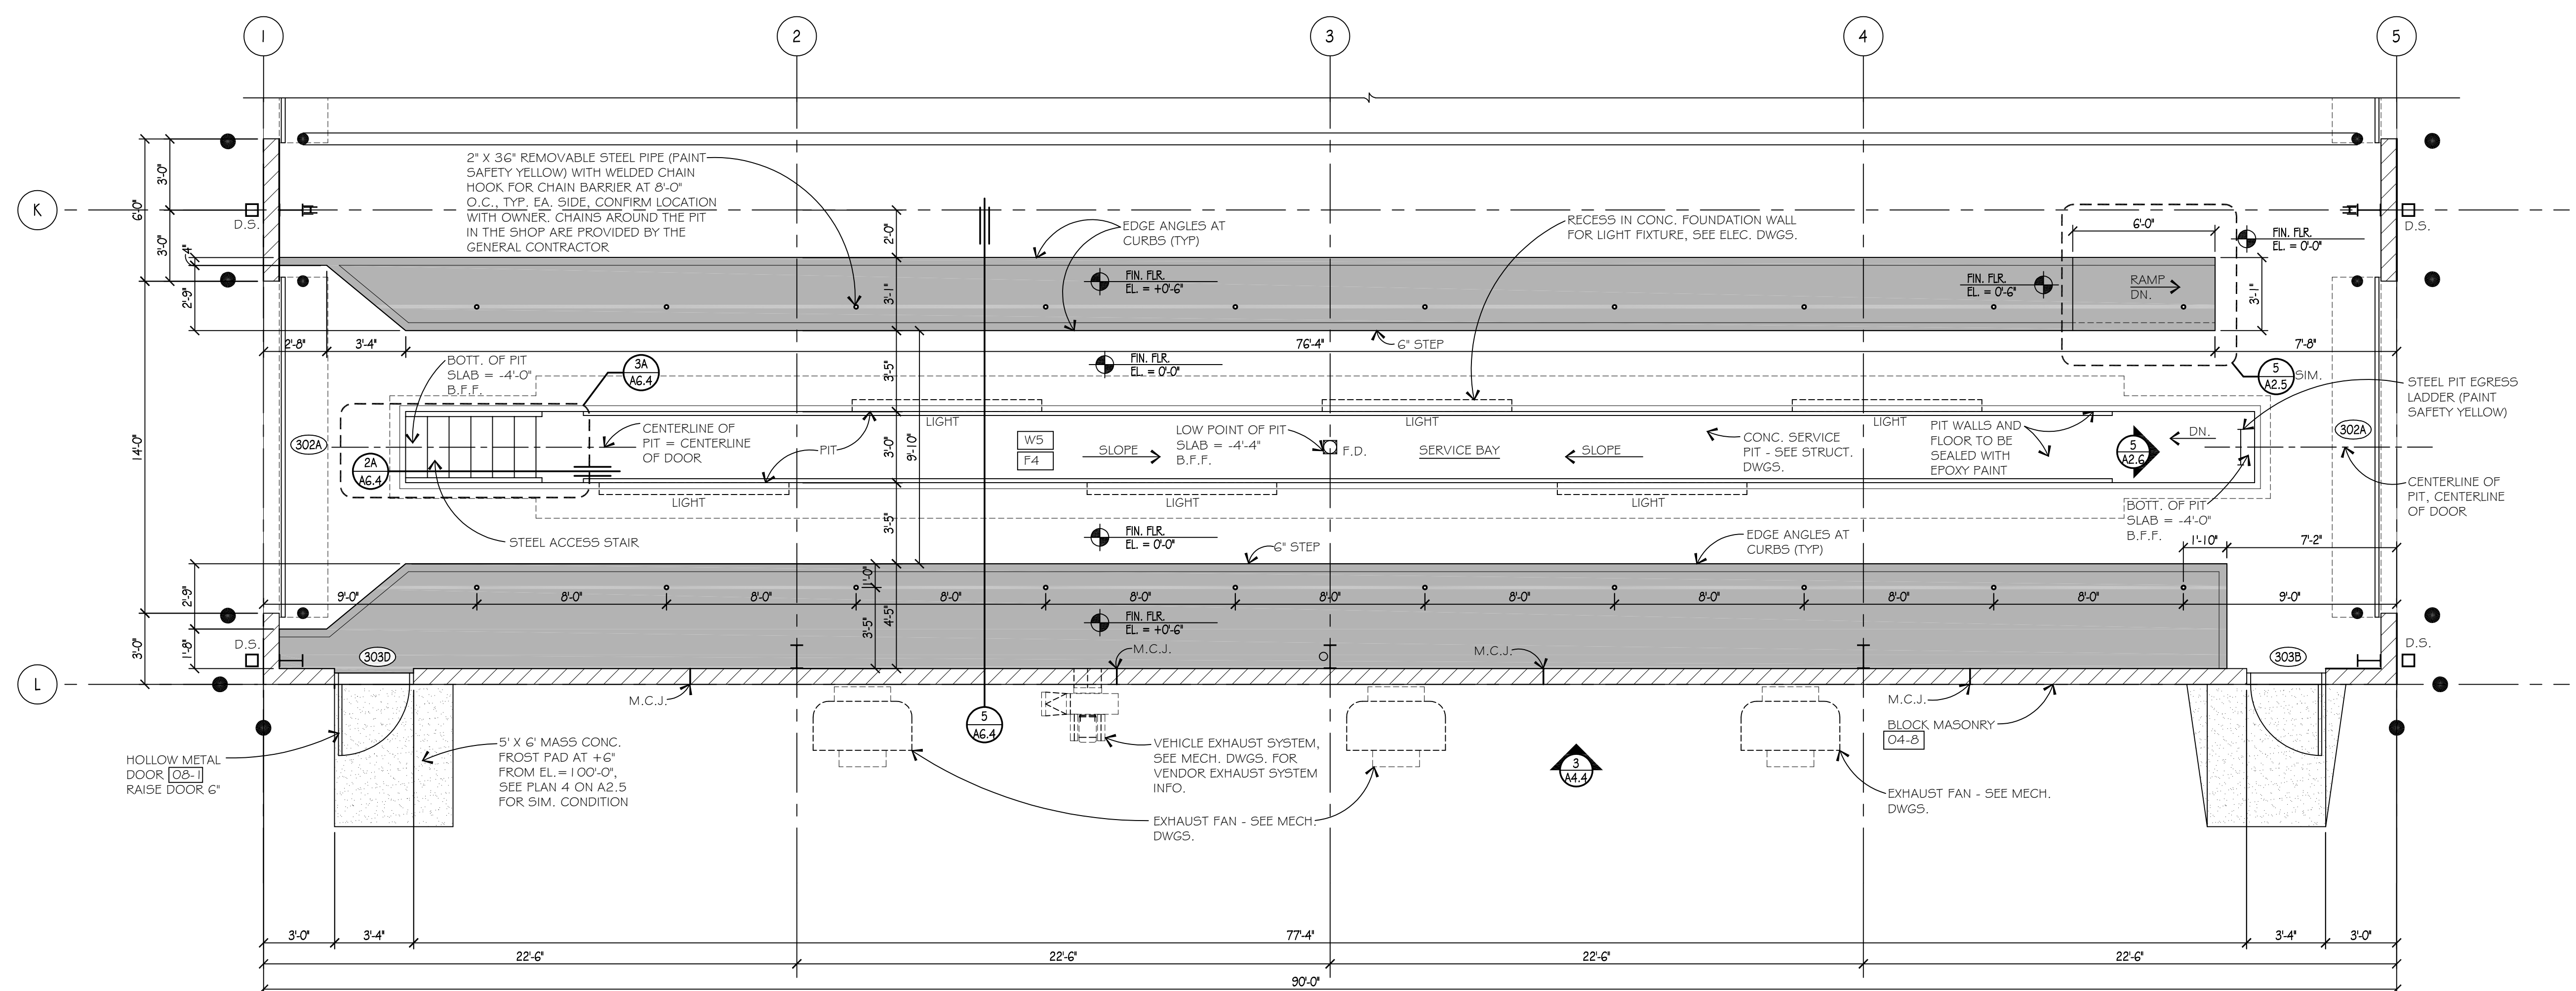


SERVICE LANE ENLARGED PLAN 1  
SCALE: 1/4" = 1'-0"




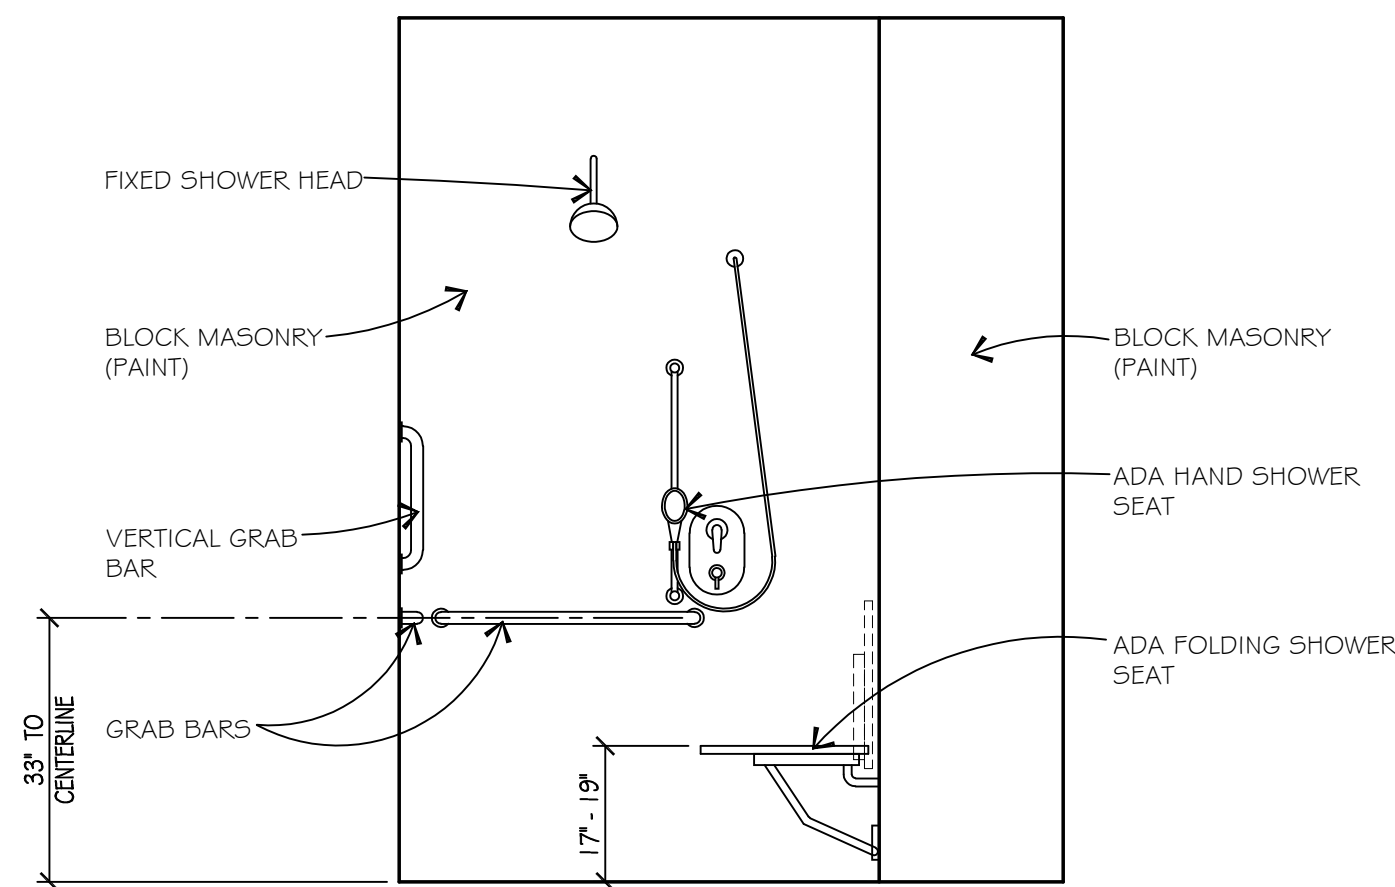


**SHOWER ELEVATION**  
SCALE: 1/2" = 1'-0"

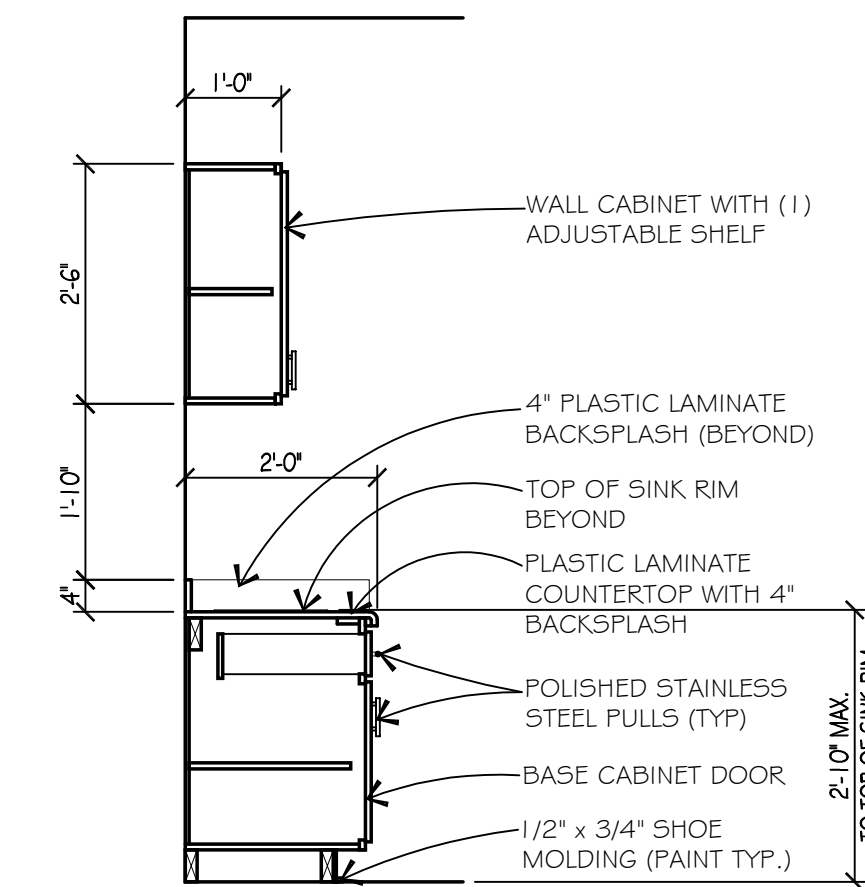


CABINET SECTION

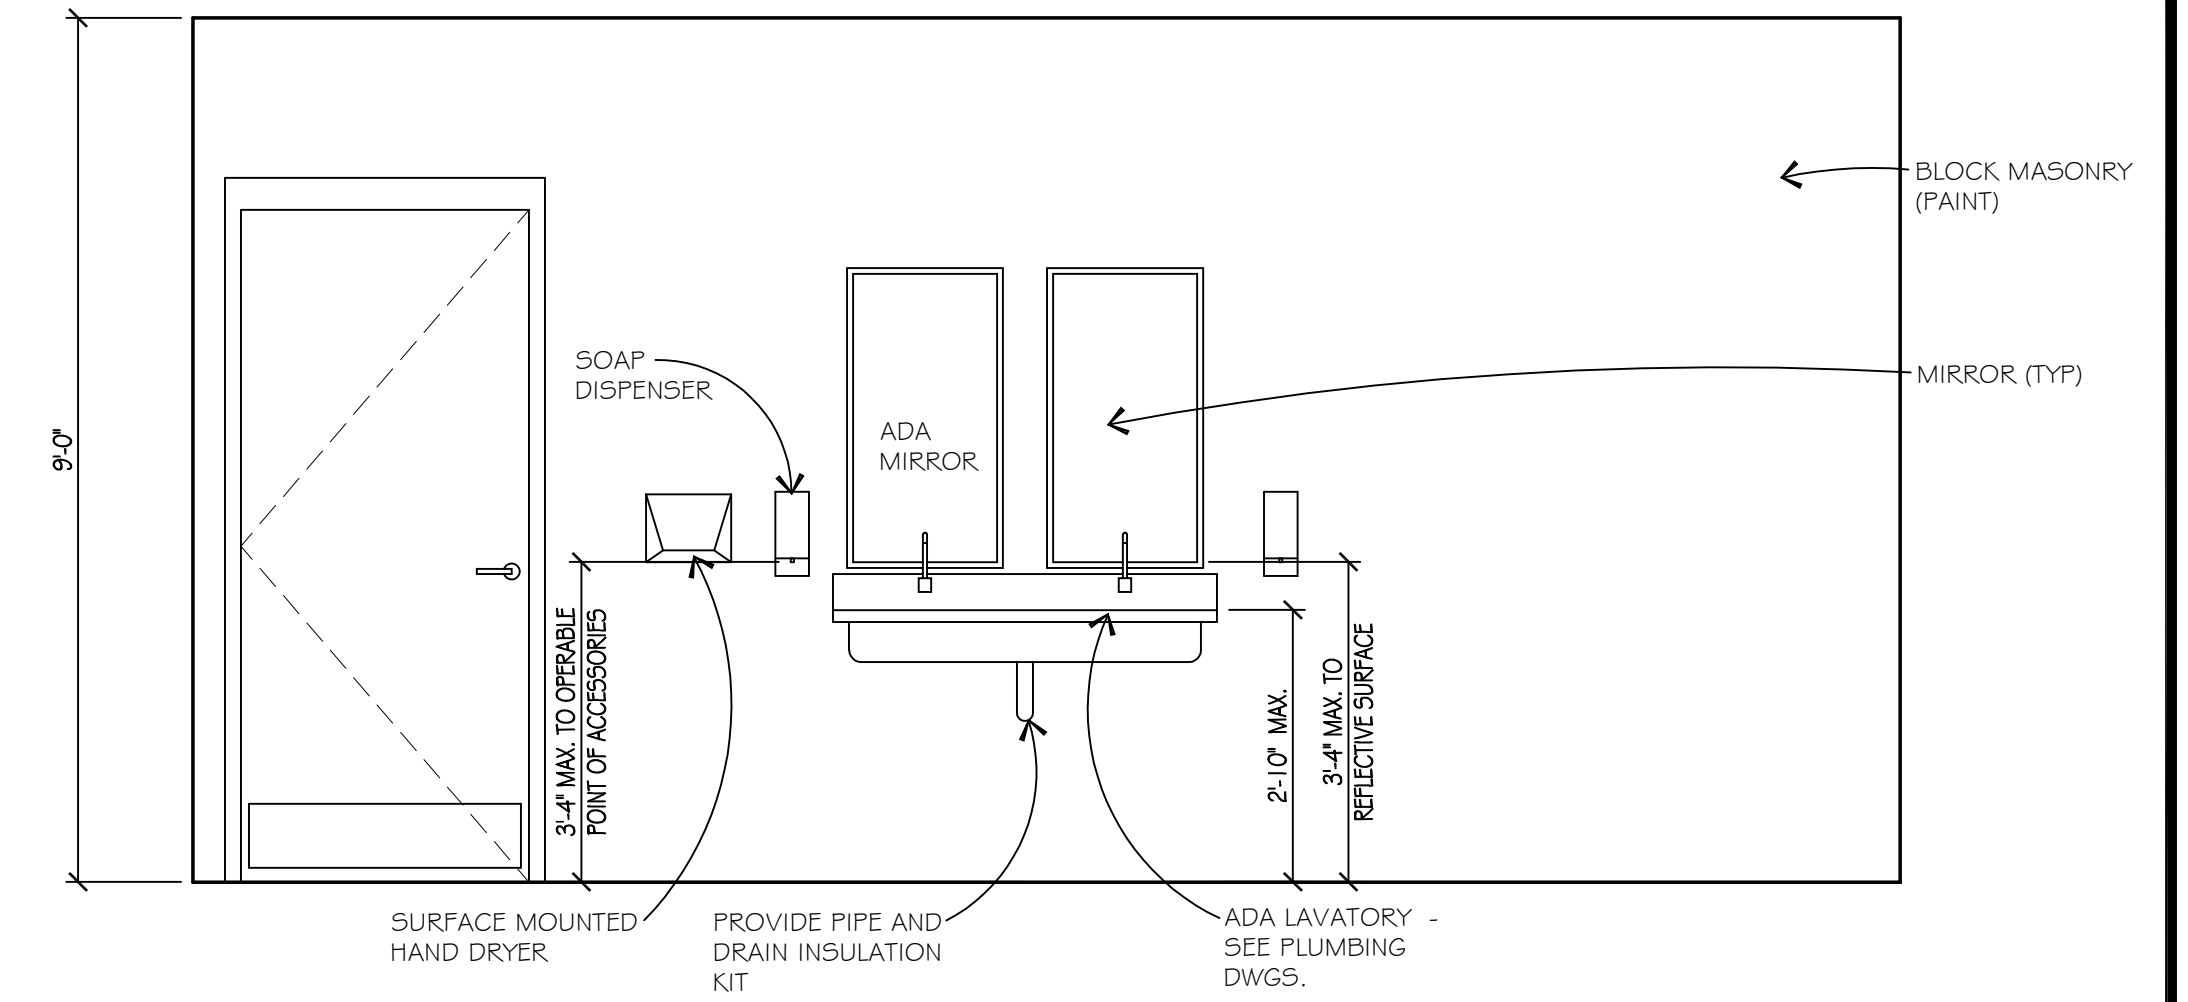


**MEN'S TOILET ROOM ELEVATION**  
SCALE: 1/2" = 1'-0"

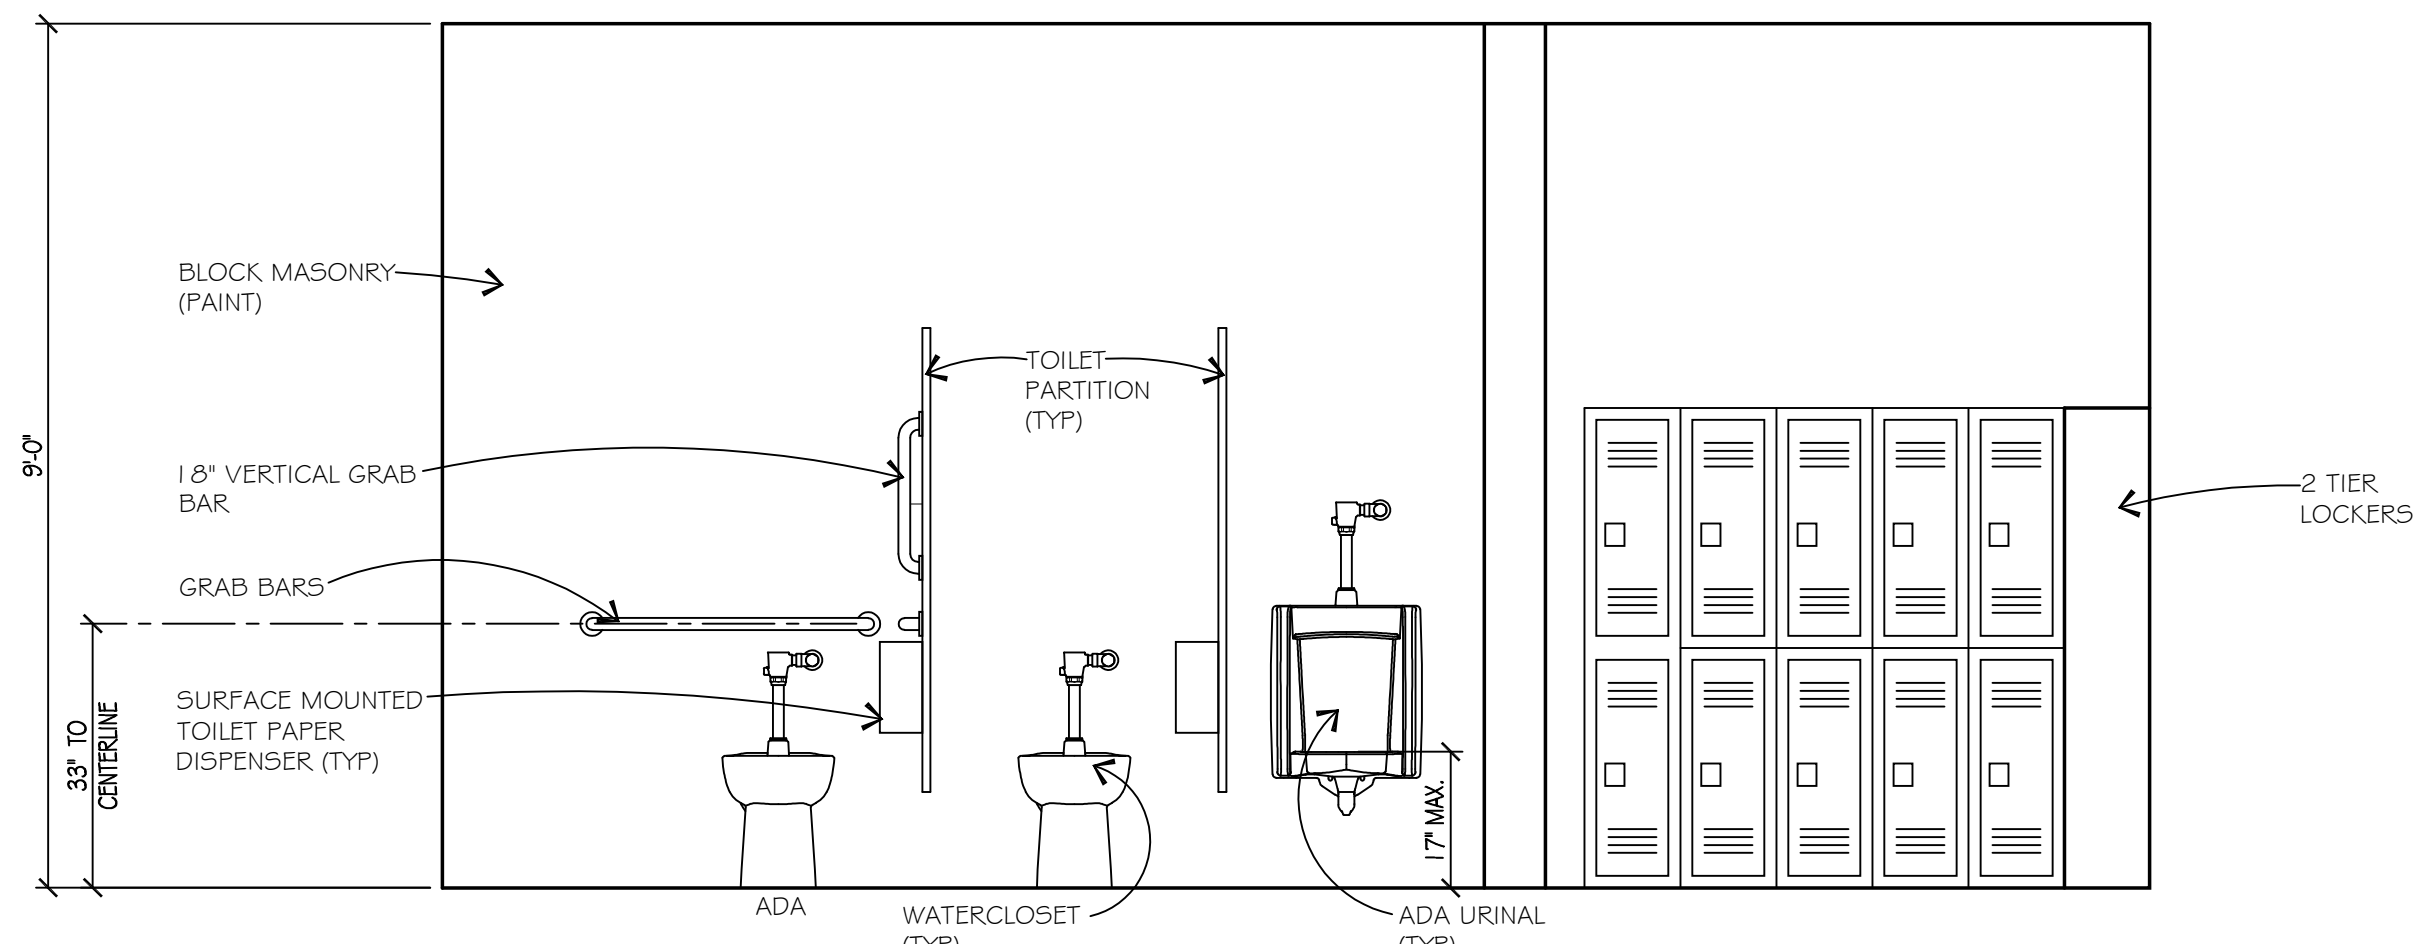


**MEN'S TOILET ROOM ELEVATION**  
SCALE: 1/2" = 1'-0"

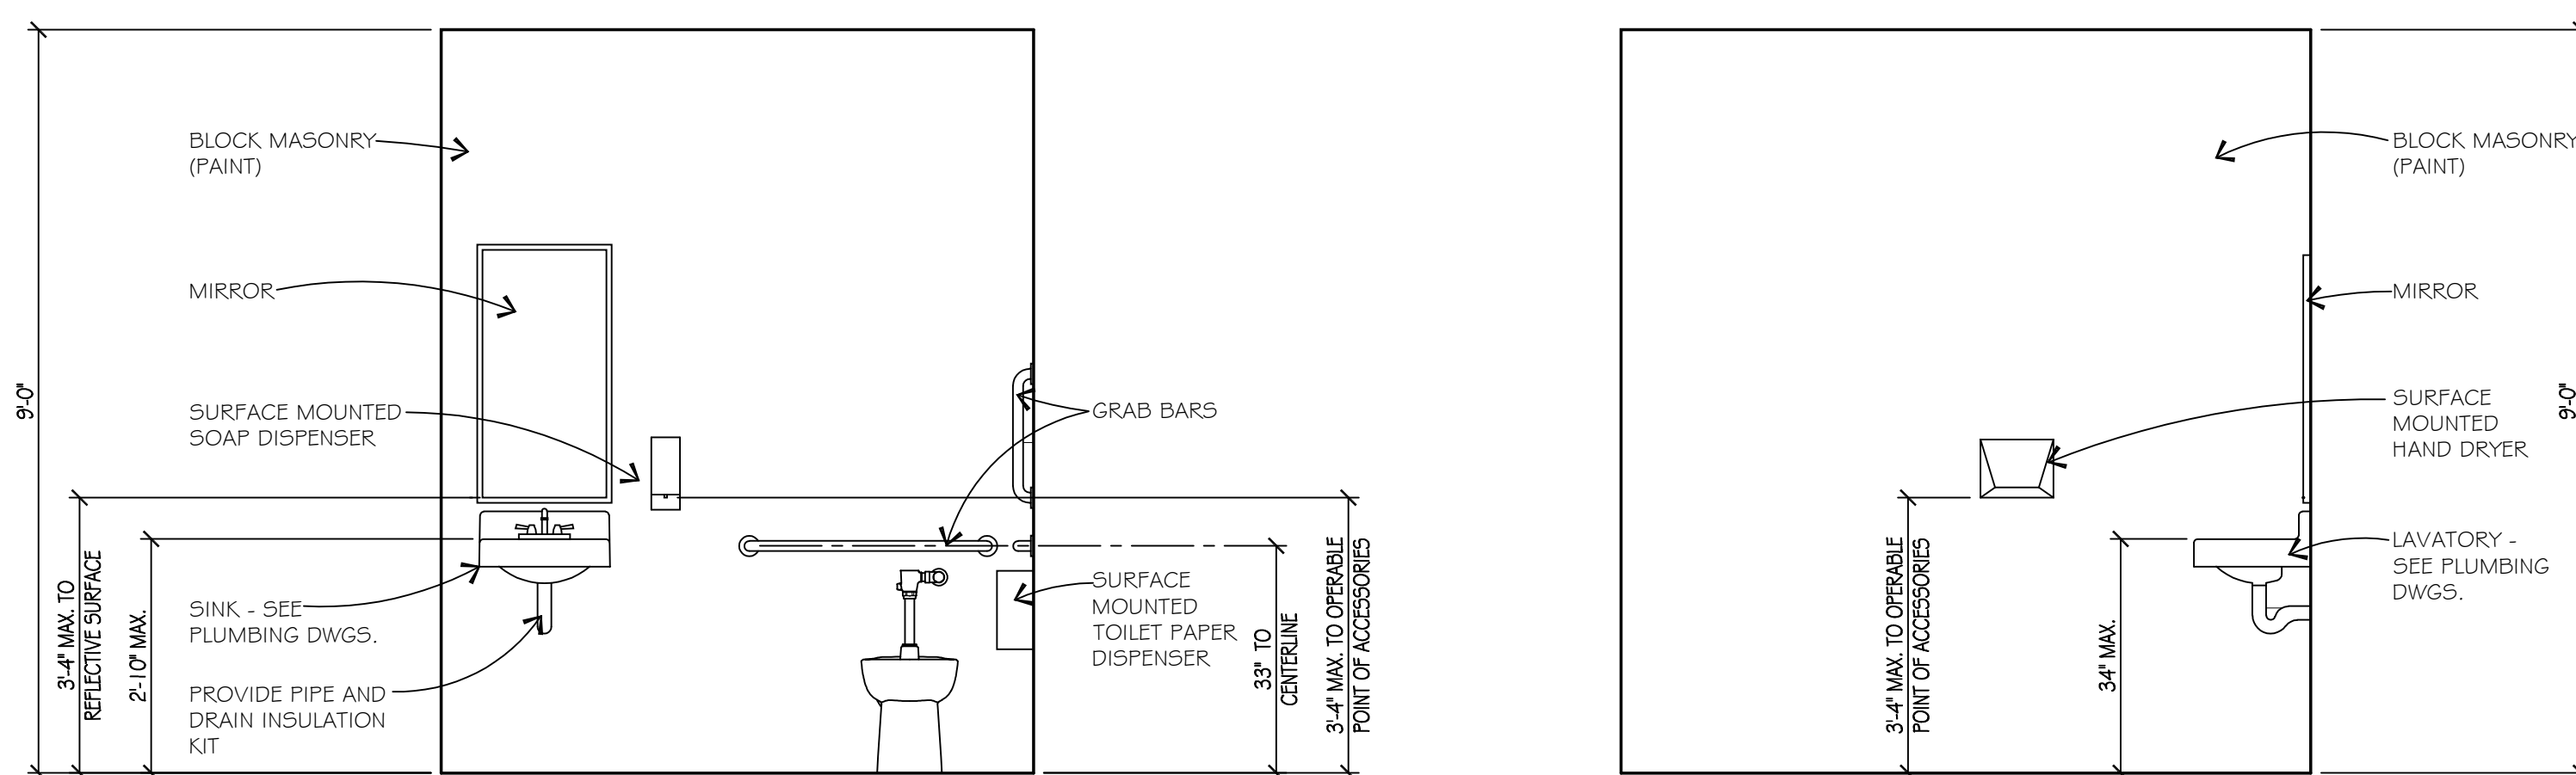


WOMENS TOILET ROOM ELEVATION  
SCALE: 1/2" = 1'-0"

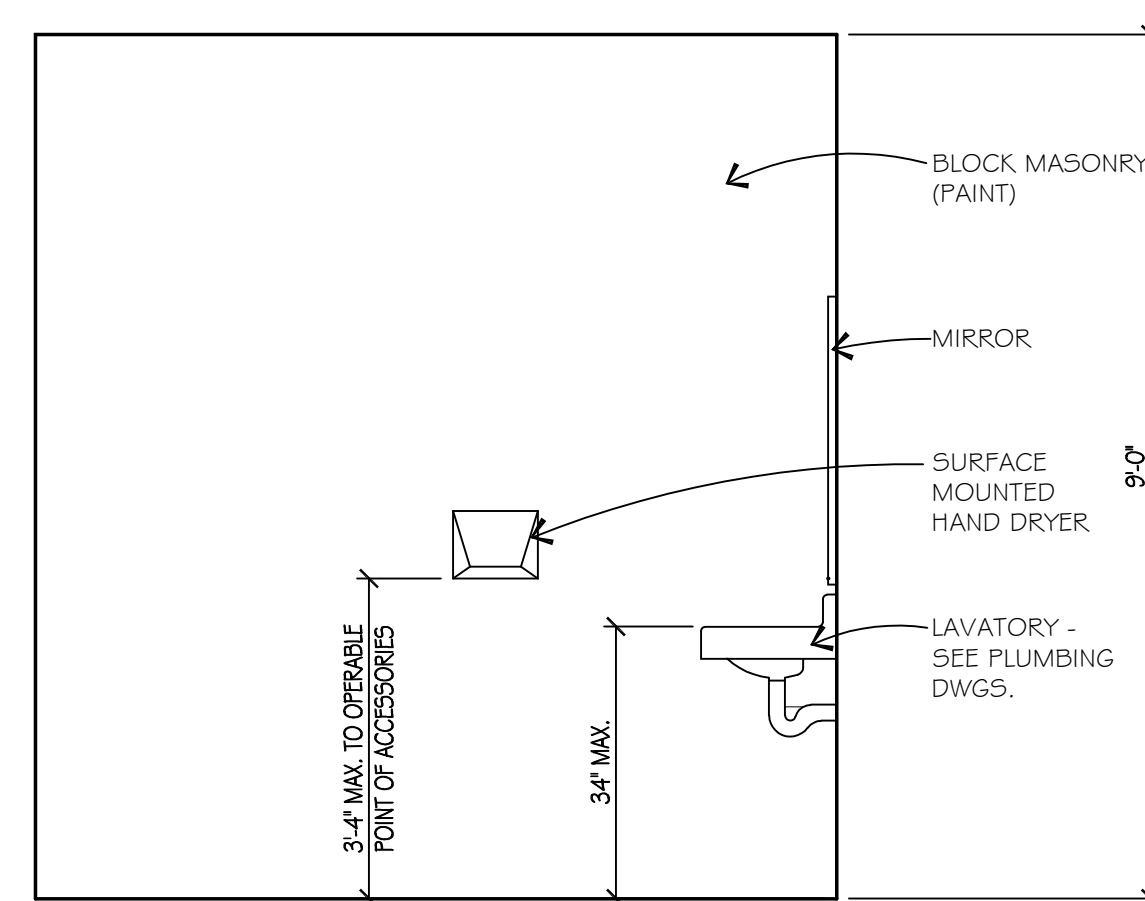

**WOMENS TOILET ROOM ELEVATION**  
SCALE: 1/2" = 1'-0"

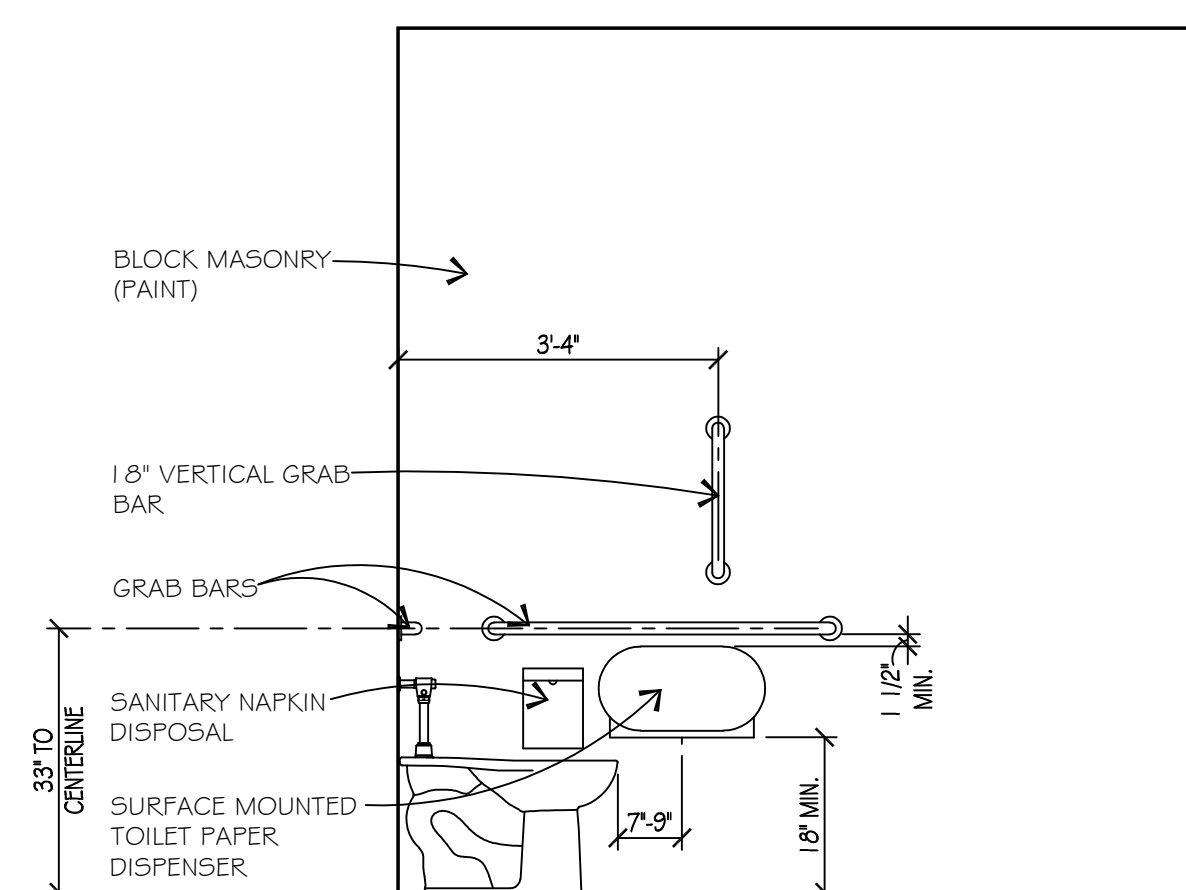

**WOMEN'S TOILET ROOM ELEVATION**  
SCALE: 1/2" = 1'-0"

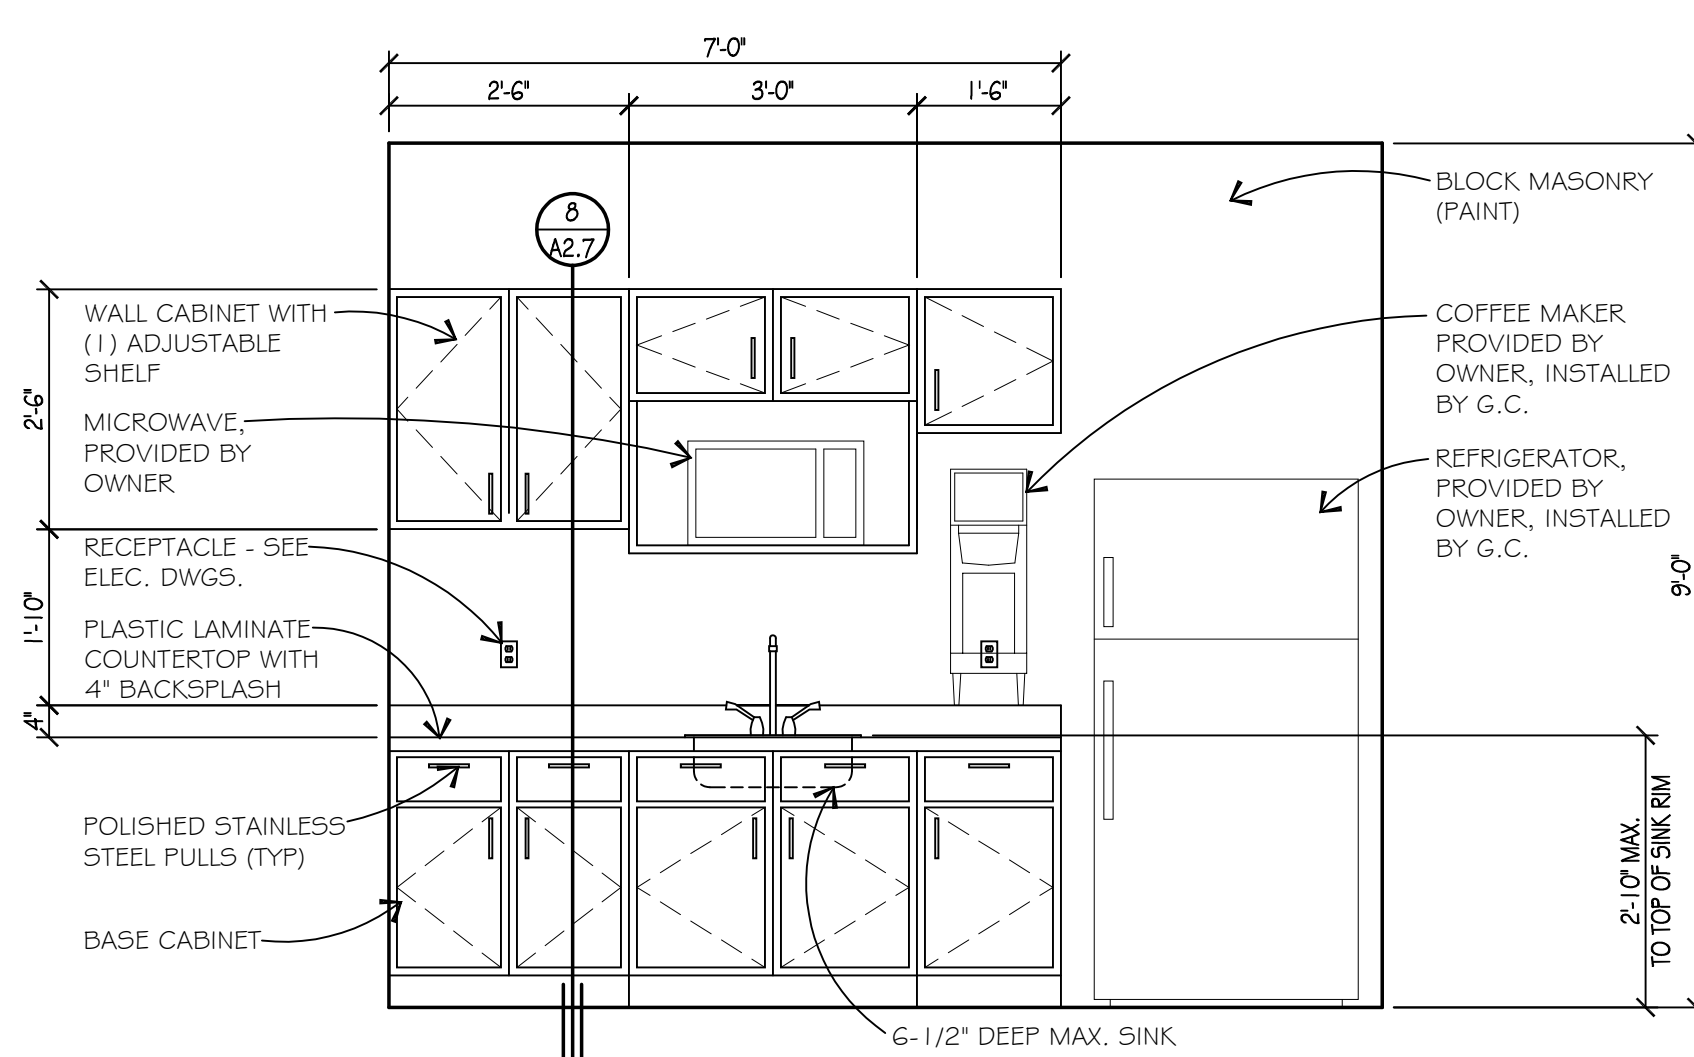


**BREAKROOM ELEVATION**  
SCALE: 1/2" = 1'-0"

TOILET ACCESSORIES LEGEND		
<b>NOTES:</b> 1. ALL TOILET ROOM ACCESSORIES ARE TO BE BY BOBBICK WASHROOM EQUIPMENT INC. (OR APPROVED ALTERNATE MANUFACTURERS ) UNLESS OTHERWISE NOTED. GENERAL CONTRACTOR IS TO PROVIDE AND INSTALL ALL TOILET ACCESSORIES. 2. GENERAL CONTRACTOR IS TO CONFIRM ALL TOILET ROOM ACCESSORY LOCATIONS AND MOUNTING HEIGHTS WITH APPROVED SUBMITTALS. 3. SEE BARRIER FREE REQUIREMENT SHEET AO.2 FOR ADDITIONAL INFORMATION.		
ITEM DESCRIPTION	MANUFACTURER'S ITEM NUMBER	
(A) HAND DRYER	AMERICAN SPECIALTIES INC. AS1-01199-1-93 TURBO HAND DYER 115-120V STAINLESS STEEL	
(B) SURFACE MOUNTED SOAP DISPENSER 40" MAX. A.F.F. TO HIGHEST OPERABLE PART	B-2111	
(C) SURFACE MOUNTED TOILET TISSUE DISPENSER	B-2092 JUMBO	
(D) SURFACE MOUNTED SANITARY NAPKIN DISPENSER, 40" MAX. A.F.F. TO HIGHEST OPERABLE PART.	B-270	
(E) S-5, HORIZONTAL AND VERTICAL GRAB BARS WITH CONCEALED MOUNTING, MOUNTED 33" TO CENTERLINE A.F.F.	B-6806 W/2562 ANCHOR PLATES	
(F) MIRROR WITH STAINLESS STEEL FRAME, 18"x54" BOTTOM EDGE OF REFLECTIVE SURFACE TO BE AT 40" MAX. A.F.F., CLEAR CAULK MIRROR TO WALL.	SENTRY MODEL SMS1836 WITH 5 REFLECTANT ANTI GRAFFITI PLEXI-SHIELDS	
(G) TOILET ROOM PARTITIONS: ACCESSIBLE STALL DOOR TO BE EQUIPPED WITH AUTOMATIC CLOSING DEVICE AND A CLEAR OPENING WIDTH OF 34". PROVIDE ADA COMPLIANT DOOR LATCH AND HANDLE HARDWARE. PROVIDE COAT HOOKS ON ALL DOORS (AT ACCESSIBLE STALL MOUNT AT 48" O.C.)	PROVIDE COMPOSITE MATERIAL TOILET PARTITIONS, OVERHEAD BRACED WITH HEAVY DUTY HARDWARE, COLOR AS SELECTED BY R.L. CARRIERS. PROVIDE DOOR STOPS AT ALL PARTITION DOORS. PROVIDE FLOOR TO CEILING POST FOR URINAL SCREEN, BRACE TOP AND BOTTOM.	
(H) COAT HOOK	B-232x24 AT 48" A.F.F.	
(I) SHELF / HOOK / HOLDER	B-239x34	
(J) ADA SHOWER BENCH	B-5181	
(K) ADA COMPLIANT RESTROOM SIGNAGE	SEE SPECIFICATIONS	

PLUMBING FIXTURE LEGEND	
1	WATER CLOSET - AUTO FLUSH WITH BATTERY - SEE PLUMBING DRAWINGS
1A	ADA ACCESSIBLE WATER CLOSET, AUTO FLUSH WITH BATTERY - SEE PLUMBING DRAWINGS
2	ADA ACCESSIBLE LAVATORY - SEE PLUMBING DRAWINGS, HOT WATER AND DRAIN PIPE UNDER LAVATORY TO BE INSULATED WITH TRUBRO JAVGUARD INSULATION KIT (PIPE WRAP WILL NOT BE ACCEPTED).
3	ACCESSIBLE URINAL - MOUNT URINAL TO MEET ACCESSIBLE REQUIREMENTS - SEE PLUMBING DRAWINGS
4	HI-LO ADA COMPLIANT WATER FOUNTAINS WITH BOTTLE FILLER - SEE PLUMBING DRAWINGS
5	SERVICE SINK - SEE PLUMBING DRAWINGS
6	ELECTRIC WATER HEATER ABOVE - SEE PLUMBING DRAWINGS
7	STAINLESS STEEL TRENCH DRAIN, SLOPE FLOOR TO DRAIN, MAX. 2% SLOPE - SEE PLUMBING DRAWINGS
a	ROLL IN TYPE SHOWER GRAB BARS, SEE SHEET AO.2 FOR ADDITIONAL INFORMATION.

WALL TYPES - MAINTENANCE OFFICE RESTROOM PLAN	
1	8" CMU TO 10'-0" A.F.F., ABOVE 10'-0" TO DECK (OR STRUCT.) PROVIDE 6" METAL STUDS AT 16" O.C. WITH 1 LAYER OF 5/8" GWB EACH SIDE, PROVIDE MOISTURE RESISTANT GWB ON SERVICE BAY SIDE. INTERIOR FINISHES AS NOTED ON SCHEDULE.
1A	SAME AS WALL #1 WITH 6" BATT INSULATION FULL HEIGHT.
2	8" CMU TO 10'-0" A.F.F., REINFORCE PER STRUCTURAL. INTERIOR FINISHES AS NOTED ON SCHEDULE.

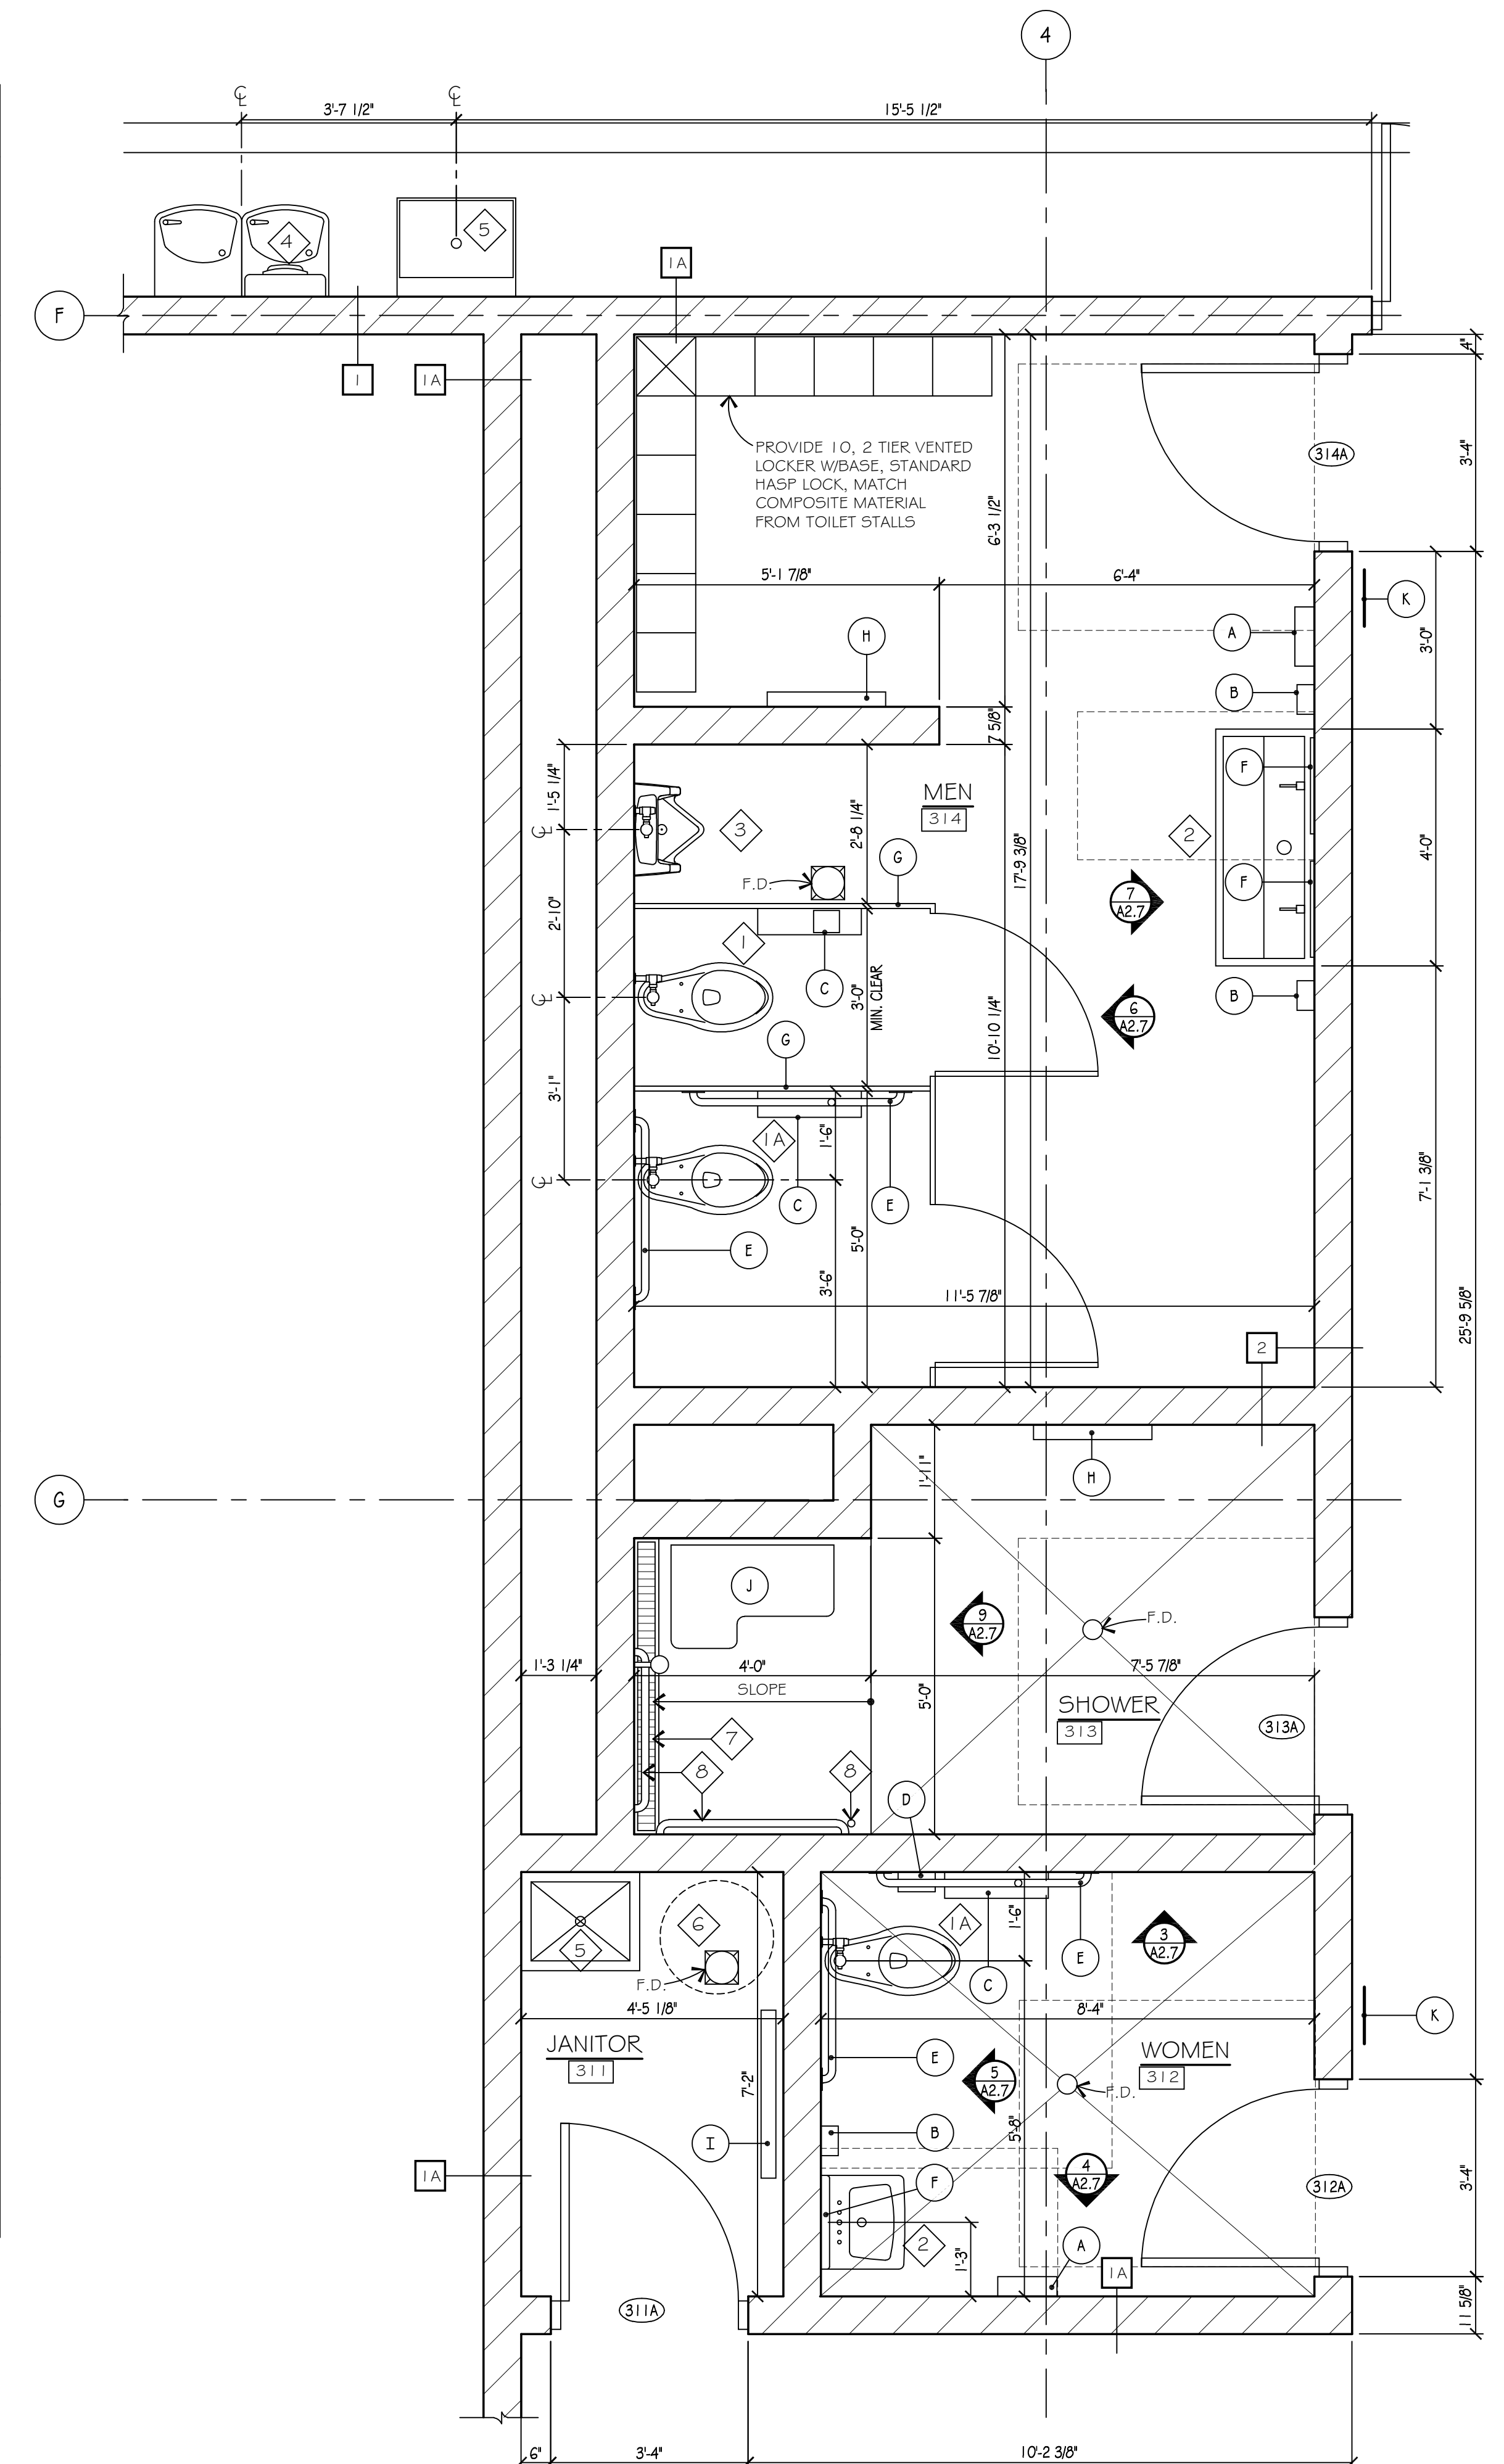

**MAINTENANCE BUILDING 300 ENLARGED RESTROOM PLAN**  
SCALE: 1/2" = 1'-0"

1	INTEGRALLY COLORED SPIT FACE BLOCK MASONRY (PAINT INTERIOR FACE ONLY WITH EPOXY PAINT) WITH HORIZONTAL METAL REINFORCING AT 16" O.C. WITH FOAM-IN-PLACE INSULATION. SEE STRUCTURAL DRAWINGS FOR INFORMATION ON VERTICAL REINFORCING.
2	SMOOTH FACE BLOCK MASONRY (PAINT WITH EPOXY PAINT) WITH HORIZONTAL METAL REINFORCING AT 16" O.C. FROM FLOOR TO UNDERSIDE OF CONCRETE PLANK ROOF DECK. SEE STRUCTURAL DRAWINGS FOR INFORMATION ON VERTICAL REINFORCING.

NOTE:  
GENERAL CONTRACTOR TO PROVIDE 4 CONCRETE RECLAIM TANKS FOR TRUCK WASH SYSTEM.





## VEHICLE WASH EQUIPMENT INSTALLATION RESPONSIBILITIES

THE GENERAL CONTRACTOR, PLUMBING CONTRACTOR, MECHANICAL CONTRACTOR AND ELECTRICAL CONTRACTOR SHALL COORDINATE AND COOPERATE WITH DUBUOIS FLEETWASH MANUFACTURER TO ASSURE A COMPLETE AND PROPERLY OPERATING VEHICLE WASH SYSTEM.

DUBUOIS FLEETWASH SHALL TRAIN OWNER'S EMPLOYEES FOR CORRECT OPERATION, LIFE AND MAINTENANCE OF THE EQUIPMENT.

MULTIPLE PRIME CONTRACTS:  
IF THE WORK IS DIVIDED INTO MULTIPLE PRIME CONTRACTS, EACH PRIME CONTRACTOR WILL BE RESPONSIBLE FOR ALL OF ITS WORKS AS DESCRIBED HEREIN. THE WORK MUST BE COMPLETE TO ASSURE THE PROPER INSTALLATION OF THE WASH EQUIPMENT.

4. THE GENERAL CONTRACTOR WILL BE RESPONSIBLE FOR THE GENERAL CONSTRUCTION, PLUMBING, MECHANICAL, AND ELECTRICAL WORK FOR THE PROPER INSTALLATION OF THE WASH EQUIPMENT. THE WORK SHALL BE DESCRIBED HEREIN. SEE SHEETS E-1-10, E-2-20, F-1-10 & F-2-20 FOR DETAILS.

**NOTE**

DUBUOIS FLEETWASH SHALL SETUP ALL WASH EQUIPMENT, ARROWS, BRUSHES, AND PUMPS (UNLESS OTHERWISE NOTED).

ALL PLUMBING AND CONDUIT LINES ARE TO BE RUN ABOVE SLAB (WASH BAY TO EQUIPMENT AREA).  
EXCEPT AS NOTED

**ALL EQUIPMENT AND DRAWINGS ARE THE PROPERTY OF DUBUOIS FLEETWASH**  
**ANY DUPLICATION OR REUSE WITHOUT THE WRITTEN CONSENT FROM DUBUOIS FLEETWASH**


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TRUCK WASH FACILITY FOR:  
R & L CARRIERS, INC.,  
EDINGBURG, IN.

DRAWN BY: Martin Elliott	DATE: 6/2/2021	JOB NUMBER 20-0141-01
-----------------------------	-------------------	--------------------------

DRAWING NO.

A-1.0



**Wah Yee Associates**  
**Architects & Planners**  
 42400 GRAND RIVER AVENUE, SUITE 200  
 NOVI, MICHIGAN 48375  
 PHONE 248.489.9160

PROJECT  
**R + L CARRIERS**  
EDINBURGH, INDIANA

[illegible]



TRUCK WASH ELECTRICAL POWER WIRE CONNECTION SCHEDULE (DRAWING E2.0)							
Equip. #	Description	Voltage	Breaker Poles	F.L.A.	Circuit	Breaker Size	
1	50hp Rinse Pump	480VAC	3	65	MDP	100	
2	25HP Blaster Rinse Pump	480VAC	3	34	MDP	60	
3	10HP Trailer Brush Hydraulic Pump	480VAC	3	14	MDP	20	
4	3HP Chemical Application Pump	480VAC	3	4.8	MDP	10	
5	Reclaim System Control Panel	120VAC	1	20	MDP	20	
6	TWC (Master Control Panel)	120-208VAC	1	30	MDP	30	
7	Water Softener	120VAC	1	15	MDP	15	
8	Water Heater	120VAC	1	15	MDP	15	
9	3HP Reclaim System Pump	220VAC	1	17	MDP	20	
10	10HP Auto Brush Hydraulic Pump	480VAC	3	14	MDP	20	
11	Reclaim System Fresh Water Solenoid	120VAC	1	17	MDP	20	
12	Reclaim Tank Pump	220VAC	1	17	MDP	20	
POWER WIRING AND CONDUIT BY E.C. TERMINATIONS BY E.C.							

1. ELECTRICAL CONTRACTOR SHALL BE RESPONSIBLE FOR AND FURNISH ALL PERMITS, PERMITS FEES, INSPECTIONS, ALL OTHER FEES AND SALES TAXES RELATING TO ALL ELECTRICAL WORK.
2. ALL WORK SHALL BE IN ACCORDANCE WITH THE LATEST EDITION OF THE NATIONAL ELECTRICAL CODE AND ALL LOCAL CODES GOVERNING ELECTRICAL INSTALLATION.
3. ELECTRICAL SERVICE, MAIN ELECTRICAL DISTRIBUTION PANEL (MPP) AND OTHER ELECTRICAL EQUIPMENT AS REQUIRED.
4. ELECTRICAL SERVICE CONDUIT AND WIRING FROM ELECTRICAL DISTRIBUTION PANELS TO ALL WASH EQUIPMENT INCLUDING BUT NOT LIMITED TO DISPOSAL UNIT, WASH CONTROL PANEL, PUMPS, PRESSURE HANGERS, AND WASHHEADS.
5. ELECTRICAL CONTRACTOR SHALL BE RESPONSIBLE FOR POWER WIRING TO ALL DISPOSAL UNIT WASH'S EQUIPMENT. ELECTRICAL CONTRACTOR SHALL MAKE ALL TERMINATIONS IN CONDUIT PANELS.
6. ELECTRICAL CONTRACTOR CONDUIT AND WIRING FROM DISPOSAL UNIT WASH'S CONTROL PANEL TO WASH EQUIPMENT. DISPOSAL UNIT WASH WILL MAKE FINAL CONNECTIONS IN CONDUIT PANELS.
7. ELECTRICAL CONTRACTOR SHALL FURNISH ALL CONDUIT (EXPANDED IN PLAYS OR IN WALLS), JUNCTION BOXES AND OTHER ITEMS AS REQUIRED FOR COMPLETE ELECTRICAL INSTALLATION.
8. ALL SWITCHES SHALL BE FURNISHED BY DISPOSAL UNIT WASH AND SHALL BE INSTALLED BY THE ELECTRICAL CONTRACTOR.
9. ELECTRICAL CONTRACTOR SHALL BE RESPONSIBLE FOR ENTIRE ELECTRICAL INSTALLATION FOR THE ELECTRICAL SERVICE, POWER WIRING, CONTROL AND ALL ELECTRICAL EQUIPMENT. THE ELECTRICAL SHALL BE LEFT COMPLETE AND OPERATIONAL FOR THE OWNER.
10. DISPOSAL UNIT WASH SHALL BE RESPONSIBLE FOR THE FINAL CHECK OF PHOTO EYES IN WASHWAY AND THE TERMINATION OF THE CONTROL WIRING IN THE WASH CONTROL PANEL AND WASHWAY ONLY.
11. FACILITY LAYOUT PROVIDED BY DISPOSAL UNIT WASH IS TO BE INSTALLED BY THE ELECTRICAL CONTRACTOR. THE FACILITY LAYOUT IS TO BE INSTALLED AT 7'-0" ON-AFT.
12. ALL ELECTRICAL CONTROL WIRING SHALL BE LOCATED WITHIN 2'-0" OF ALL JUNCTION BOXES OR OTHER'S EQUIPMENT. THE ELECTRICAL CONTRACTOR SHALL PROVIDE 3'-0" WALKWAY OF NON-FLAMMABLE MATERIAL (GLASS OR FIBER) TO DISPOSAL UNIT WASH'S EQUIPMENT.

MECHANICAL INSTALLATION REQUIREMENTS & RESPONSIBILITIES					
ITEM	RESP.	DESCRIPTION	SPECIFICATION	PRESSURE	DRAWING REFERENCE
1	DFW	RINSE PUMP OUTLET TO RINSE ARCH IN WASH BAY	2" GALV SCH80	400 P.S.I.	20-0132-04 P-1.0
2	DFW	BLASTER PUMP OUTLET TO BLASTER ARCH IN WASH BAY	1" GALV SCH80	1000 P.S.I	20-0132-04 P-1.0
3	MC	BACK FLUSH DRAIN FROM RECLAIM TO 1st CLARIFIER PIT	1-1/2" PVC SCH80	GRAVITY	20-0132-04 P-1.0
4	DFW	CHEMICAL INJECTION SYSTEM TO BRUSH ARCH BRUSH WETTER	1" PVC SCH80	200 P.S.I.	20-0132-04 P-1.0
5	DFW	CHEMICAL INJECTION SYSTEM TO CHEMICAL ARCH ACTIVATOR	1" PVC SCH80	200 P.S.I.	20-0132-04 P-1.0
6	DFW	CHEMICAL INJECTION SYSTEM TO CHEMICAL ARCH DETERGENT	1" PVC SCH80	200 P.S.I.	20-0132-04 P-1.0
7	MC	RECIRCULATION LINE FROM RECLAIM TO 1st CLARIFIER PIT	1-1/2" PVC SCH80	80 P.S.I.	20-0132-04 P-1.0
8	MC	WATER SOFTENER DRAIN TO SANITARY (NOT TO TRENCH)	1-1/2" PVC SCH40	30 P.S.I.	20-0132-04 & 6 P-1.0 & 2.0
9	DFW	AIR FROM AIR TRIO TO RINSE ARCH & CHEMICAL INJECTOR	1/2" PVC SCH80	40 P.S.I.	20-0132-04 P-1.0
10	MC	1-1/4" L.P. GAS LINE WITH SHUT OFF VALVE	1-1/4"	7.5"-9" W.C.	20-0132-04 P-1.0
11	MC	WATER HEATER VENT STACK TO OUTSIDE W/DRAFT HOOD	8" DIAMETER		20-0132-04 P-1.0
12	DFW	HYDRAULIC PIPING FROM POWER UNIT TO BRUSH ARCH	1/2" DS SCH80	800 P.S.I.	20-0132-04 P-1.0
13	MC	RECLAIM SYSTEM TO LAST CLARIFIER PIT (SUCTION)	1-1/2" PVC SCH80	80 P.S.I.	20-0132-04 & 6 P-1.0 & 2.0
14	DFW	COMPRESSED AIR SUPPLY LINE TO DFW AIR TRIO FROM COMPR.	1/2" COPPER OR PVC	80 P.S.I.	20-0132-04 & 6 P-1.0 & 2.0
15	MC	2" MAIN WATER SUPPLY WITH BACKFLOW PREVENTOR & VALVE	2" COPPER	100 P.S.I.	20-0132-06 P-3.0
16	DFW	2" WATER LINE W/VALVE TO RINSE TANK	2" COPPER	100 P.S.I.	20-0132-06 P-3.0
17	DFW	1" WATER LINE W/VALVE TO RECLAIM SYSTEM POST BACKFLOW	1" COPPER	100 P.S.I.	20-0132-06 P-3.0
18	MC	INSTALL DFW SUPPLIED UNDER CARRIAGE PRE-CONCRETE POUR	1" GALV SCH80	1000 P.S.I	20-0132-04 & 6 P-1.0 & 2.0
19	DFW	RINSE TANK TO 50HP RINSE PUMP INLET	3" PVC SCH80 & HOSE	SUCTION	N/A
20	DFW	RINSE TANK TO 25HP BLASTER PUMP INLET	2" PVC SCH80 & HOSE	SUCTION	N/A
21	DFW	3HP PUMP TO CHEMICAL INJECTION SYSTEM	1-1/2" HOSE	200 P.S.I.	N/A
22	DFW	RECLAIM REACTION TANK PUMP OUTLET TO STORAGE TANK	1-1/2" PVC SCH80	60 P.S.I.	N/A
23	DFW	RECLAIM STORAGE TANK PUMP TO RINSE TANK	1-1/2" PVC SCH80	60 P.S.I.	N/A
24	DFW	RECLAIM SUCTION LINE STUB UP TO REACTION TANK PUMP	1-1/2" PVC SCH80	60 P.S.I.	N/A
25	DFW	RECLAIM RECIRCULATION LINE STUB UP TO RECLAIM SYSTEM	1-1/2" PVC SCH80	60 P.S.I.	N/A
26	DFW	RECLAIM DRAIN TO STUB UP TO 1st CLARIFIER PIT STUB UP	1-1/2" PVC SCH80	60 P.S.I.	N/A
27	DFW	BLASTER PUMP TO BLASTER ARCH	1-1/2" PVC SCH80	60 P.S.I.	N/A
28	DFW	50HP RINSE PUMP TO RINSE ARCH	2" GALV SCH80	400 P.S.I.	20-0132-04 P-1.0
29	DFW	HYDRAULIC PIPING FROM POWER UNIT TO BRUSH ARCH	1/2" DS SCH80	800 P.S.I.	20-0132-04 P-1.0
30	DFW	BLASTER ARCH WHEEL WASH TO UNDER CARRIAGE BAR	1" HOSE	1000 P.S.I	N/A

1. MECHANICAL CONTRACTOR AND/OR OWNER SHALL BE RESPONSIBLE FOR AND FURNISH ALL PERMITS, PERMIT FEES, INSPECTIONS, ALL OTHER FEES AND SALES TAXES RELATING TO ALL MECHANICAL WORK.
2. MECHANICAL CONTRACTOR SHALL FURNISH AND INSTALL ALL EXTERNAL PLUMBING (PER CODE).

GAS PIPING SHOULD INCLUDE A FULL SIZE DIRT POCKET OR TRAP AHEAD OF THE MANUAL SHUT OFF VALVE AND BE INSTALLED IN ACCORDANCE WITH THE NATIONAL BOARD OF FIRE UNDERWRITERS' PAMPHLET 54 AND ANY OTHER LOCAL CODES WHICH MAY APPLY. ALL GAS PIPING SHOULD BE TESTED AFTER INSTALLATION WITH AIR PRESSURE OR INERT GAS 10 TO AT LEAST THREE TIMES THE MAXIMUM OPERATING PRESSURE. MANUAL MAIN GAS SHUT OFF VALVE SHOULD BE LOCATED OUTSIDE BOLLER JACKET WHEN CODES REQUIRED.  
DO NOT USE TEFLON TAPE ON GAS LINE PIPE THREAD.

1. PLUMBING CONTRACTOR SHALL BE RESPONSIBLE FOR AND FURNISH ALL PERMITS, PERMIT FEES, INSPECTIONS, ALL OTHER FEES AND SALES TAXES RELATING TO ALL PLUMBING WORK.
2. THE PLUMBING CONTRACTOR SHALL FURNISH AND INSTALL ALL WATER SUPPLY PIPING FROM BUILDING WATER SUPPLY ENTRANCE TO EQUIPMENT ROOM WITH A PROTECTION FENDER AND EDUCATION VALVE.
3. THE PLUMBING CONTRACTOR SHALL FURNISH AND INSTALL ALL PLUMBING IN WALLS, EXPOSED AND UNDER FLOOR SLABS.
4. PLUMBING CONTRACTOR SHALL INSULATE ALL FRESH WATER PIPING WHEN NECESSARY.

[illegible]

DRAWN BY:  
Martin Elliott

DATE:  
6/3/2021

JOB NUMBER:  
21-0153-07

# A-2.0

Do not scale drawings - Use figured dimensions CAD DWG 5147A28.DWG



R+L Carriers  
Corporate Purchasing  
RFP-202-XXXXXX

RLR Investments, LLC requires a proposal for a new underground storage tank fuel system for our property, [REDACTED] at XXXXXX for R+L Carriers, Inc. The following outlines the scope of work.

Project Start: Project to start upon vendor receiving notification with purchase order from contractor.

Fuel Station Scope of Work

Project Description  
A. UST fuel system with canopy to accommodate 3 lanes of traffic.

Fuel Station  
A. Design and engineering of complete fuel station (turnkey)  
B. Permits  
a. All Zoning, Building, Electrical, Fire Marshal, IDEM and any other required permits are the contractor's responsibility.  
C. Excavation and filling for all work performed  
a. This proposal should be all inclusive, including permits.  
D. Concrete  
a. Canopy foundations  
b. Concrete fuel island  
c. Concrete pavement under canopy  
d. Concrete ballast and pavement under buried tanks and lines  
E. Plumbing Work  
a. Stormceptor to accommodate for area trench drain around fuel island. Fuel station subcontractor will connect to site sanitary if code allows. Alternate option if not allowed.  
b. Area trench drain around fuel island connected to Stormceptor.  
c. Canopy roof storm drainage to be splashed on grade at grade level away from fuel island drain.  
F. Electrical Work  
a. Conduits from maintenance building to Fuel Island will be provided by Fuel Station Contractor. Building contractor will provide approved, authorized, licensed electrician to install all required electrical panels and electrical components along with all required conduits related to required needs for use by Fuel Station contractor.  
b. All electrical and related fuel island components to be located in shop electrical room (Excluding Tank Monitor System).  
c. Fuel Station contractor provides all work for fuel station from electrical panel in nearest building.  
G. Fuel System  
a. Double walled underground tanks (Xerxes or CSI) and double walled fuel piping (Fiberglass or Flex)  
b. Provide isolation valves to permit maintenance of individual dispensers without having to shut down entire fuel island  
c. Shear valves to be installed under every dispenser/pump  
d. SW UDC for all dispensers/pumps, unless code requires DW  
H. Tank Monitor System  
a. Installation of all required conduit lines for electrical and communication use  
b. Veeder Root TLS350Plus System  
c. Veeder Root is to be mounted in shop office.  
I. Fuel Management System  
a. Installation of 4 iGlobal card lock systems (iGlobal Card Locks to be provided by R+L Carriers)

Description of Equipment  
A. Canopy  
a. One (1) Mohawk (or similar) 30' X 66' unbranded canopy with:  
1. Columns to be positioned off of the fuel islands  
2. 17'0" height clearance in all lanes  
3. 36" Green (PMS 342) fascia  
4. Black/Bronze canopy deck  
5. Eight (8) LED Lights placed over islands (R+L to provide GL150W4STRCANPY2SN5000KUDX (IGLO LEDs)  
6. Four (4) Cameras placed over islands (Vendor to provide Conduit Boxes & Wire, R+L to provide Cameras)  
7. Early column freight to job site  
8. Internal drains – adjust to local code  
9. 30 psf live load – adjust to local code  
10. 90 mph wind load – adjust to local code  
B. Island Forms  
a. Four (4) 4'x18'x9" Ultimate island form  
C. Tanks  
a. One (1) Xerxes or CSI 30,000 double wall fiberglass tank (On Road Diesel) with 42" containment sump  
b. One (1) Xerxes or CSI 12,000 dual compartment double wall fiberglass tank (4K Off Rd/8K DEF) with containment sumps (2)  
D. Diesel Tank Top Fittings  
a. Two (2) OPW 1C-3112D 5 gallon grade level spill container with cast iron cover, float gauge and drain valve  
b. Two (2) OPW 7150 overfill prevention drop tube  
c. Two (2) OPW 6337-8076 4" bronze fill adaptor  
d. Two (2) OPW 6341T-7085-EVR 4" Duratuff fill cap  
E. DEF Remote Fill Components  
a. One (1) Morrison 515SD  
b. One (1) OPW Kamvalok 2" Stainless Steel adaptor 1672AN SS20  
F. Stormceptor  
a. STC 2400  
G. Sump Pump Equipment  
a. Two (2) 2HP Red Jacket or FE Petro diesel submersible pump to accommodate for 38 GPM at all dispensers (On Road Diesel Tank)  
b. One (1) Red Jacket or FE Petro DEF submersible pump to accommodate for 10 GPM at all dispensers (DEF Tank)  
c. Red Jacket IQ controllers for pumps  
d. Off Road Tank to be plumbed as Safe Suction  
H. Tank Monitoring Equipment  
a. Console (Unless regulations require interstitial monitoring)  
1. One (1) TLS 350 Plus console with printer 948292-022  
2. Modules  
a) Four input probe module 329356-002 (Redacted)  
b) Eight input interstitial / Liquid sensor module 329358-00 (Redacted)  
c) One (1) CSLD module 330160-002 (1.10 testing)  
d) One (1) PLLD interface module 330843-001  
e) One (1) PLLD controller module 330374-001  
f) One (1) PLLD Risk Management module 330160-060  
g) One (1) Ethernet TCP/IP Communications module 330020-425  
h) One (1) Overfill Alarm model 790091-001  
i) One (1) Alarm Acknowledgement Switch model 790095-001  
3. Leak Detectors/Sensors  
a) PLLD kit without ck valve 848480-00 (Redacted)  
b) Discriminating Sump Sensor model 857080-221 or 2 (Redacted)  
4. Mag Plus Probes  
a) Mag Plus Probes with CSL (Redacted)

I. Dispenser/Pump Equipment (All dispensers are to be setup to fuel with ONLY 1 nozzle at a time, master and satellite cannot dispense at the same time) (ONLY Bennett Certified Technicians may be used - Bennett dispensers/pumps to be provided by R+L Carriers)  
a. One (1) Bennett 321E  
Master High hose Diesel/DEF dispenser (DEF left position) with external filter and adaptor for diesel, satellite internal piping, "Highway Diesel" and "DEF" add panel, mechanical totalizers, 40 GPM flow rate expected for diesel side, dual hose pulse output board, green lower doors, satellite in use light, 12" DEF discharge hose with 3/4" NPT fitting.  
b. Two (2) Bennett 340G  
Dual Master Diesel/DEF Diesel Satellite (DEF right position) Heavy duty powder coated carbon steel cabinet and pedestal stand, spring retractable hose reel w/SS internals, mechanical totalizer, solenoid for dispenser isolation, 12" DEF discharge hose with 3/4" NPT fitting, 1 micron filter with cartridge, gear flow meter w/ 0.5% accuracy, pulse converter, underground hose connection.  
c. One (1) Bennett 320H  
Satellite Diesel/DEF High hose diesel/DEF master/satellite (DEF right position) with external filter and adaptor for diesel master/satellite, satellite internal piping, "Highway Diesel" and "DEF" add panel, 40 GPM flow rate expected for diesel side, dual hose pulse output board, green lower doors, satellite in use light, 12" DEF discharge with 3/4" NPT fitting.  
d. One (1) Bennett 3711SNS-1  
Off Road low hose master. Off Road [REDACTED] pump with external filter and adaptor for Off Road diesel master, "Off Road Diesel" add panel, mechanical totalizer, 20 GPM flow rate expected for Off Road diesel, green lower doors, island oriented, hose retractor.  
J. Diesel Dispensing Accessories  
a. Husky 173312 pressure activated automatic truck nozzle without lock  
b. Husky 4860 1" high flow swivel  
c. Husky 2276 1" Super Safe T break away (re-connectable)  
d. Iipco 123041 1" whip hose  
e. 12' x 1" hose  
K. DEF Dispensing Accessories  
a. OPW 19 Nozzle w/o mis-fill device (19DEF-0500SS)  
b. OPW 19DB-0075 swivel breakaway  
L. Spark-Free Fuel Additive Dispensing Shelter & Accessories  
a. Grounded 3'x6'6" Shelter and Accessories for Fuel Additives will be provided by R+L  
b. Contractor will need Protect Shelter with Ballard's spaced 7' apart  
c. Contractor will need to secure Shelter with 4- "Red Heads"  
d. Contractor will need to ensure 1 of the 4- "Red Heads" Goes 18 inches into the ground and 2 1/2 inches out of the ground to serve as a Grounding Lug

Note: Hardware and quantity noted in proposal subject to change due to size of Fuel Island, availability of equipment. Please attempt to use as much equipment (brand, model and part numbers) as possible with submitting bid.



Mockup and Install info on last pages

Any further information requested please submit in writing and email to: Craig.Kohring@rlcarriers.com


Thank you,

Craig Kohring

Project Manager, Construction | Facility Maintenance  
600 Gilliam Rd, Wilmington, OH 45177  
937-605-9109 Cell  
800-543-5589 EXT 1343  
937-655-2110 FAX  
Craig.Kohring@rlcarriers.com

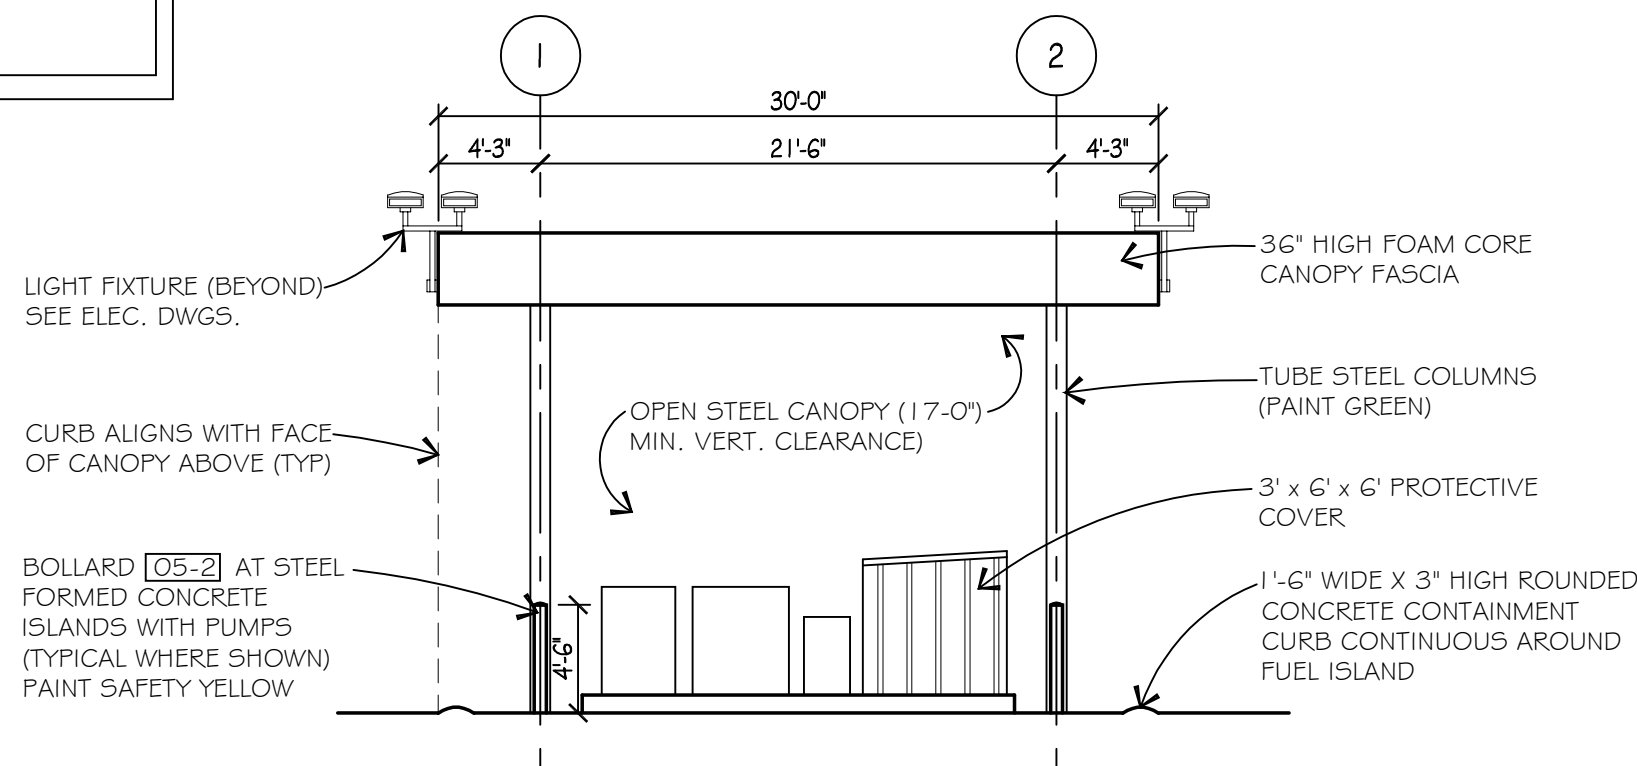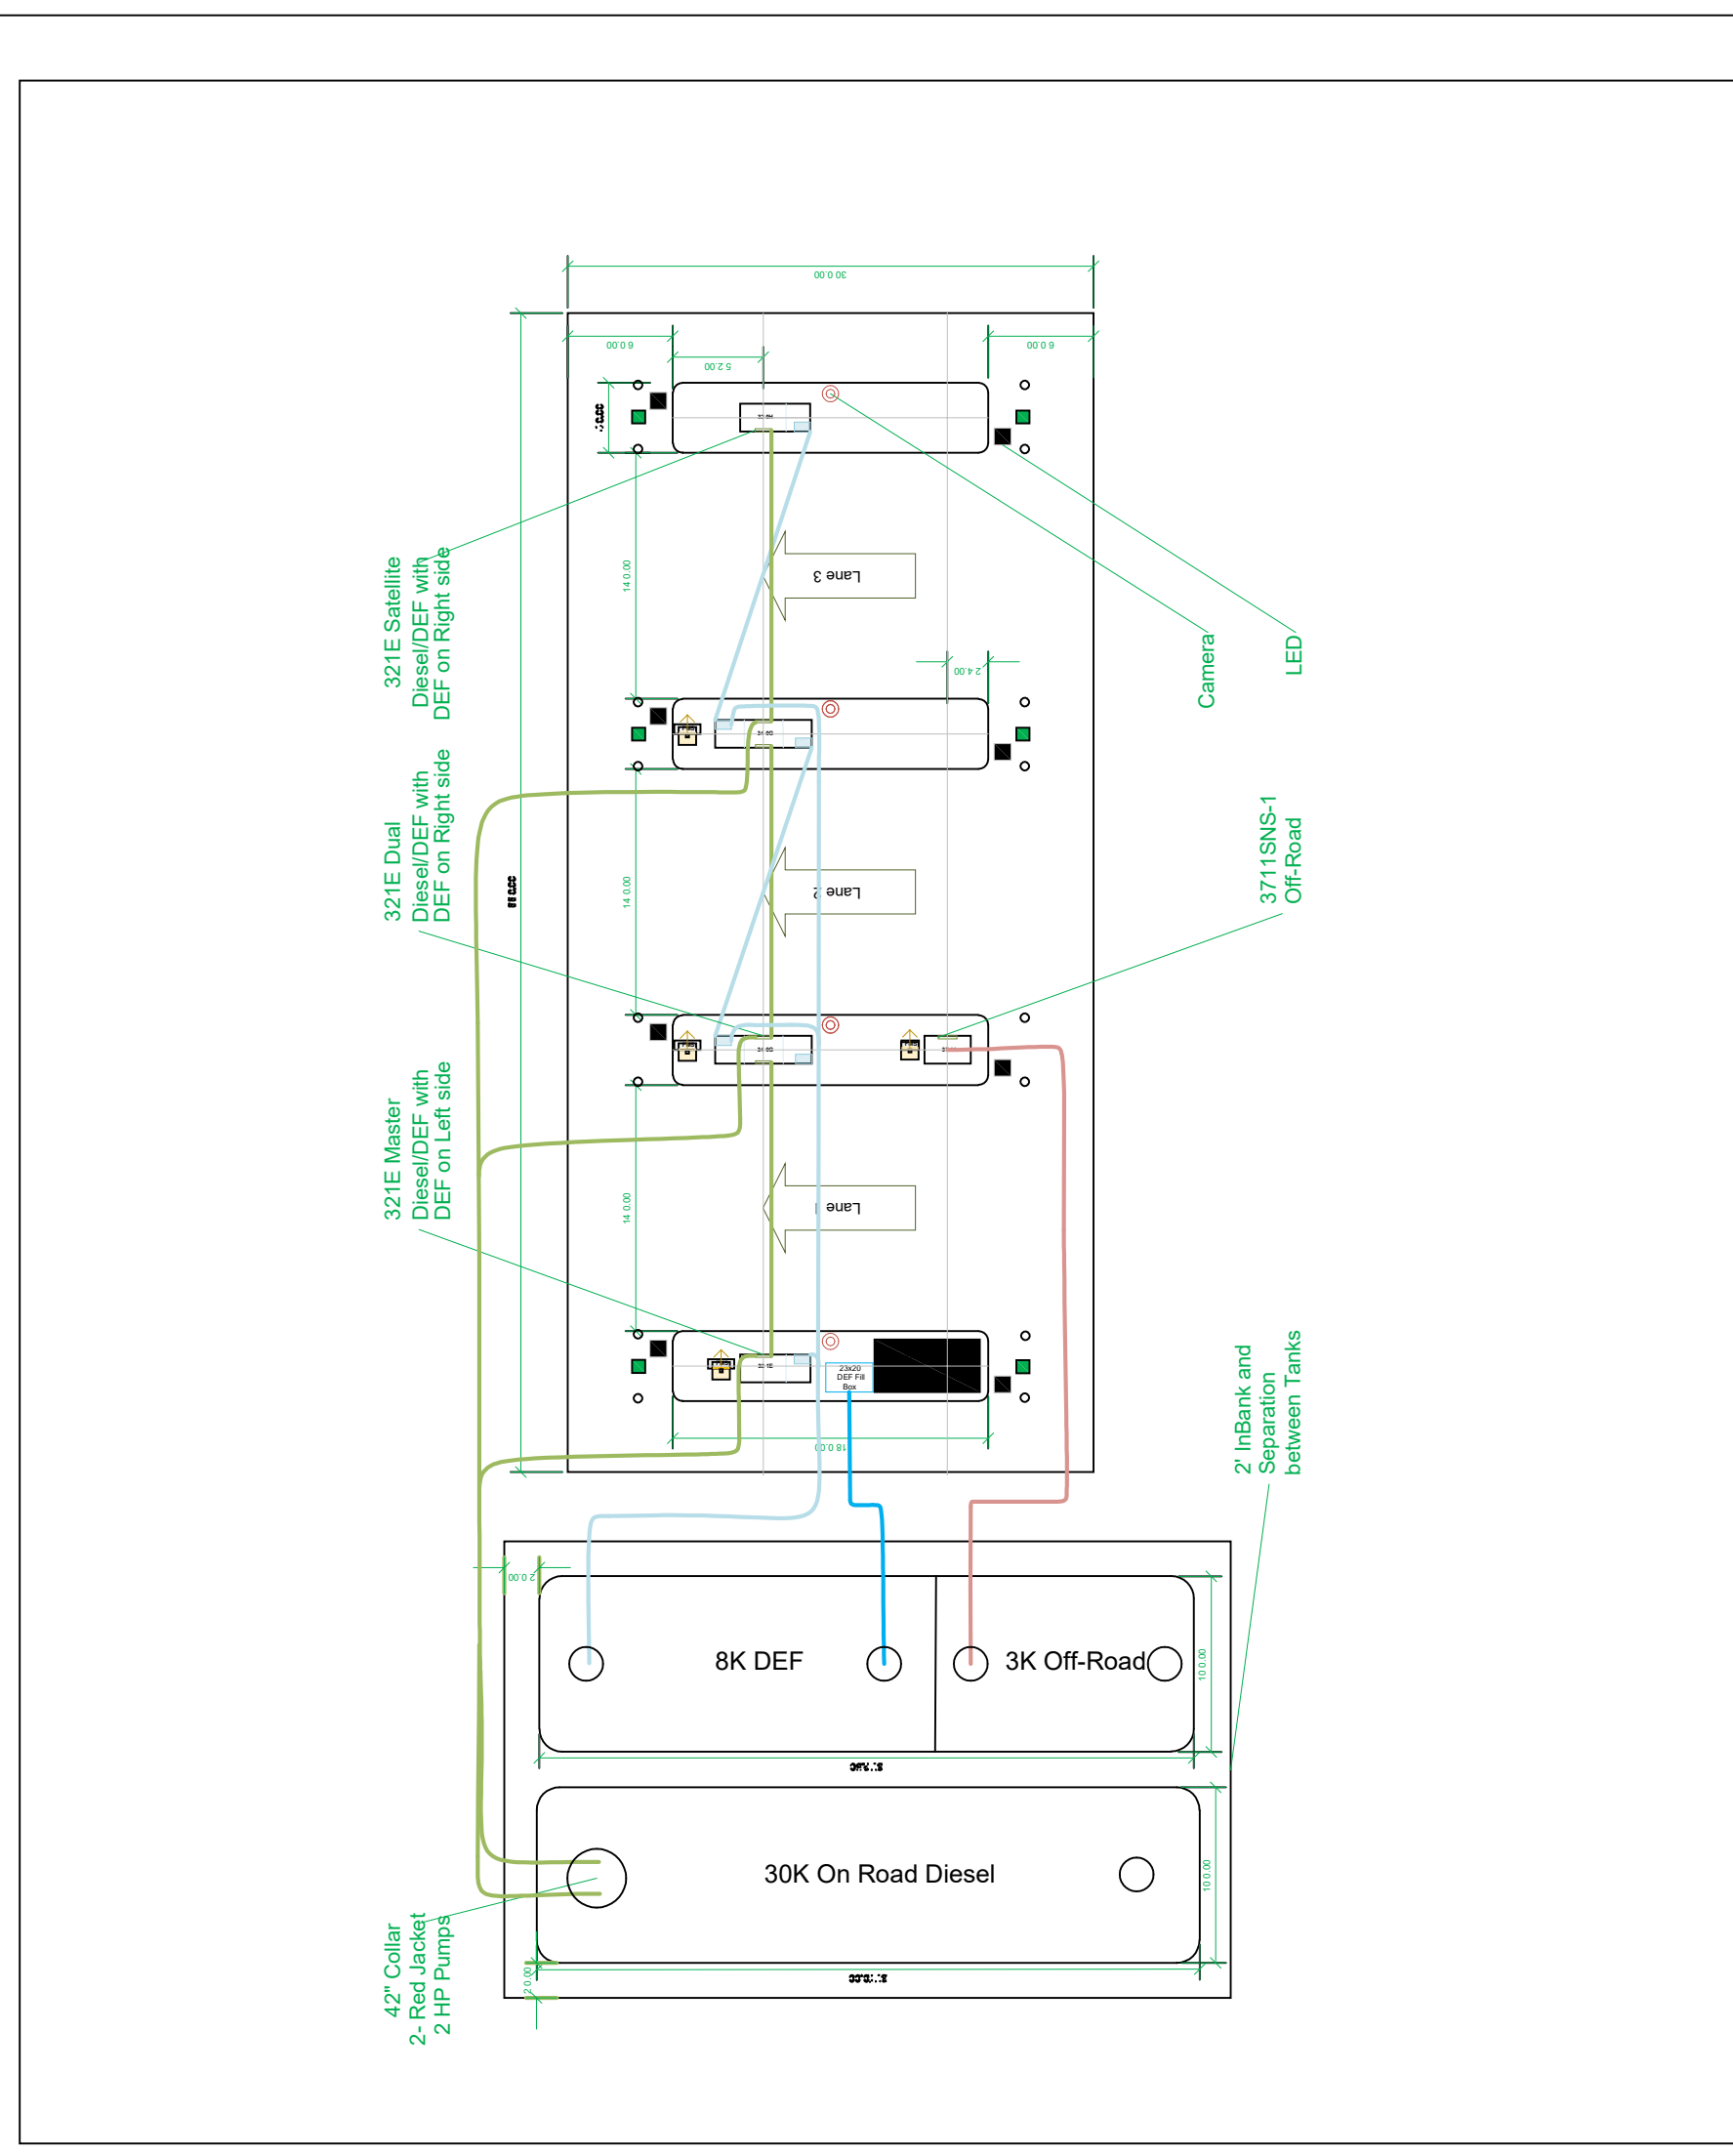


FUEL STATION ELEVATION  
SCALE: 1/8"= 1'-0"

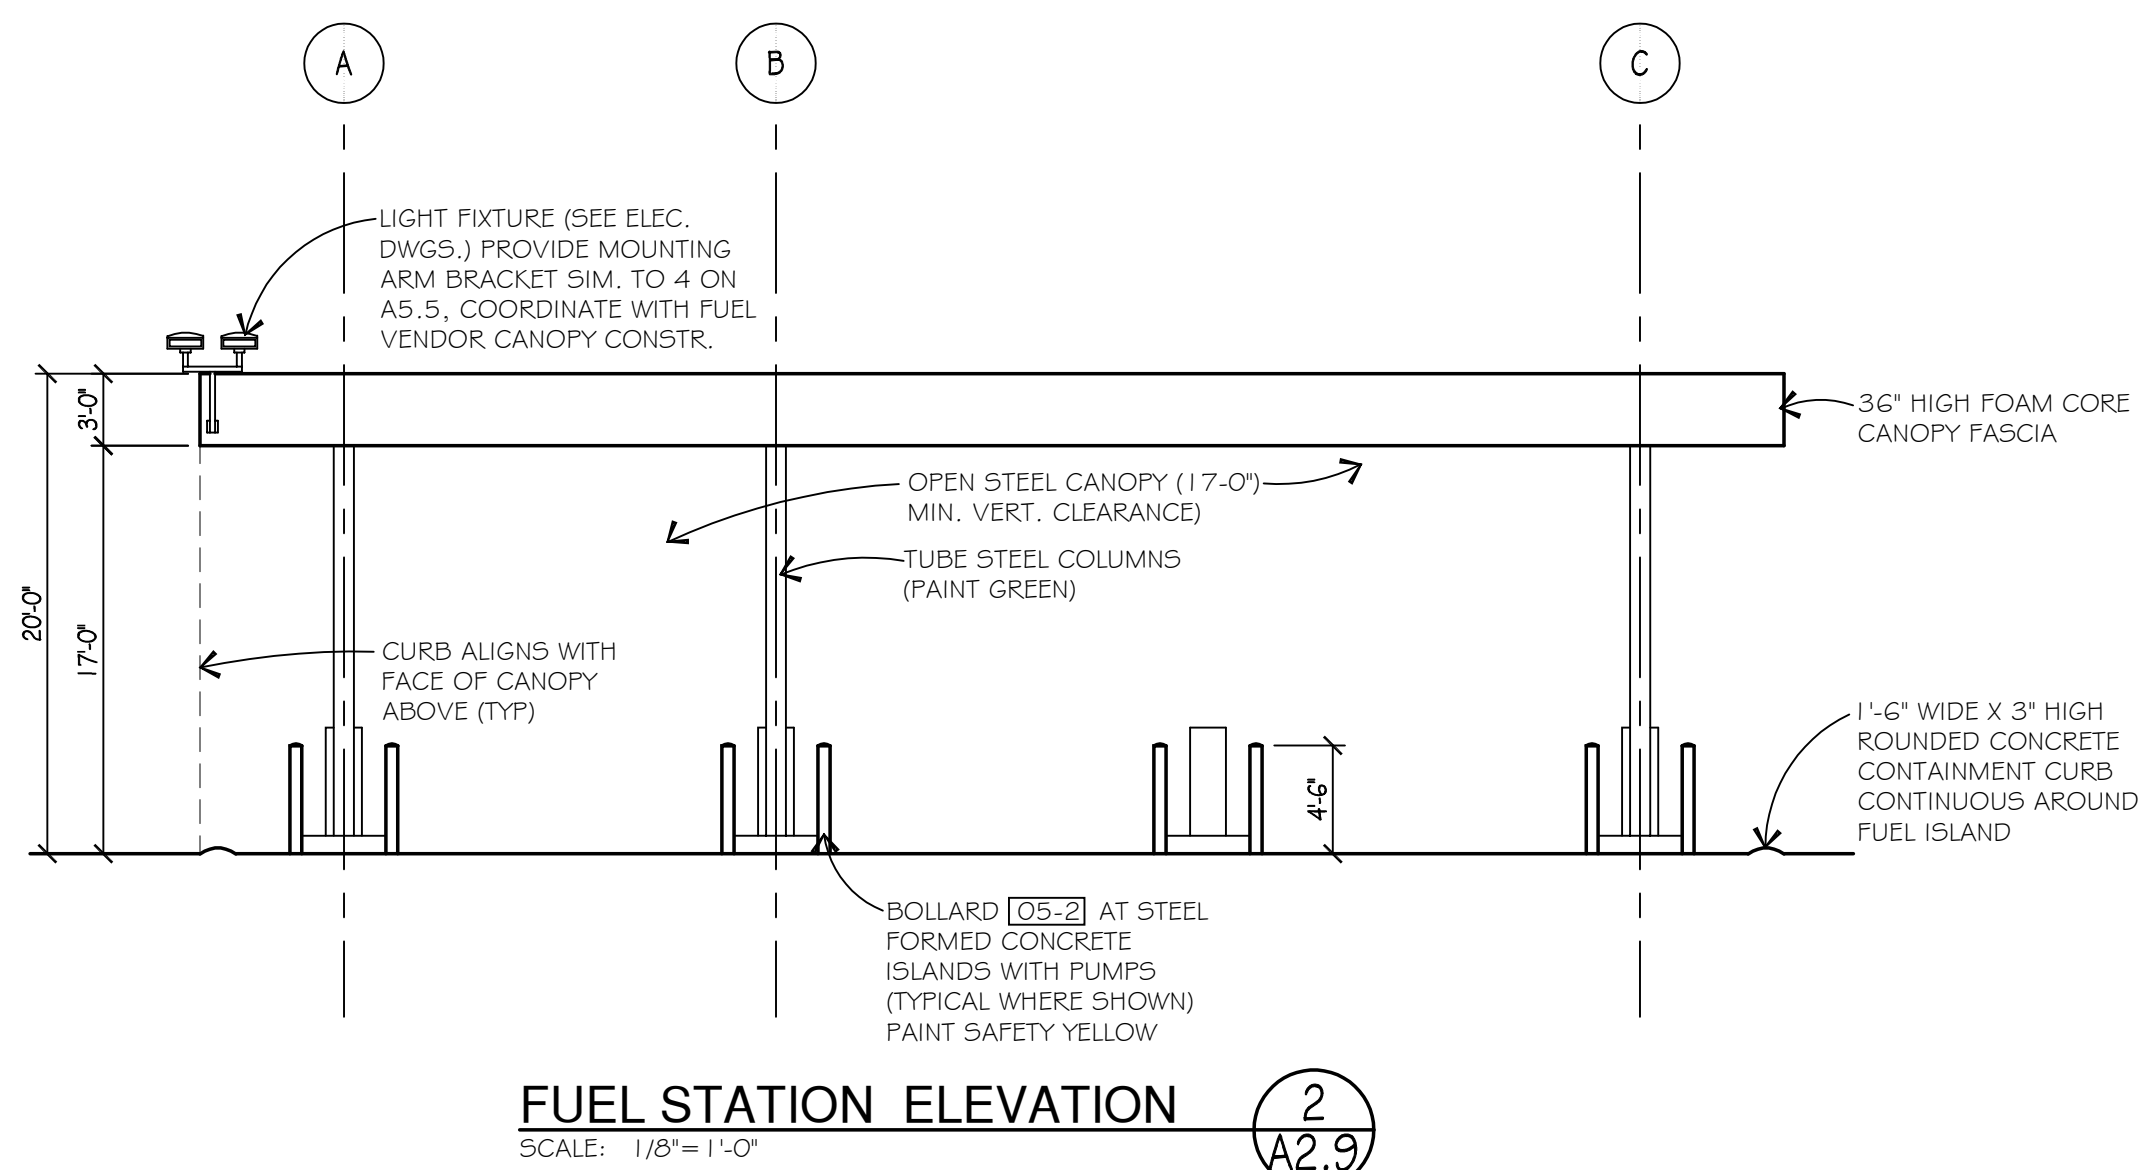

FUEL STATION ELEVATION  
SCALE: 1/8"= 1'-0"

NOTE:  
FUEL MANAGEMENT SYSTEM - UNIT ONLY SUPPLIED BY OWNER, INSTALLED BY GENERAL CONTRACTOR. ALL RELATED ITEMS SUPPLIED AND INSTALLED BY GENERAL CONTRACTOR INCLUDING 1 1/2" CONDUIT FROM SHOP TO FUEL ISLAND FOR COMMUNICATION. SEE SHEET A2.9 FOR FUEL STATION SCOPE OF WORK TO BE UNDER GENERAL CONTRACTORS SCOPE OF WORK.

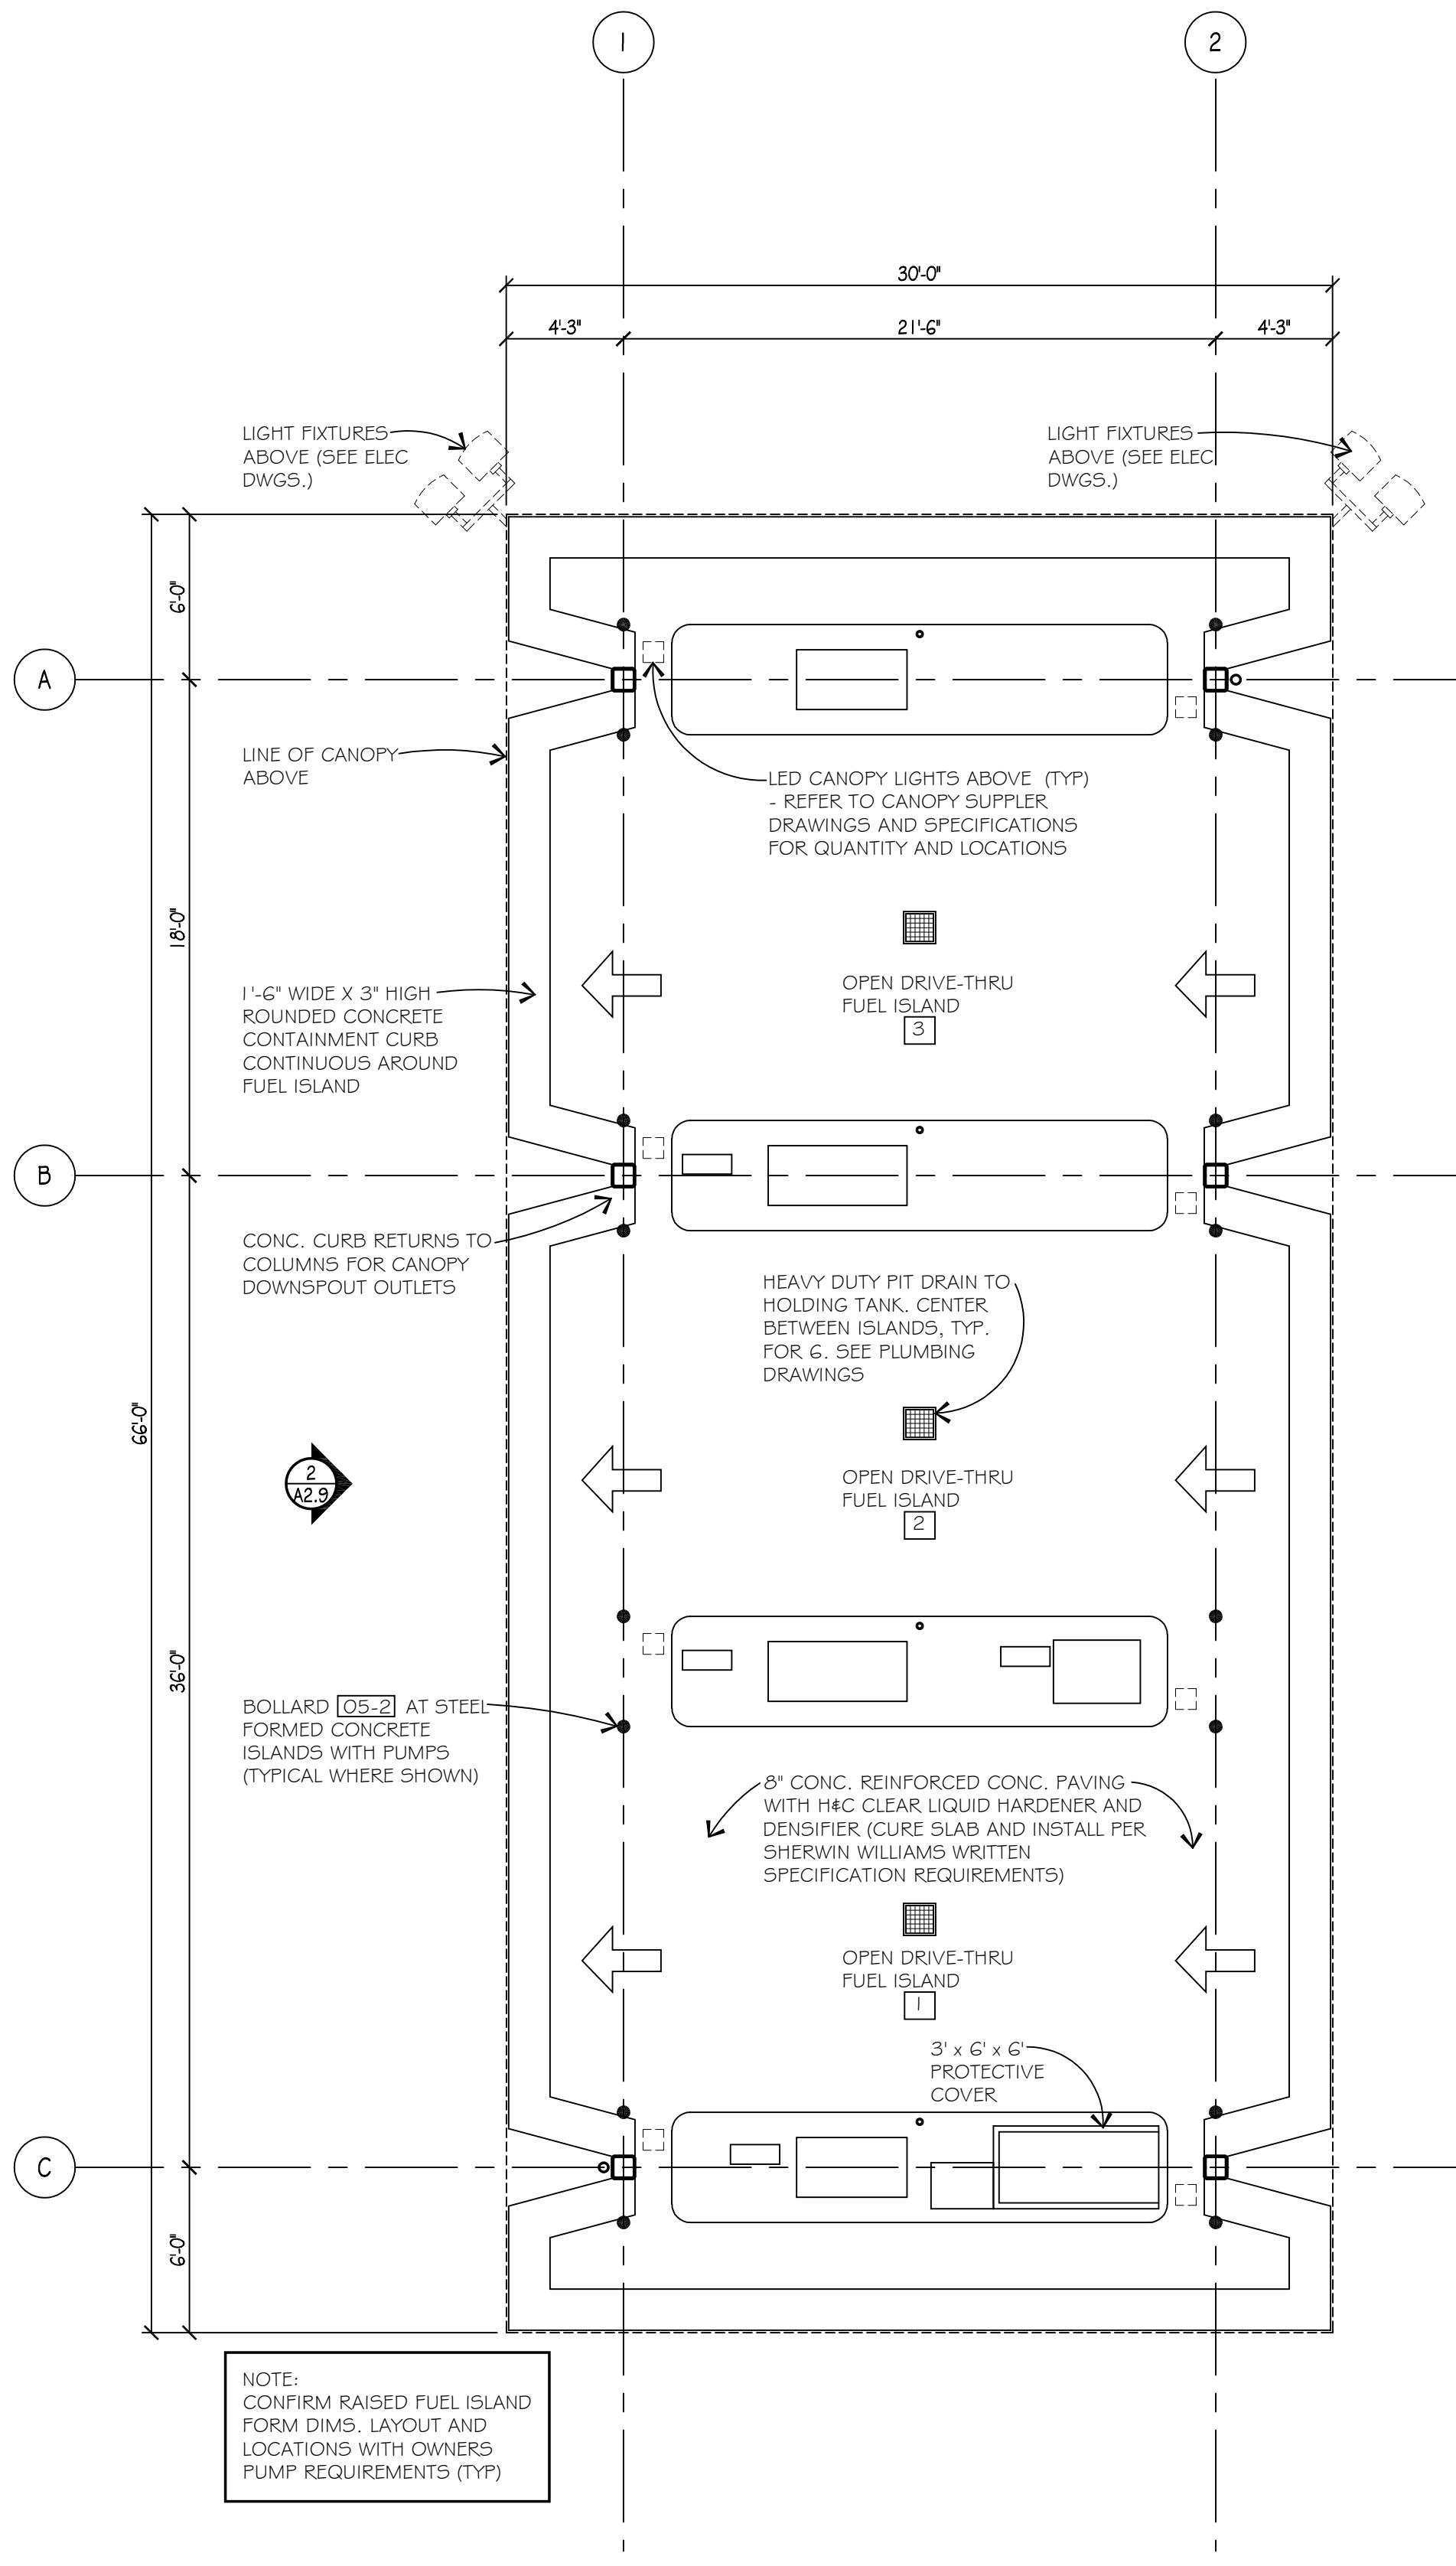

FUEL STATION PLAN  
SCALE: 3/16"= 1'-0"

Woh Yee Associates  
Architects & Planners  
1400 GRANDVIEW AVENUE, SUITE 200  
NORFOLK, VIRGINIA 23503  
PHONE 246.489.9160

PROJECT  
R + L CARRIERS  
EDMUNDSVILLE, INDIANA

Date Issued  
Bids & Permit XXXX.XX, 2017

Job Number  
5147

SHEET TITLE  
FUEL STATION  
PLAN, AND  
ELEVATIONS




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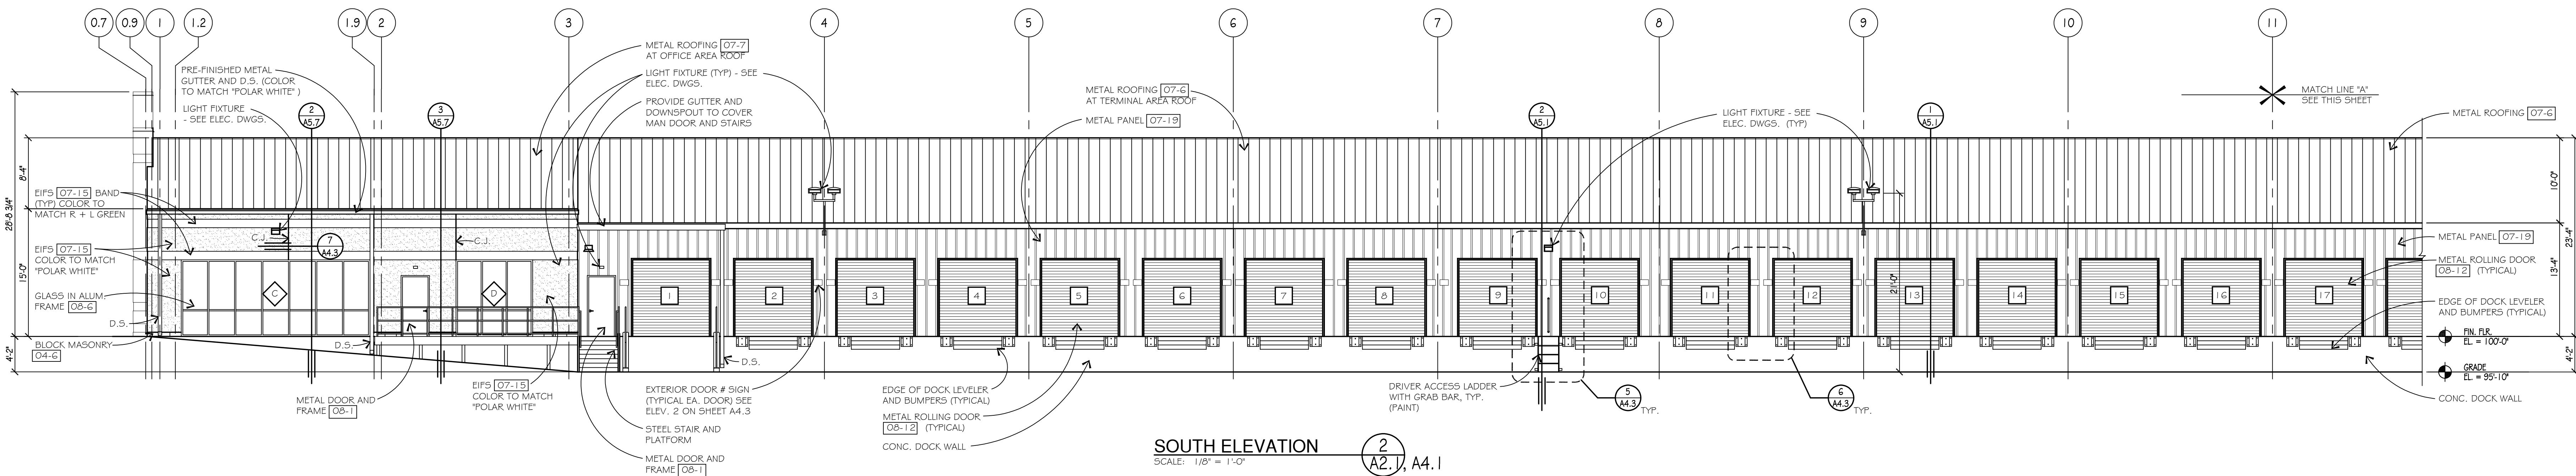
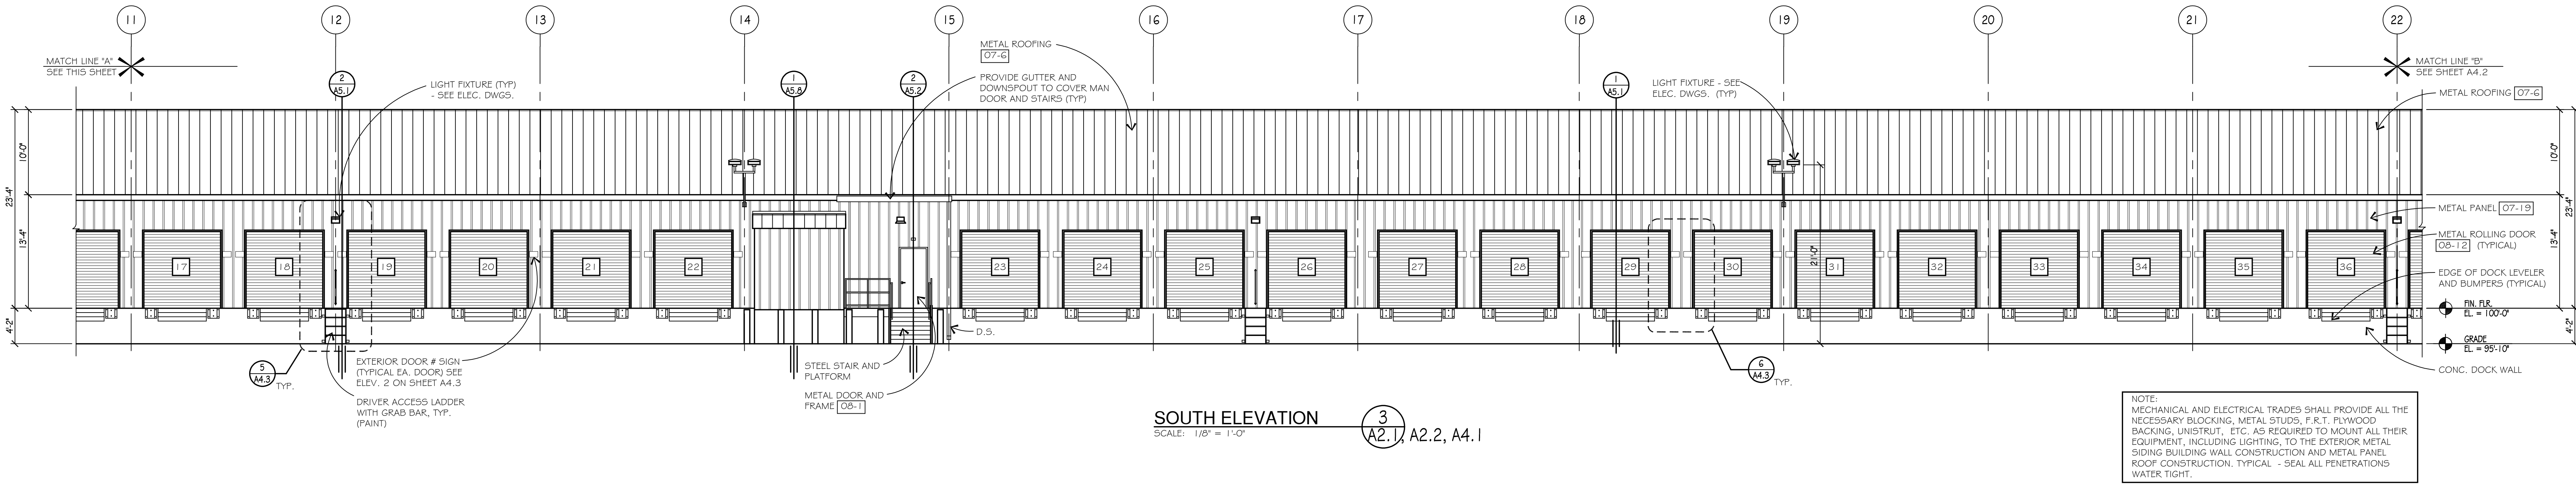
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### TERMINAL BUILDINGS - EXTERIOR FINISH SCHEDULE

#### PREFINISHED METAL PANELS:

ROOF: COLOR "POLAR WHITE"  
NOTE: STANDING SEAM ROOF PANELS, 24 GA.

WALLS: COLOR "POLAR WHITE"  
NOTE: METAL SIDING WALL PANELS SHALL BE 26 GA. WITH EXPOSED FASTENERS.

DOORS/WINDOWS:  
HOLLOW METAL DOORS AND FRAMES: PAINT TO MATCH METAL SIDING "POLAR WHITE"  
OVERHEAD ROLL-UP/COLLING DOORS: STANDARD WHITE

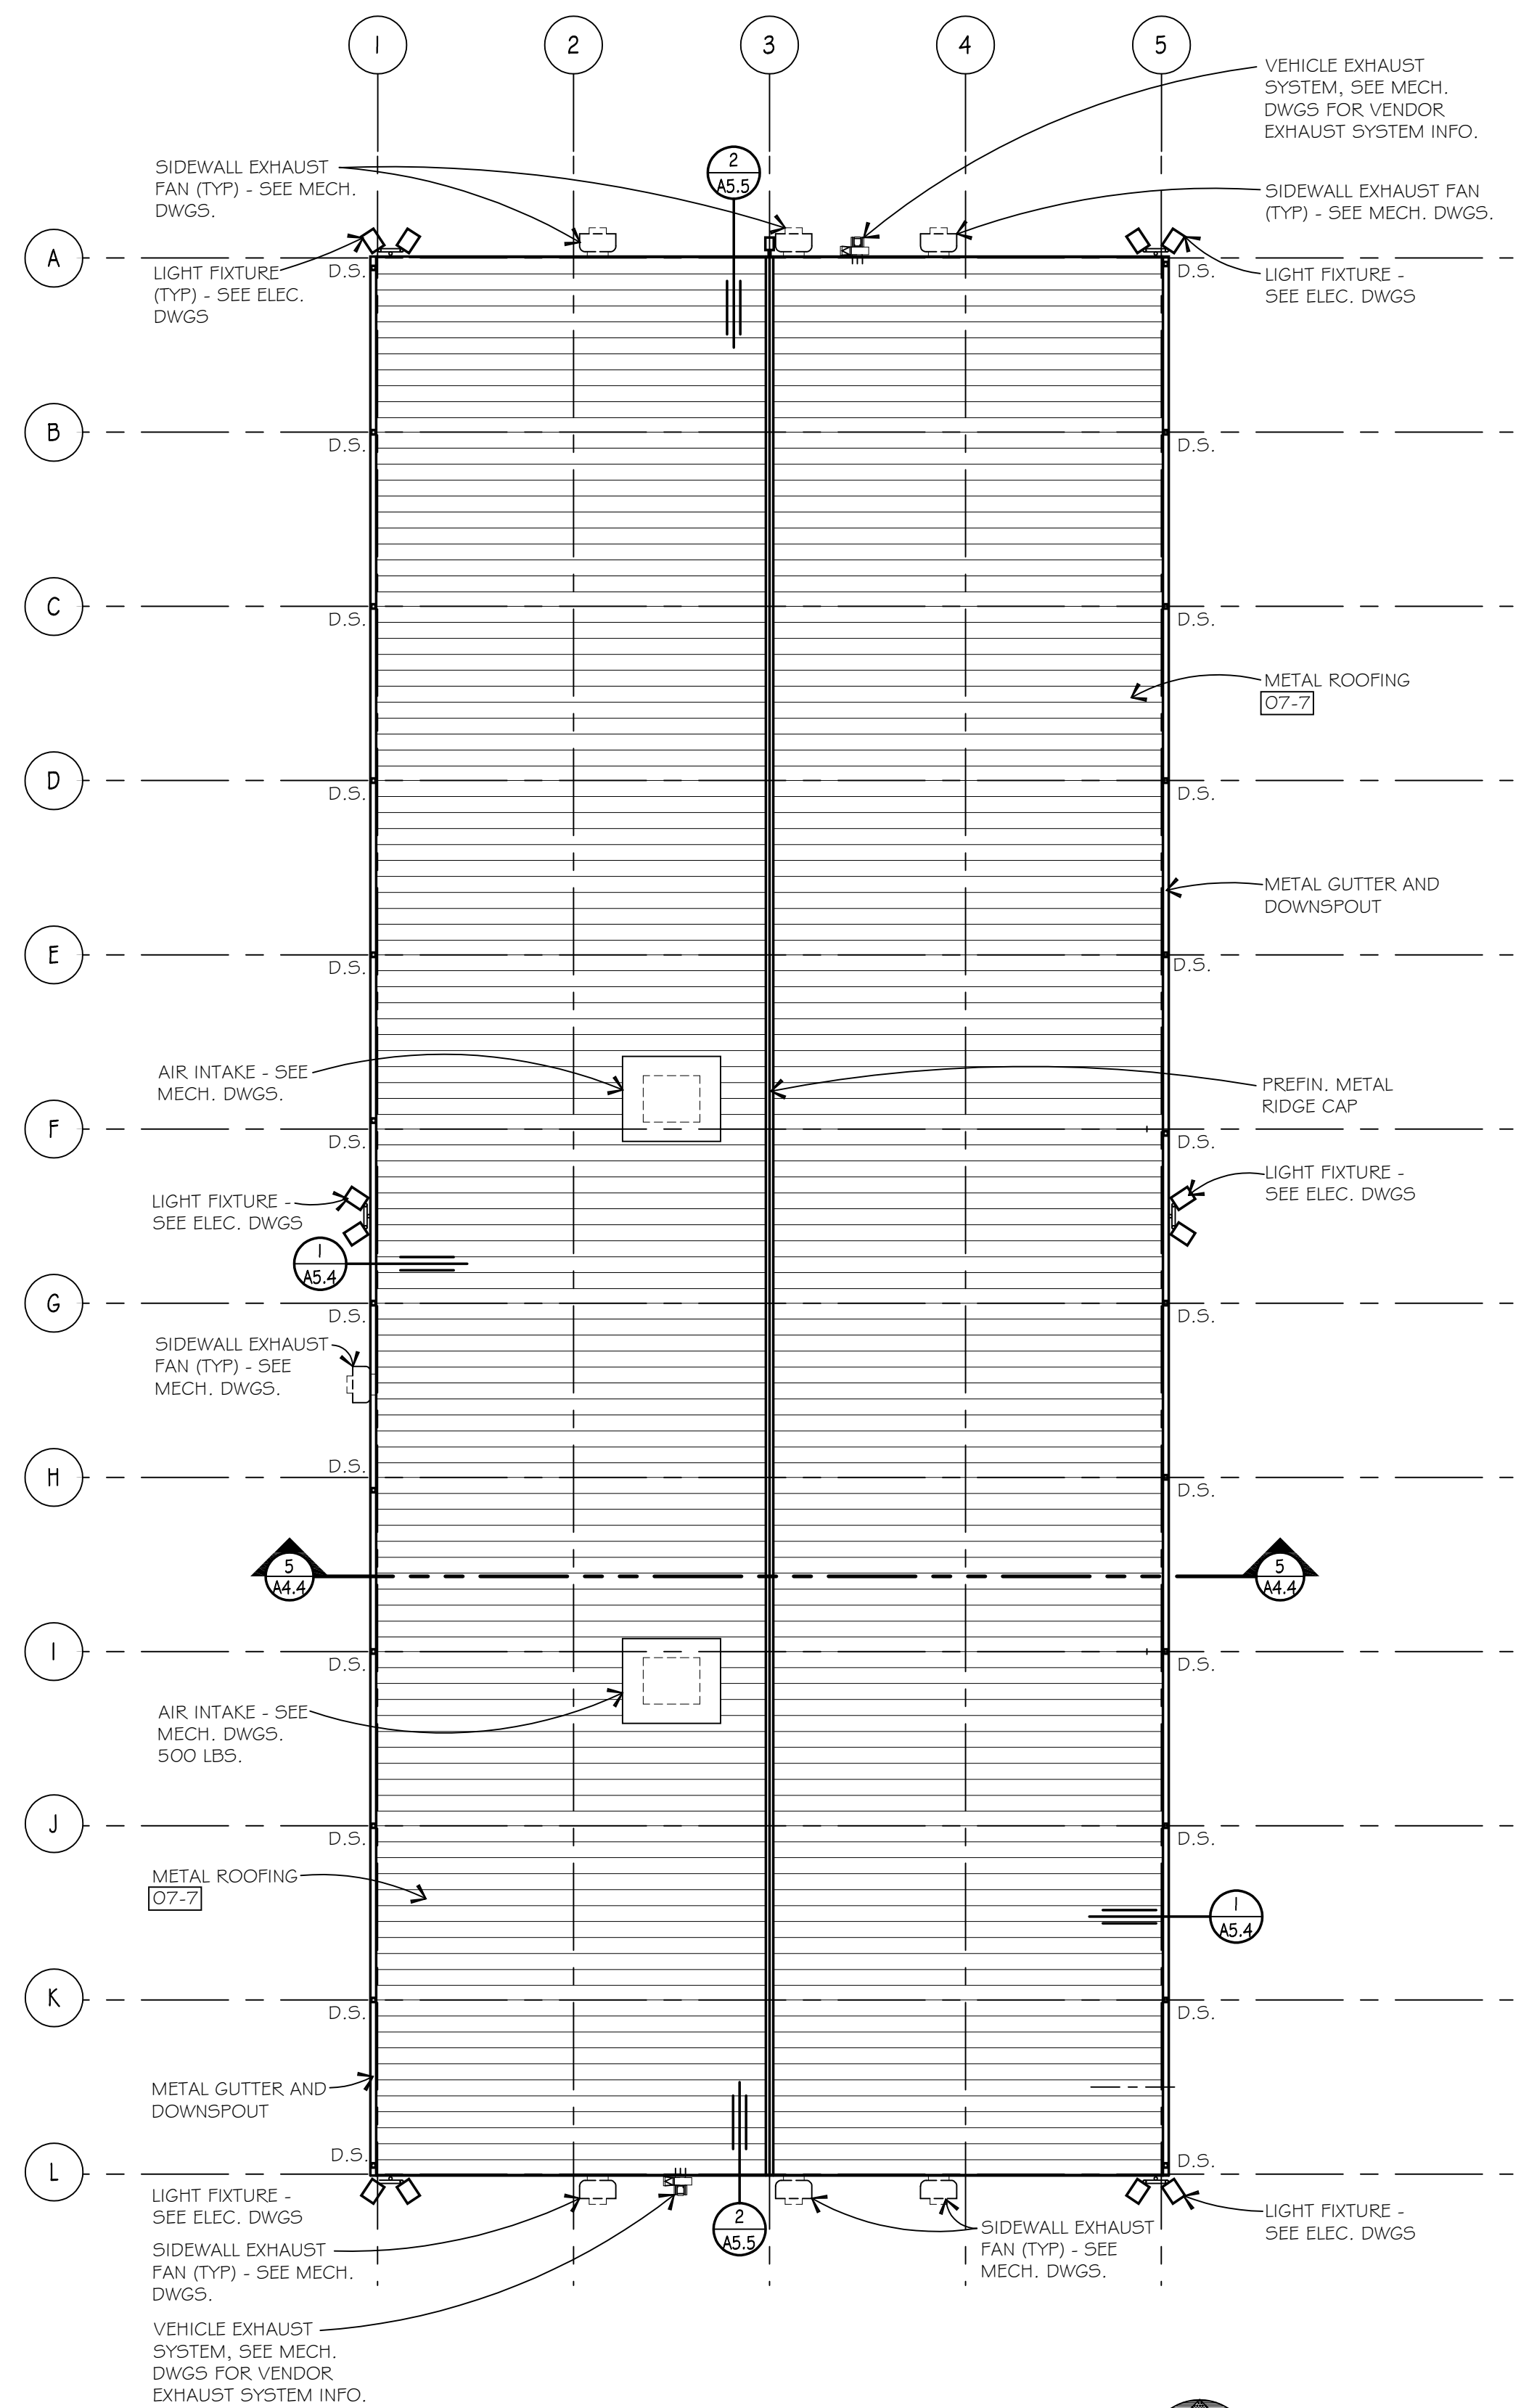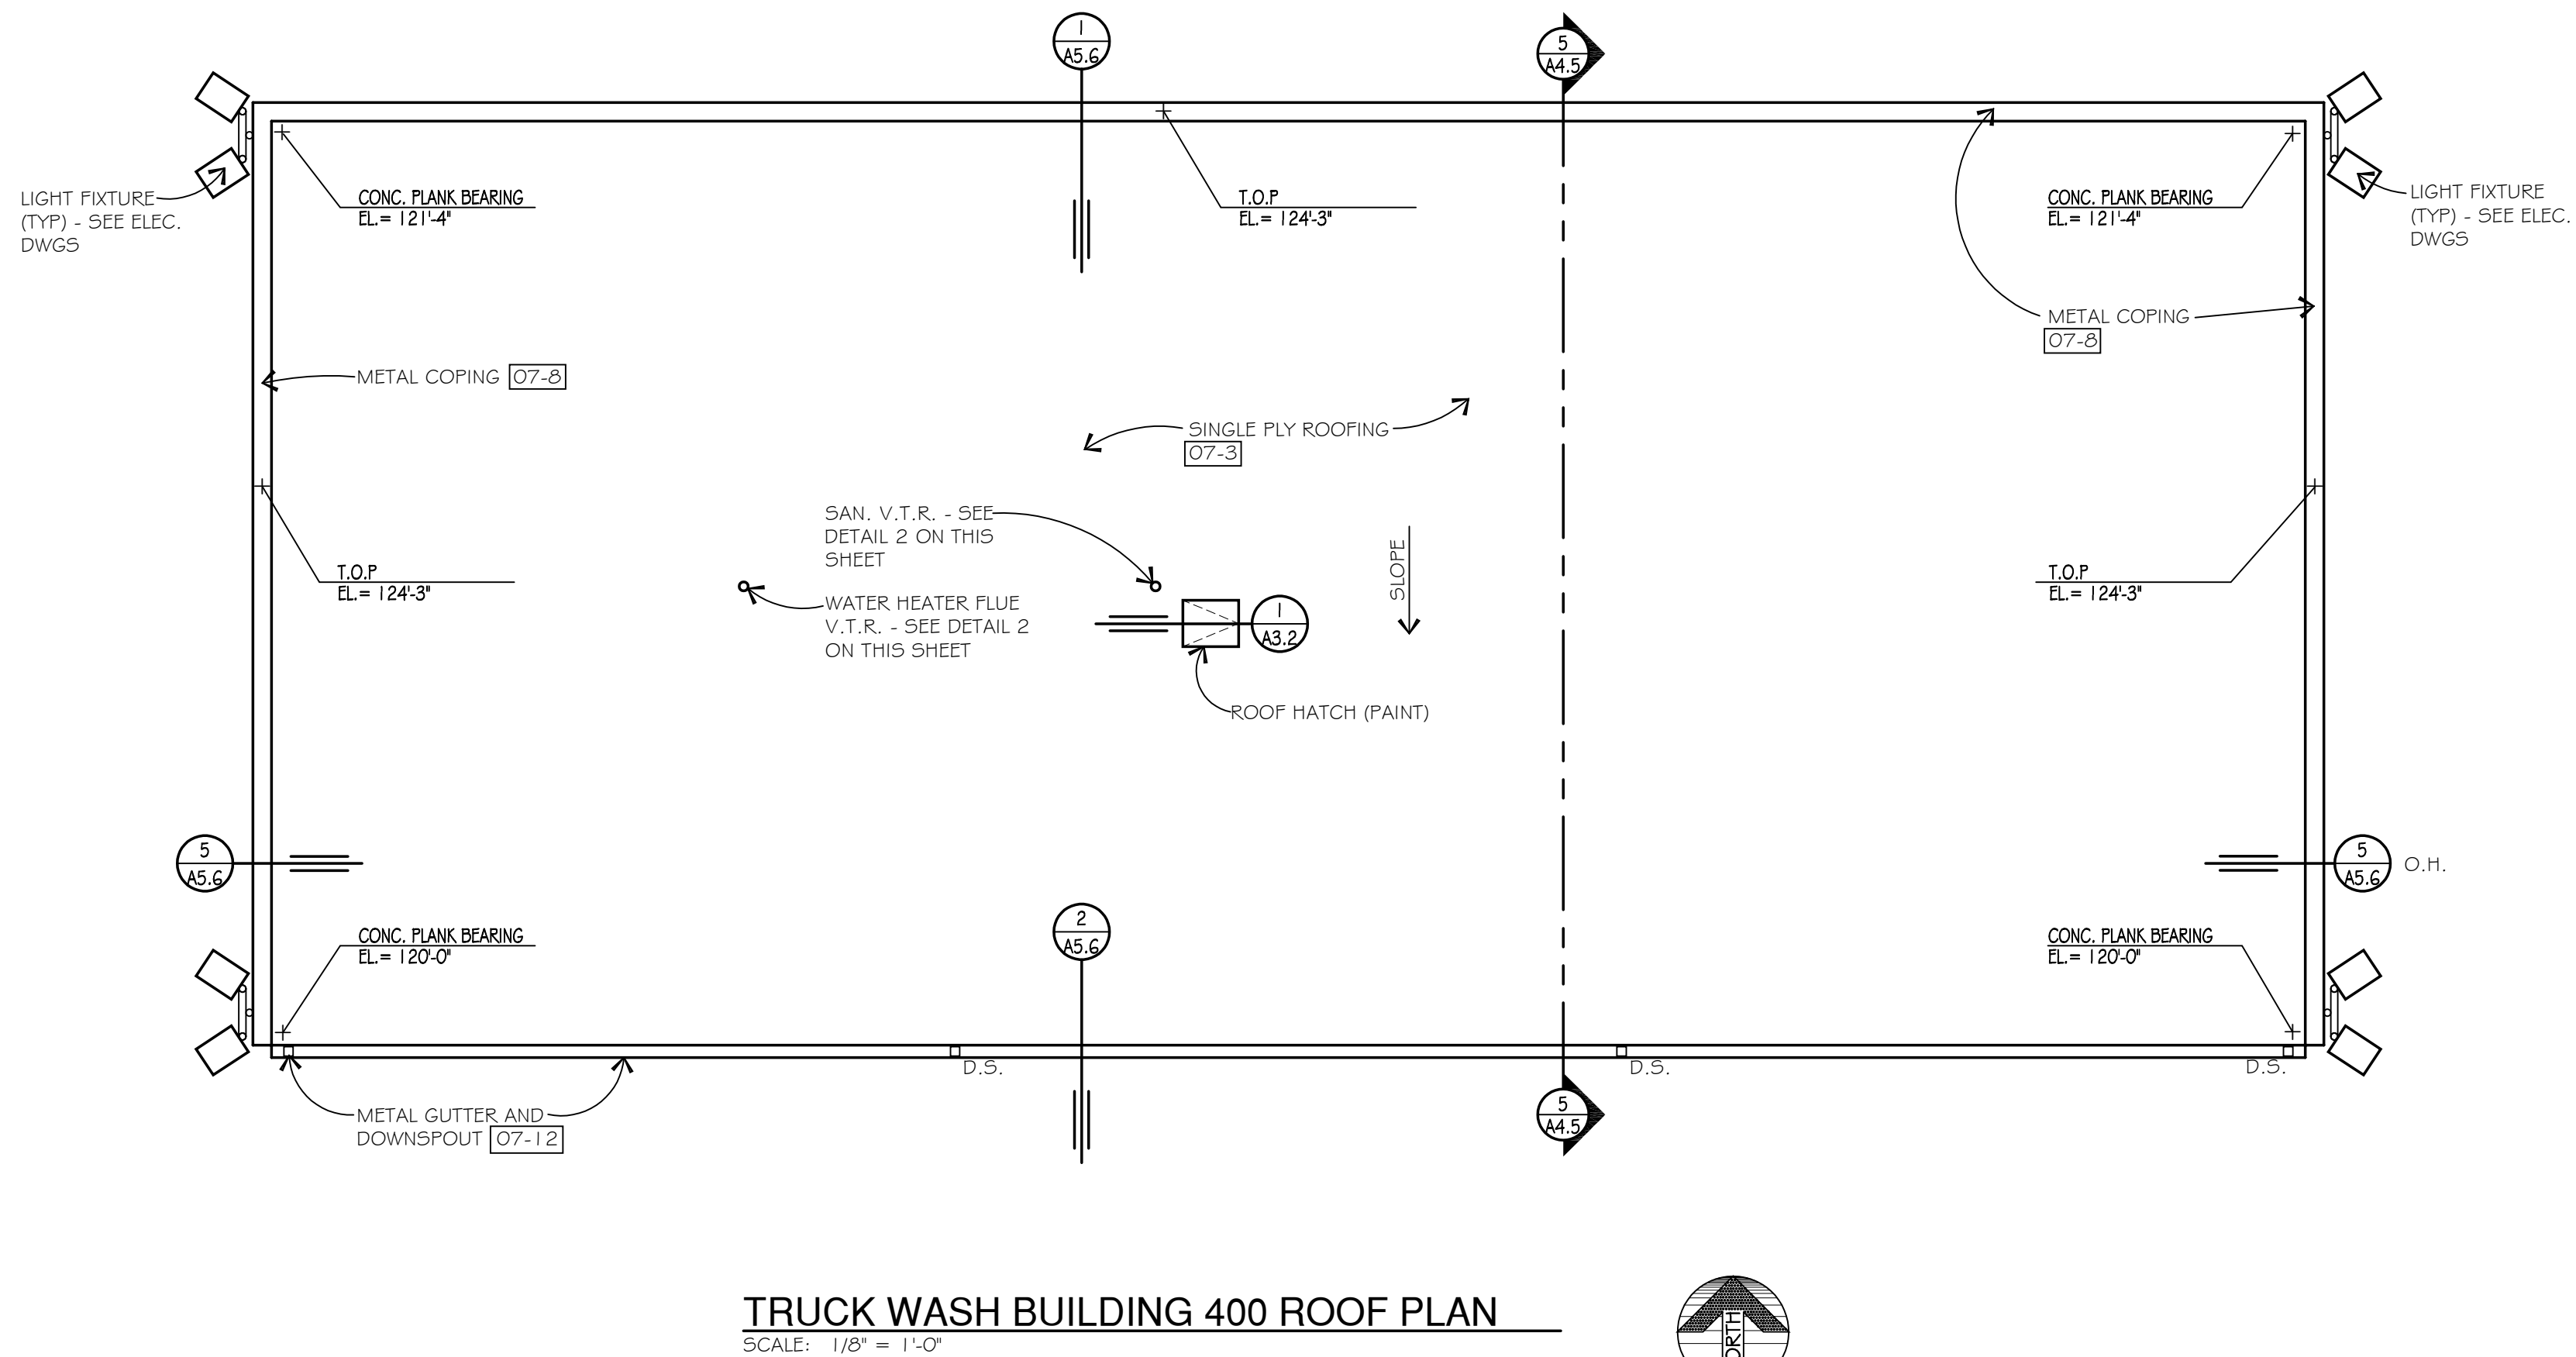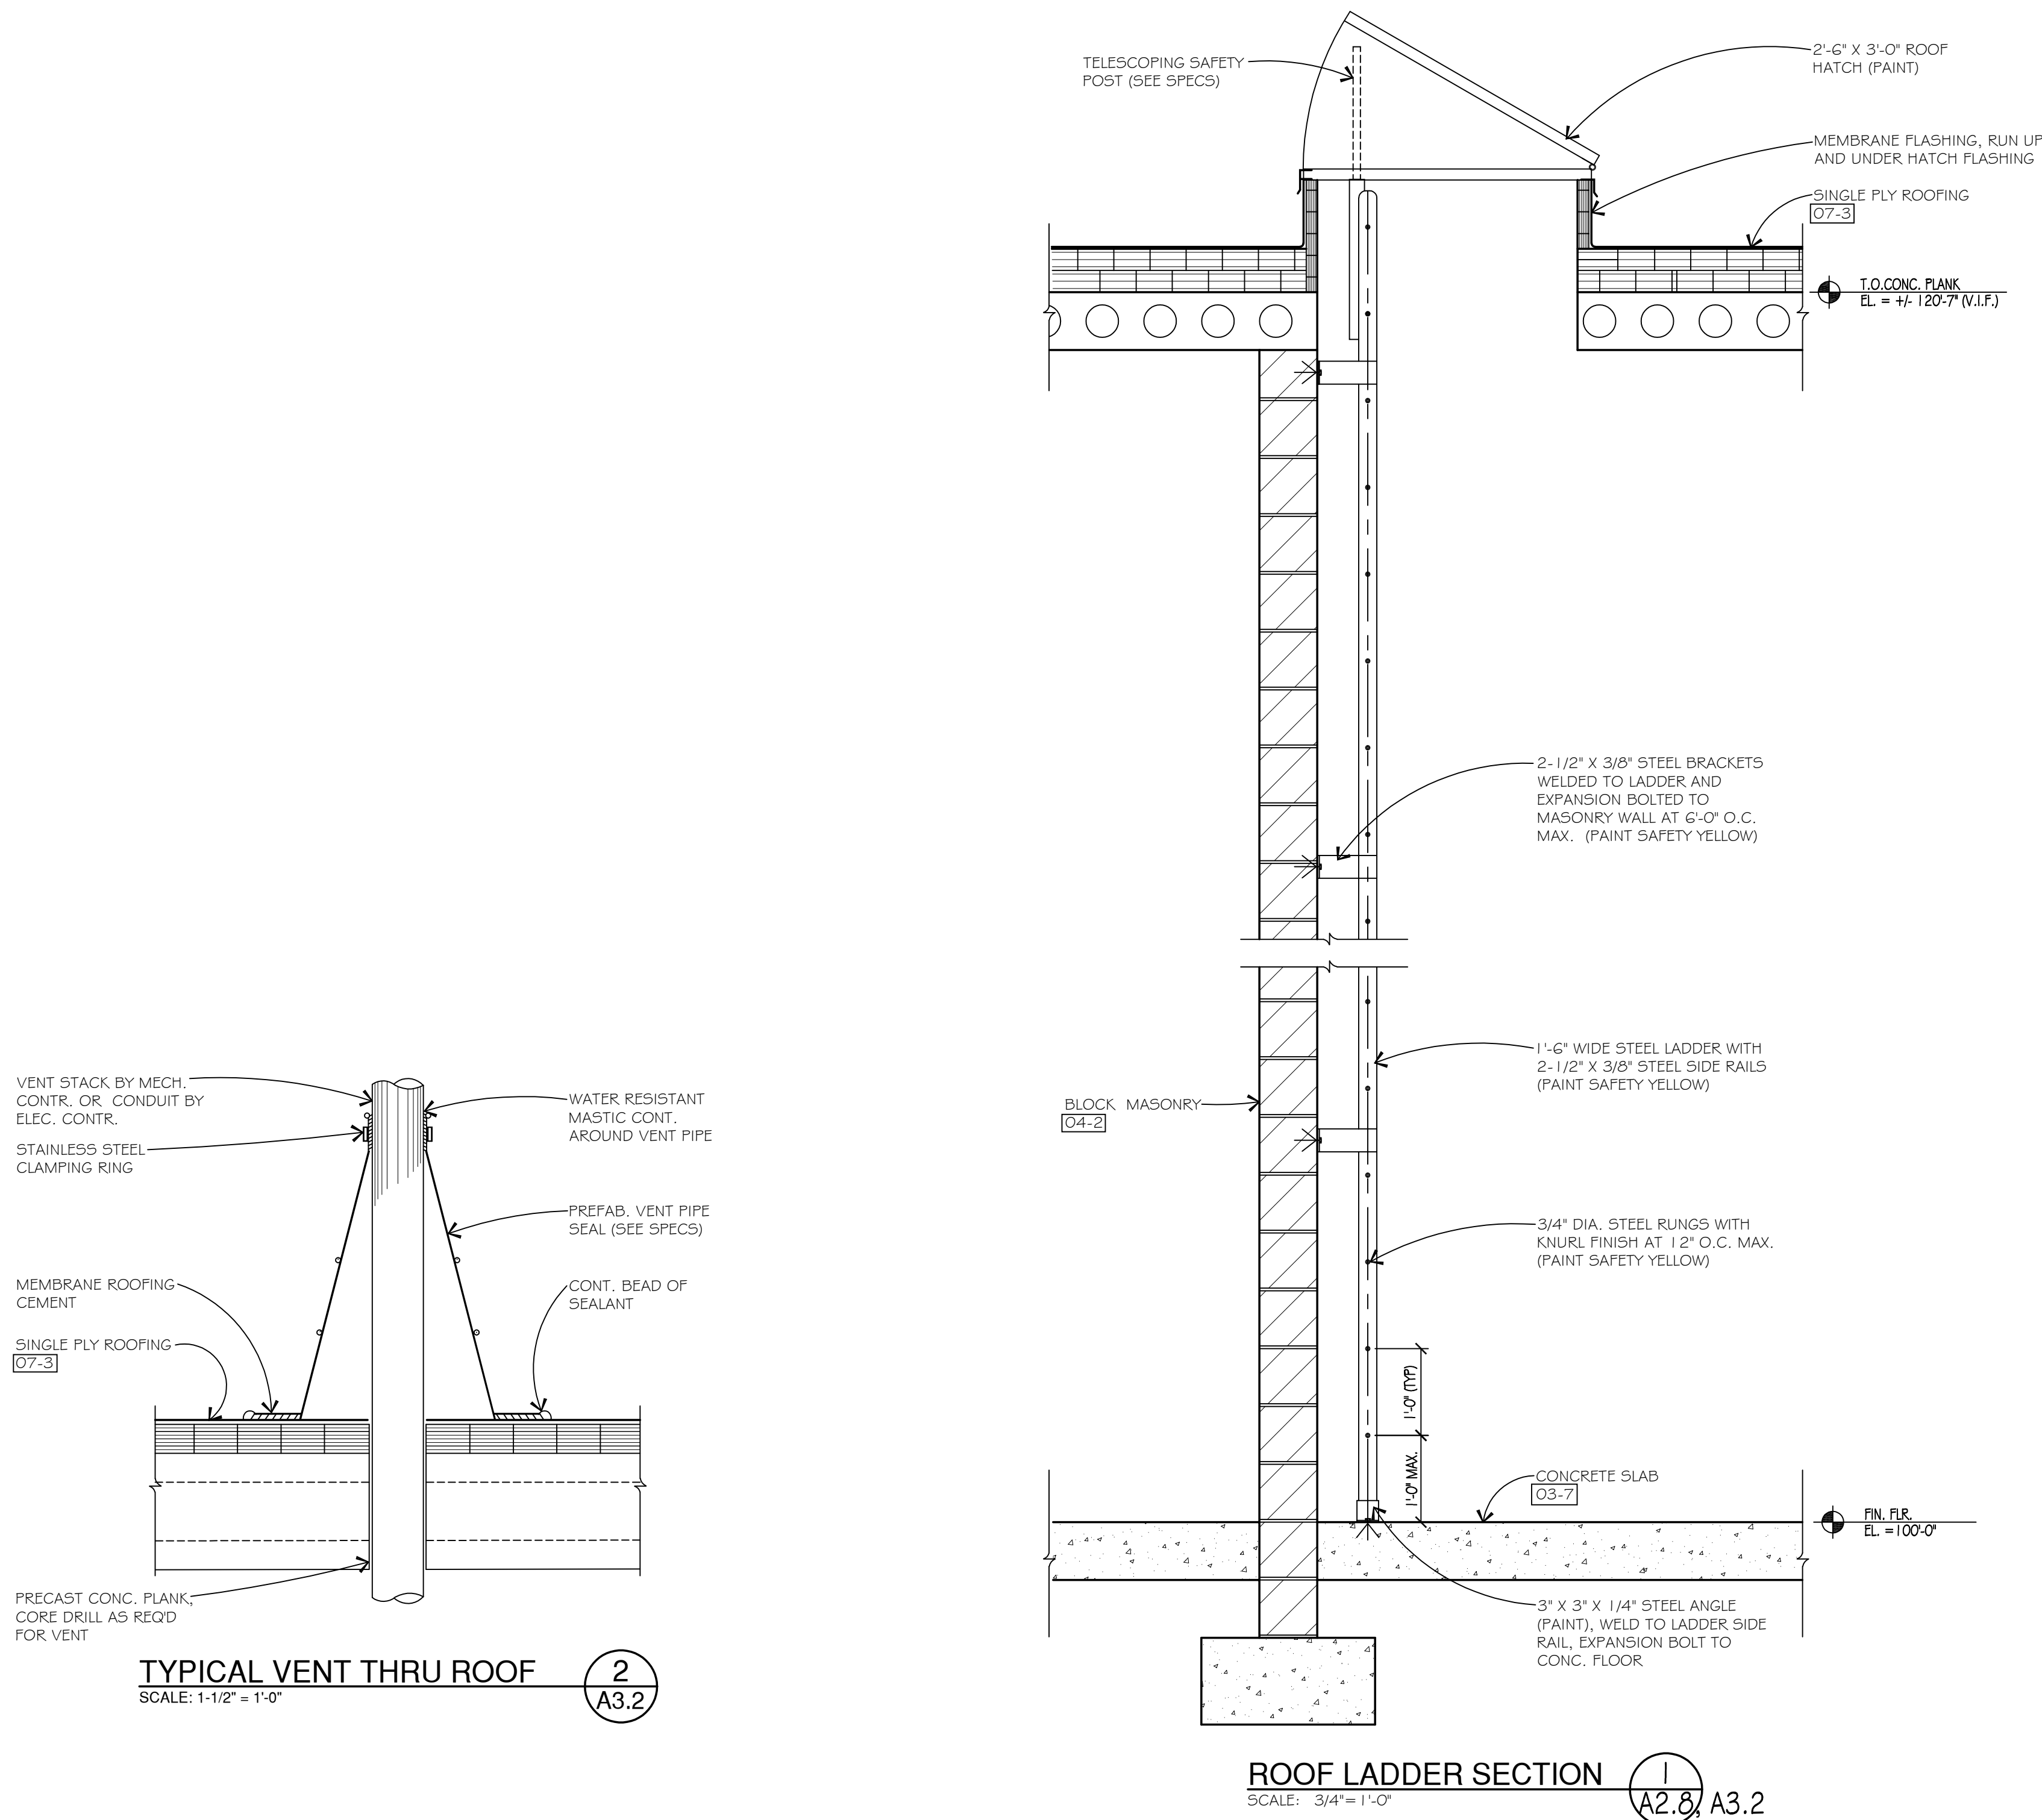ALUMINUM STOREFRONT: 1" INSULATED TINTED GLAZING WITH DARK BRONZE ANODIZED ALUMINUM FRAME.  
SEE ELEVATIONS FOR NOTE REGARDING SPANDREL WINDOW UNITS.

#### GUTTER/DOWNSPOUTS:

PREFINISHED METAL GUTTER AND DOWNSPOUTS: POLAR WHITE

#### BOLLARDS:

PRIMED AND PAINTED "SAFETY YELLOW"

#### DOCK LADDERS AT TERMINALS:

PRIMED AND PAINTED "SAFETY YELLOW"

#### DOCK EQUIPMENT:

DOCK PERIMETER CHANNEL (ALL EXPOSED FACES) PAINT GRAY  
DOCK LEVELER, BUMPERS AND APPROACH PLATES, PAINT GRAY

#### POLE MOUNTED EXTERIOR FLOOD LIGHTS:

PAINT STEEL BRACKET AND POLE TO MATCH LIGHT FIXTURE FINISH.

#### EXTERIOR OVERHANG STRUCTURAL STEEL BEAM:

SHOP PRIME AND PAINTED TO MATCH PRIMER GRAY COLOR.

#### EXTERIOR STAIRS AND RAILINGS:

GUARD RAILS, HANDRAILS, STEEL CHANNEL FRAMES AND STRINGERS PRIME AND PAINT "SAFETY YELLOW". GALVANIZED RISERS, GALVANIZED GRATING, STAIR PLATFORM AND TREADS TO REMAIN EXPOSED

#### EXTERIOR UTILITY CONDUITS AND PIPING:

PRIME AND PAINTED TO MATCH ADJACENT MATERIAL COLOR

#### EIFS:

EIFS MAIN WALL COLOR: COLOR TO MATCH "POLAR WHITE" ROOFING WALL PANELS, COORDINATE COLOR WITH PEMB SUPPLIER "POLAR WHITE" COLOR.  
EIFS RECESS ACCESS BAND COLOR TO MATCH SHERWIN WILLIAMS "GREEN RL" (IME B54 T 104)

#### NOTES:

1. SEE SPECIFICATIONS FOR ADDITIONAL INFORMATION ON PRODUCTS AND MANUFACTURERS.



2. VERIFY ALL FINISH COLORS WITH OWNER.

3. SUBMIT COLOR SAMPLES FOR ALL FINISH MATERIAL LISTED FOR REVIEW AND APPROVAL PRIOR TO PURCHASING AND INSTALLATION OF FINISH MATERIALS.






#### ELEVATION NOTES:


1. EIFS RECESS BAND TO FOLLOW ROOF SLOPE AND ALIGN WITH TOP EIFS RECESS BAND ON NORTH AND SOUTH SIDE ELEVATIONS.

2. AT SIGNAGE LOCATION GENERAL CONTRACTOR IS TO PROVIDE 5/8" F.R.T. PLYWOOD SHEATHING IN LIEU OF 5/8" DENS GLASS GYPSUM BOARD. GENERAL CONTRACTOR TO COORDINATE SIZE REQUIRED WITH R+L SIGN VENDOR. BUILDING SIGN TO BE PROVIDED AND INSTALLED BY GENERAL CONTRACTOR.  
SIGN VENDOR - SIGNARAMA  
CONTACT: BRUCE AHLSEWIDE - DIRECTOR OF SERVICE  
1012 SAN PEDRO AVE.  
SAN ANTONIO, TX 78212  
bahlsew@signglobalbsign.com  
210-368-1820  
210-224-5100  
sarsignservice.com

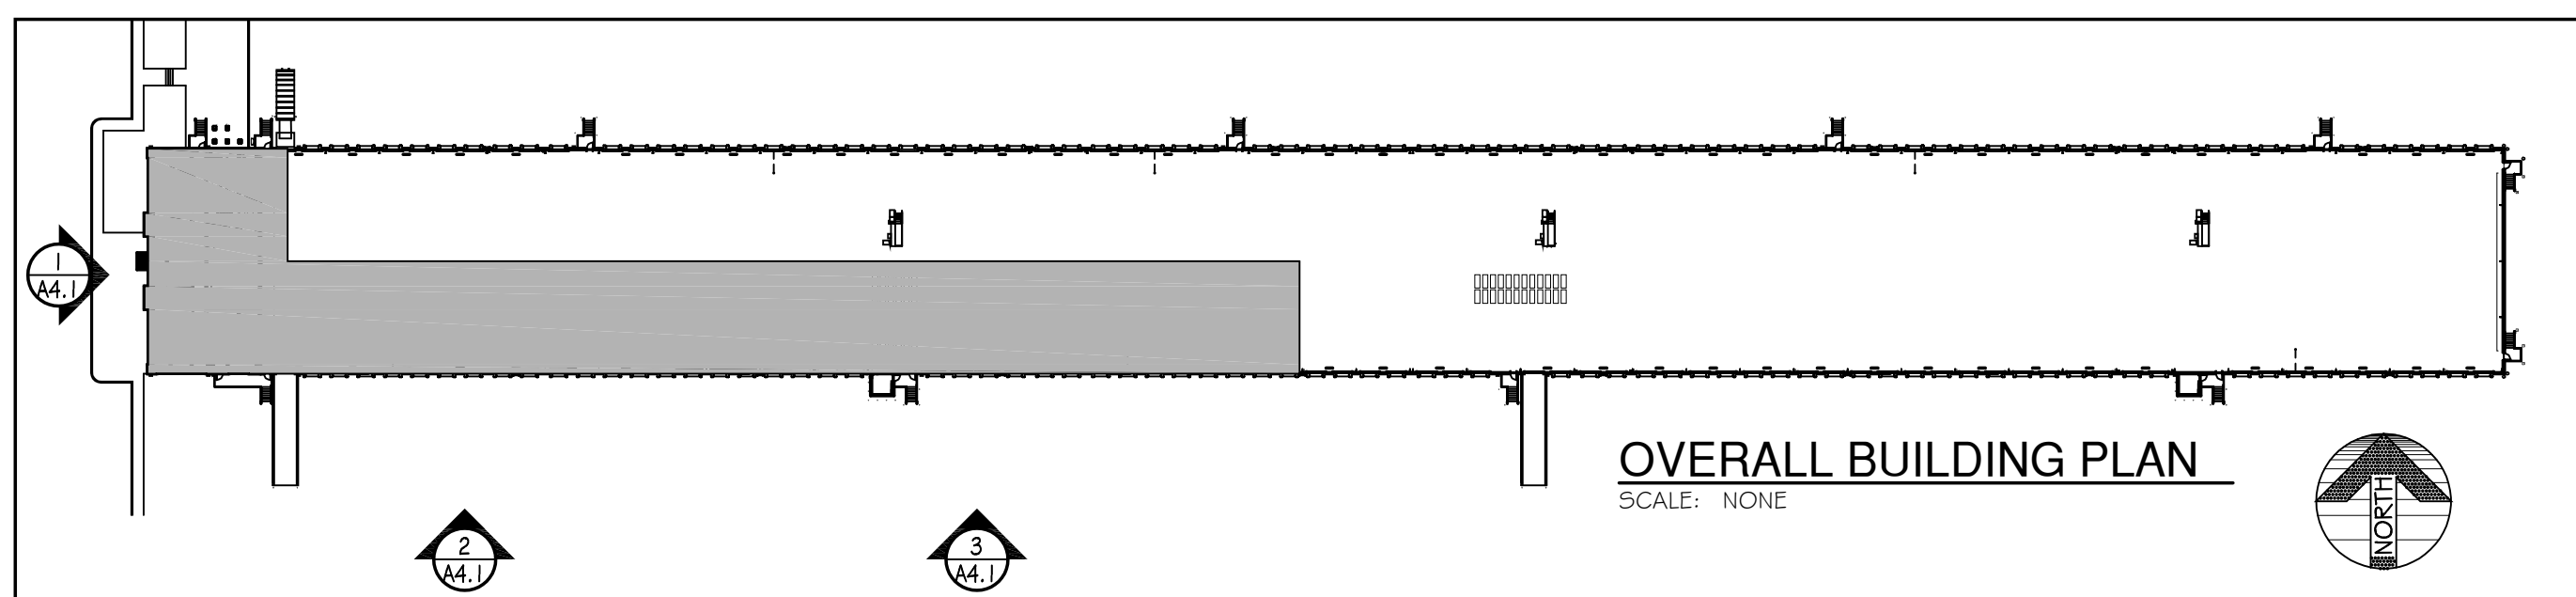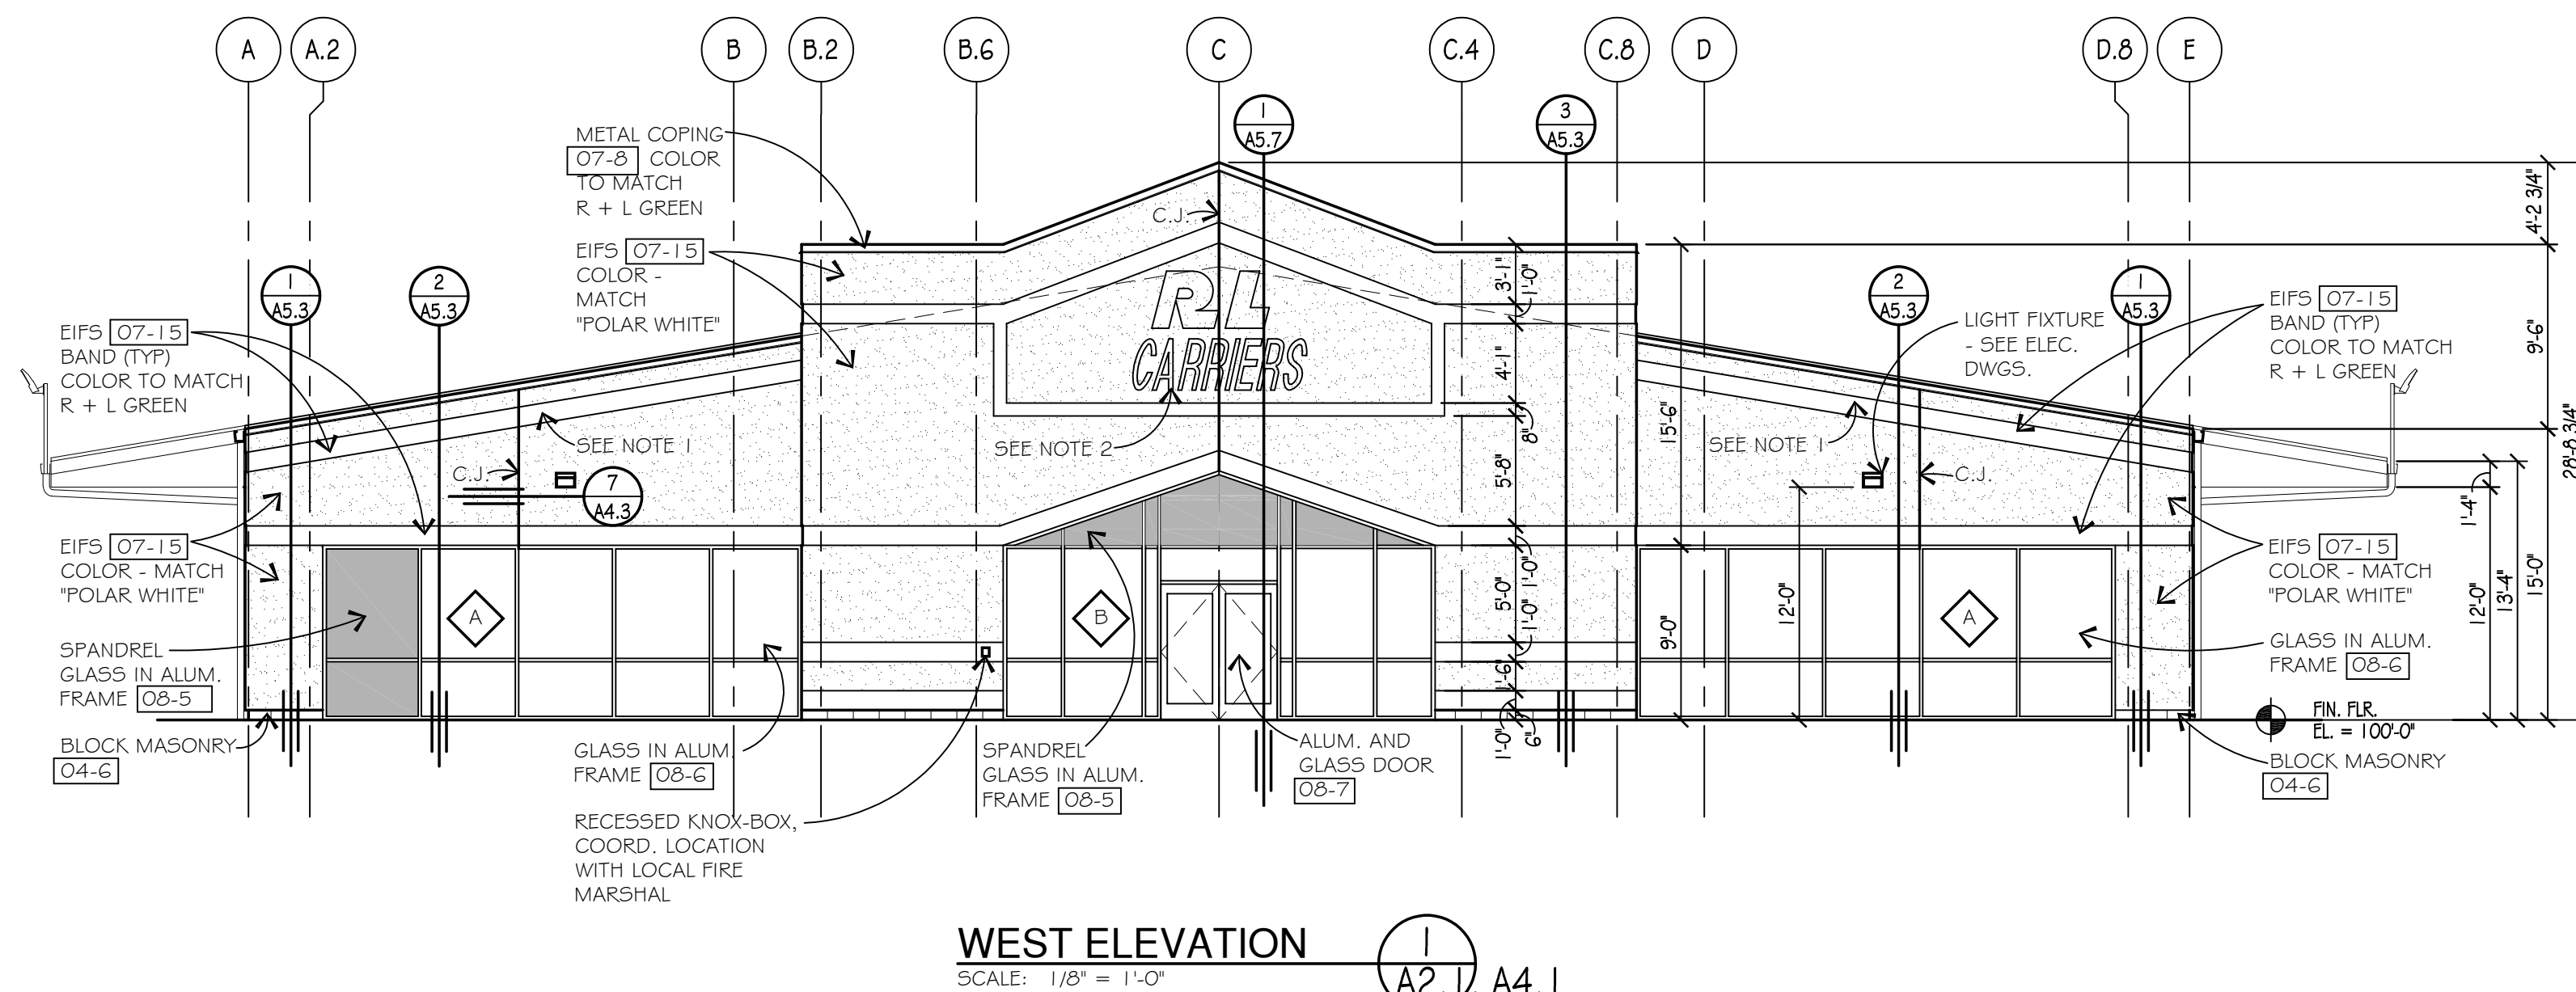



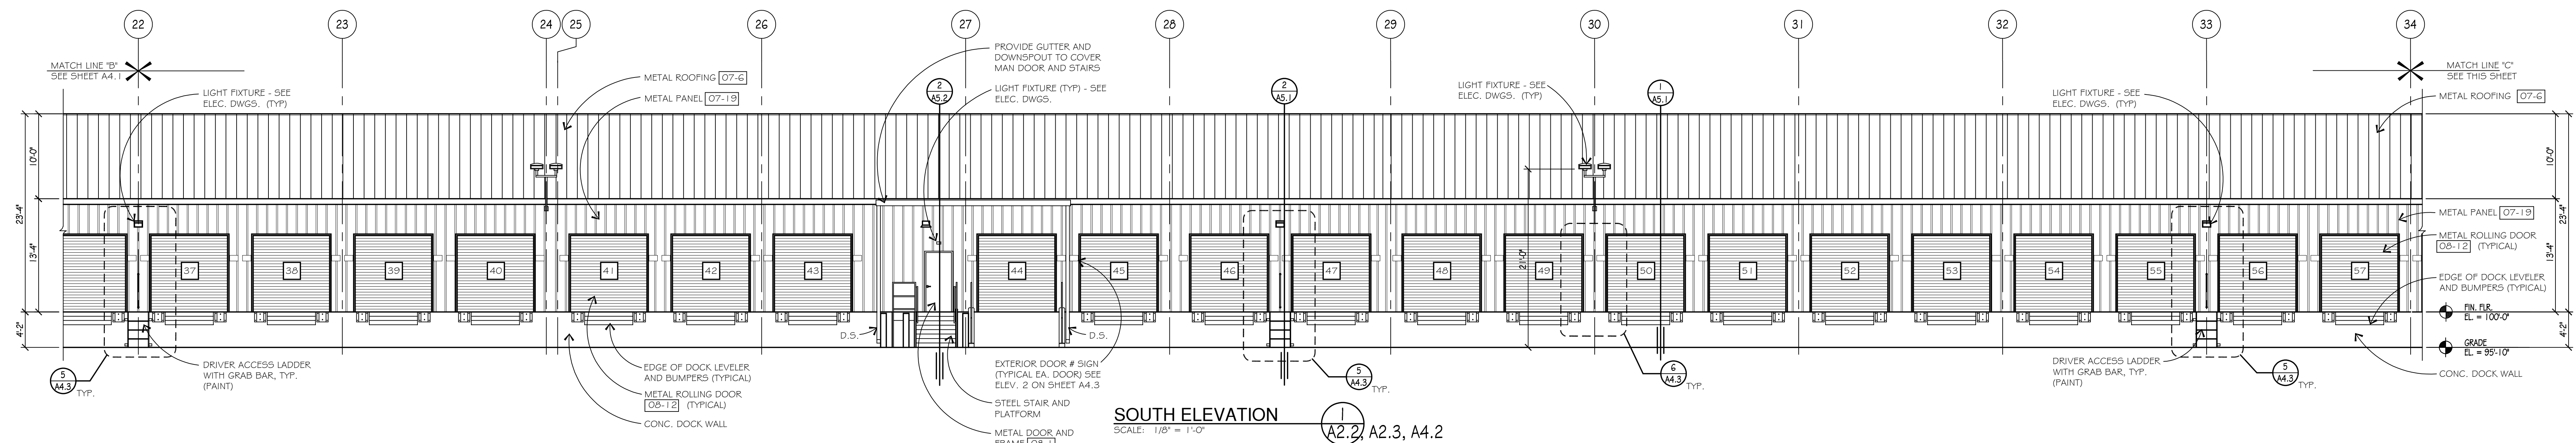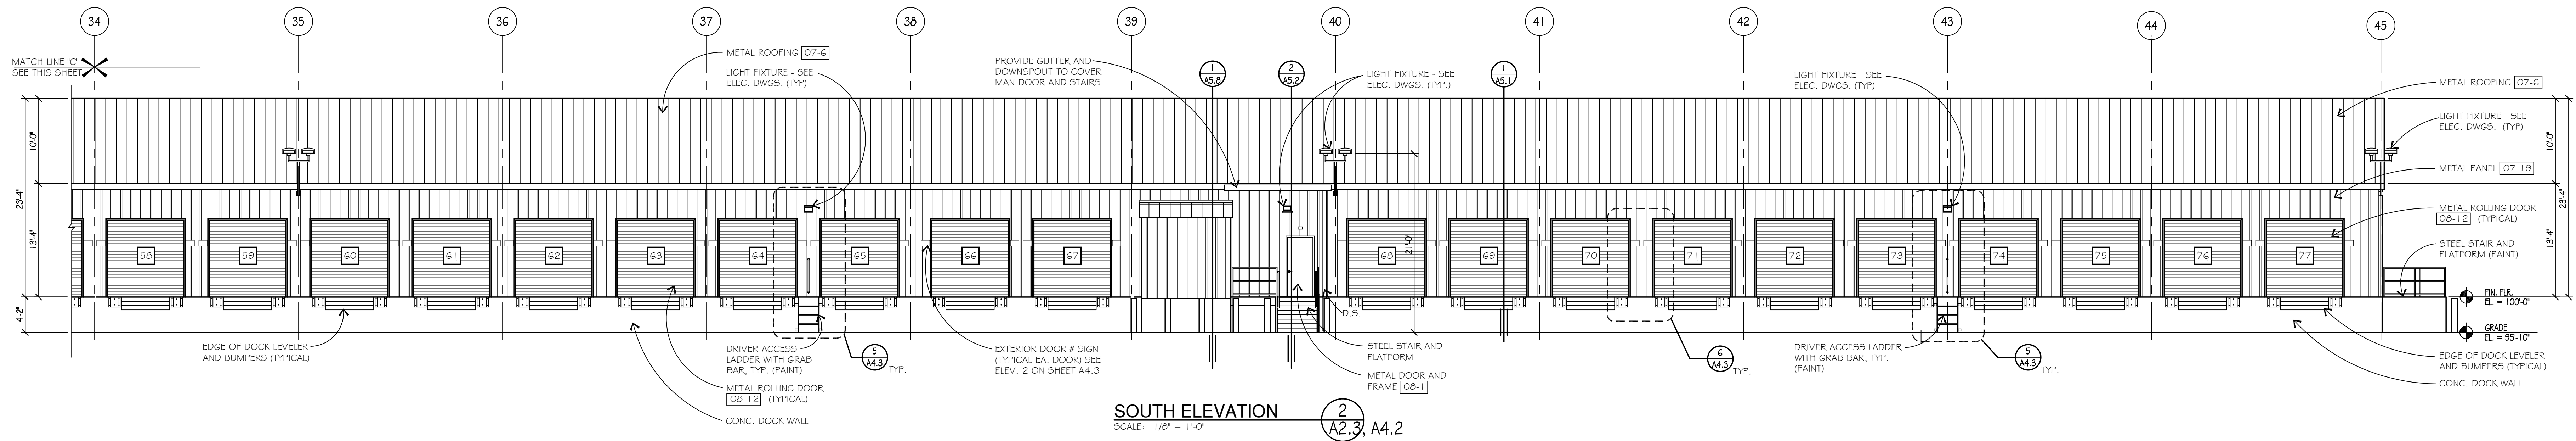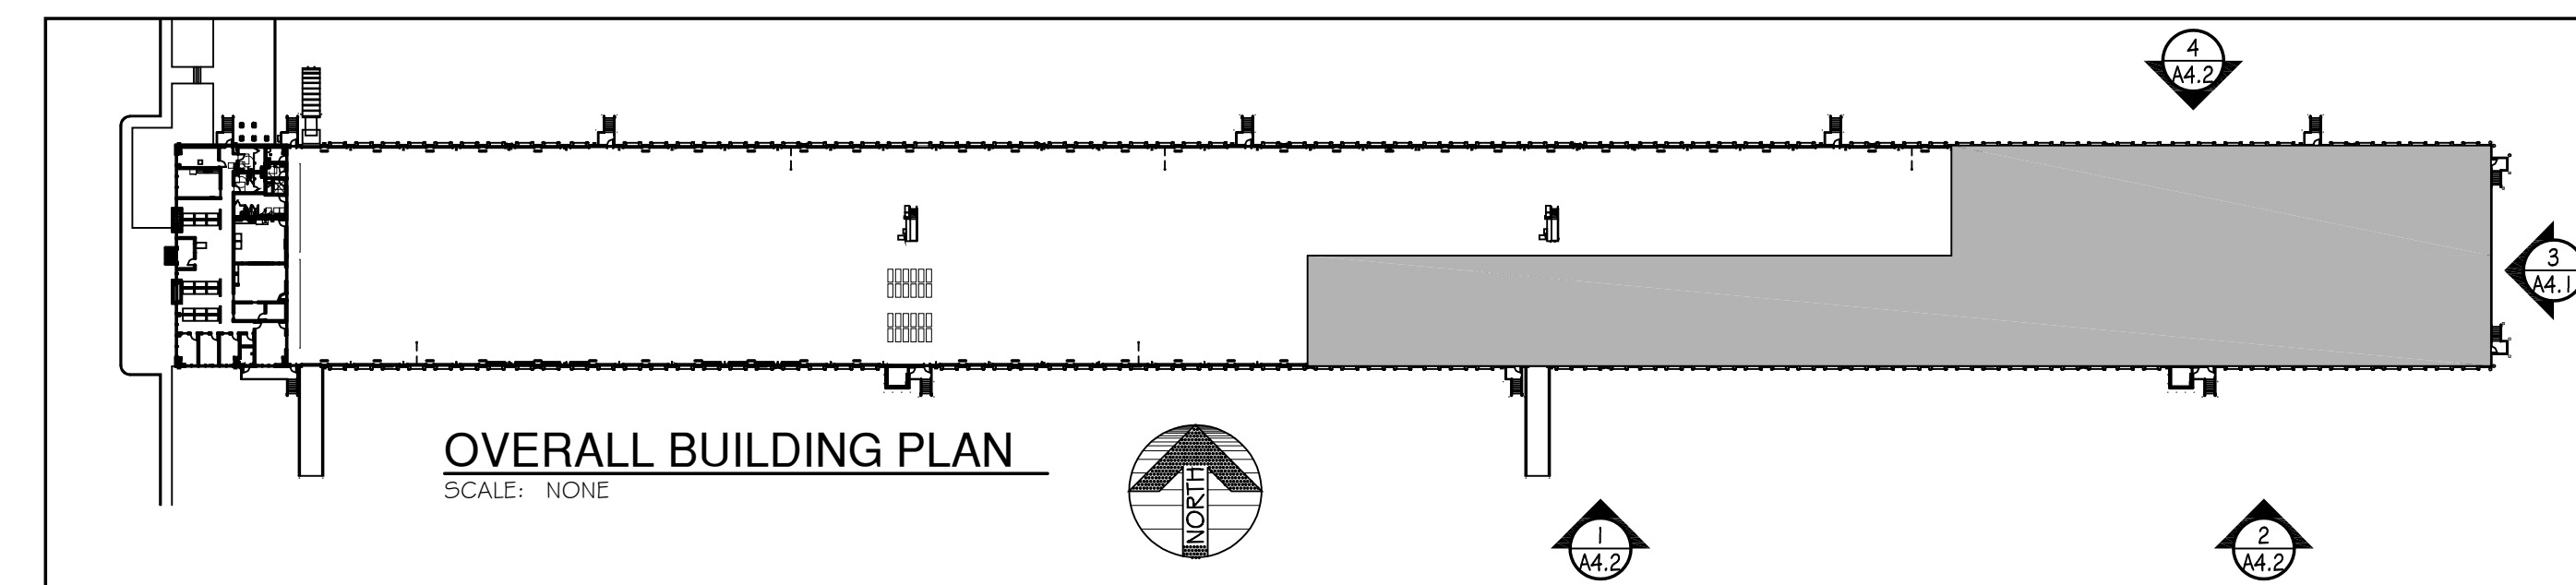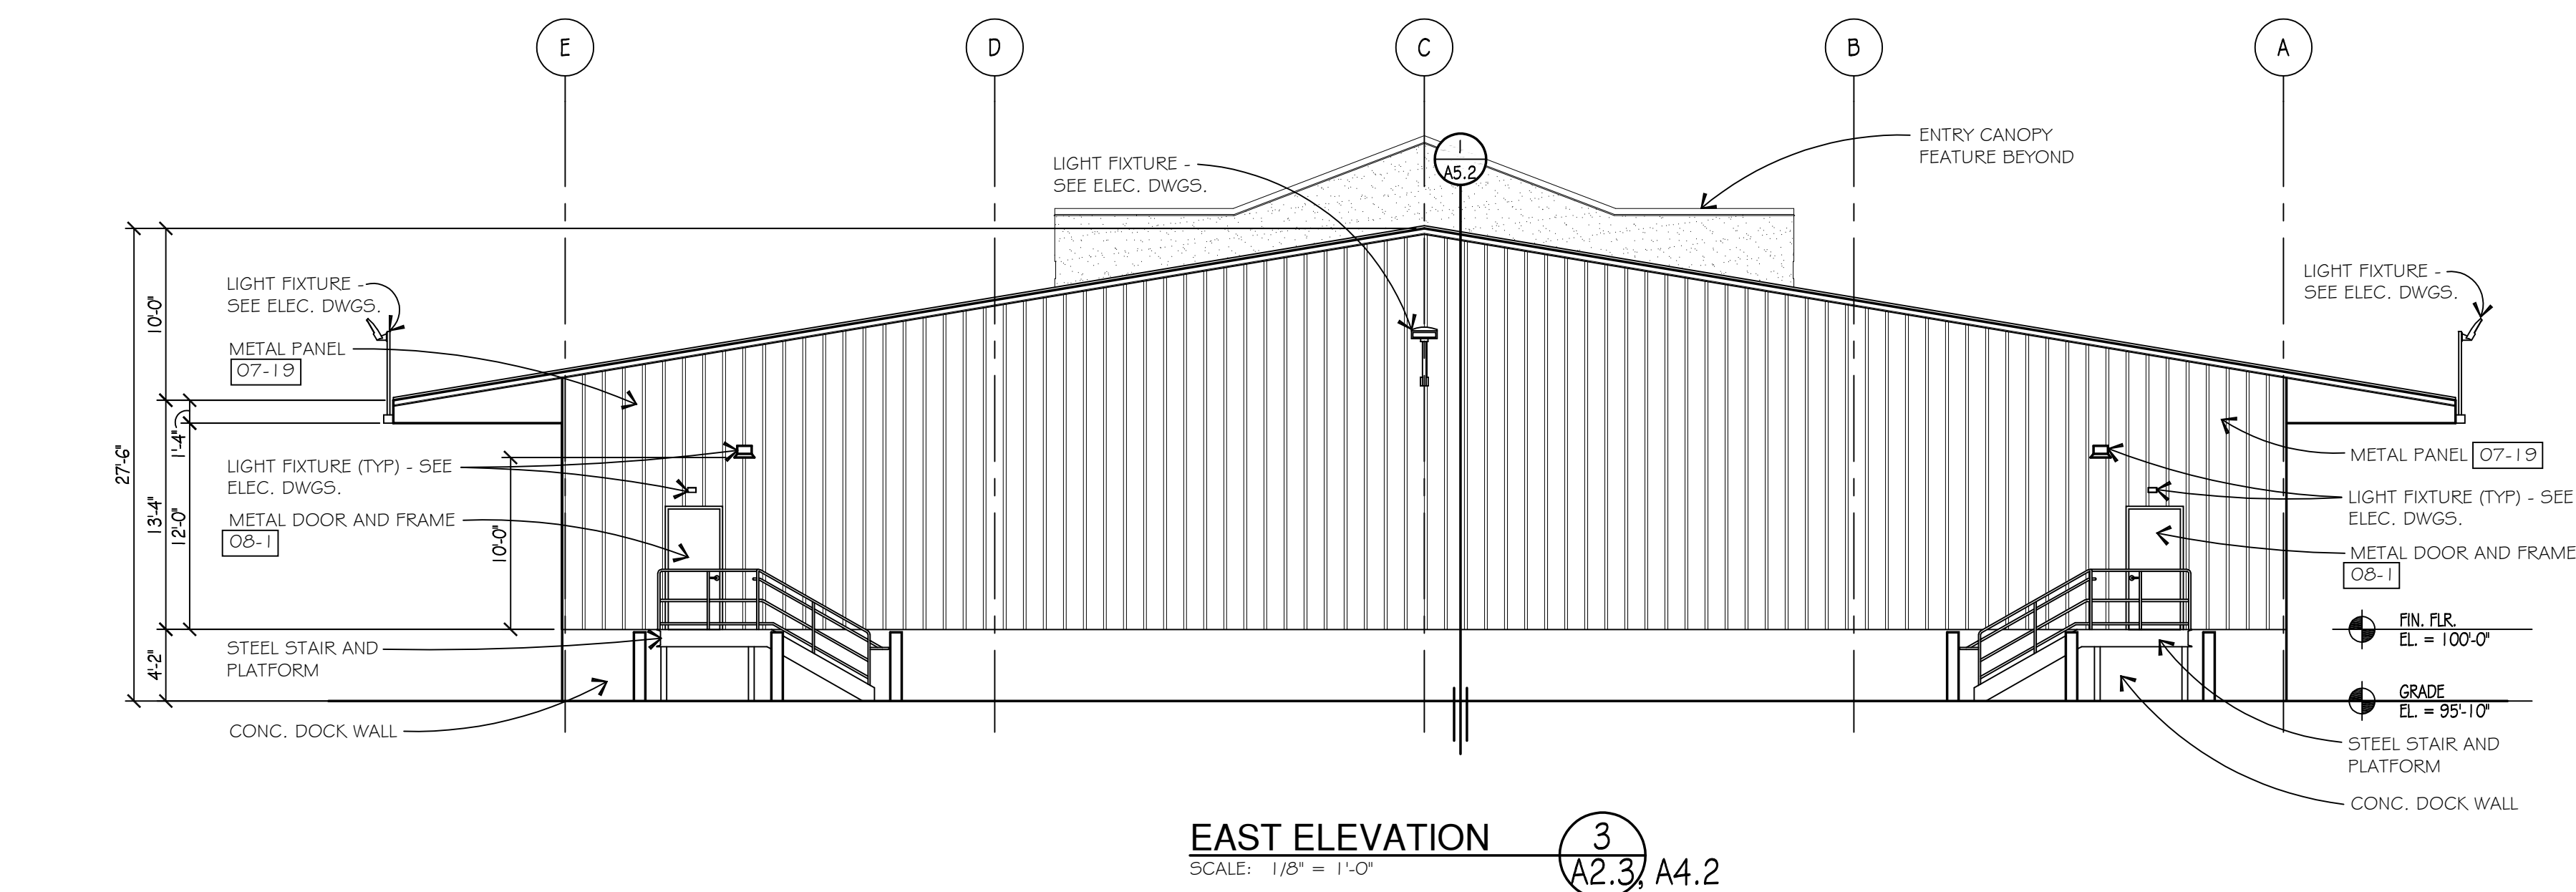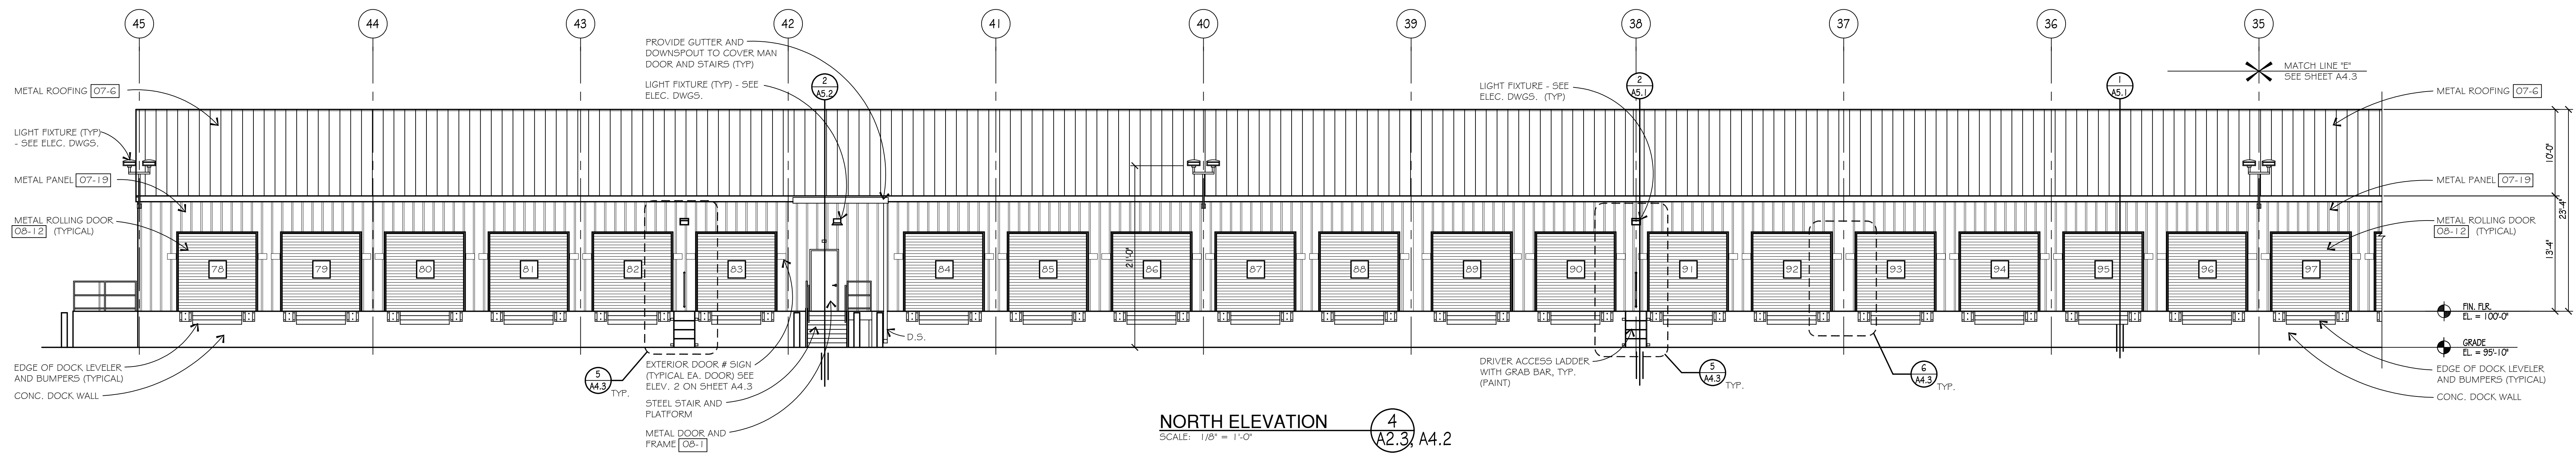

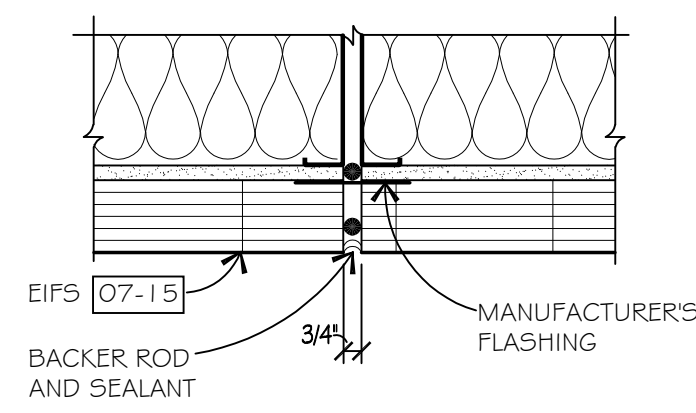


DETAIL 7  
SCALE: 1/4" = 1'-0"

EXTERIOR DOOR SIGN ON EACH SIDE OF OPENING. DOOR NUMBER ASSIGNED BY OWNER. DOOR NUMBER SHOWN ON DRAWINGS ARE CONSTRUCTION REFERENCE ONLY.


6" LETTER, 1" STROKE, BLACK ON WHITE BACKGROUND

NOTE: PROVIDE SIMILAR NUMBER SIGN AT EACH DOCK DOOR INSIDE THE TERMINAL OVER THE DOOR (CENTERED)


DETAIL 6  
SCALE: 1/4" = 1'-0"

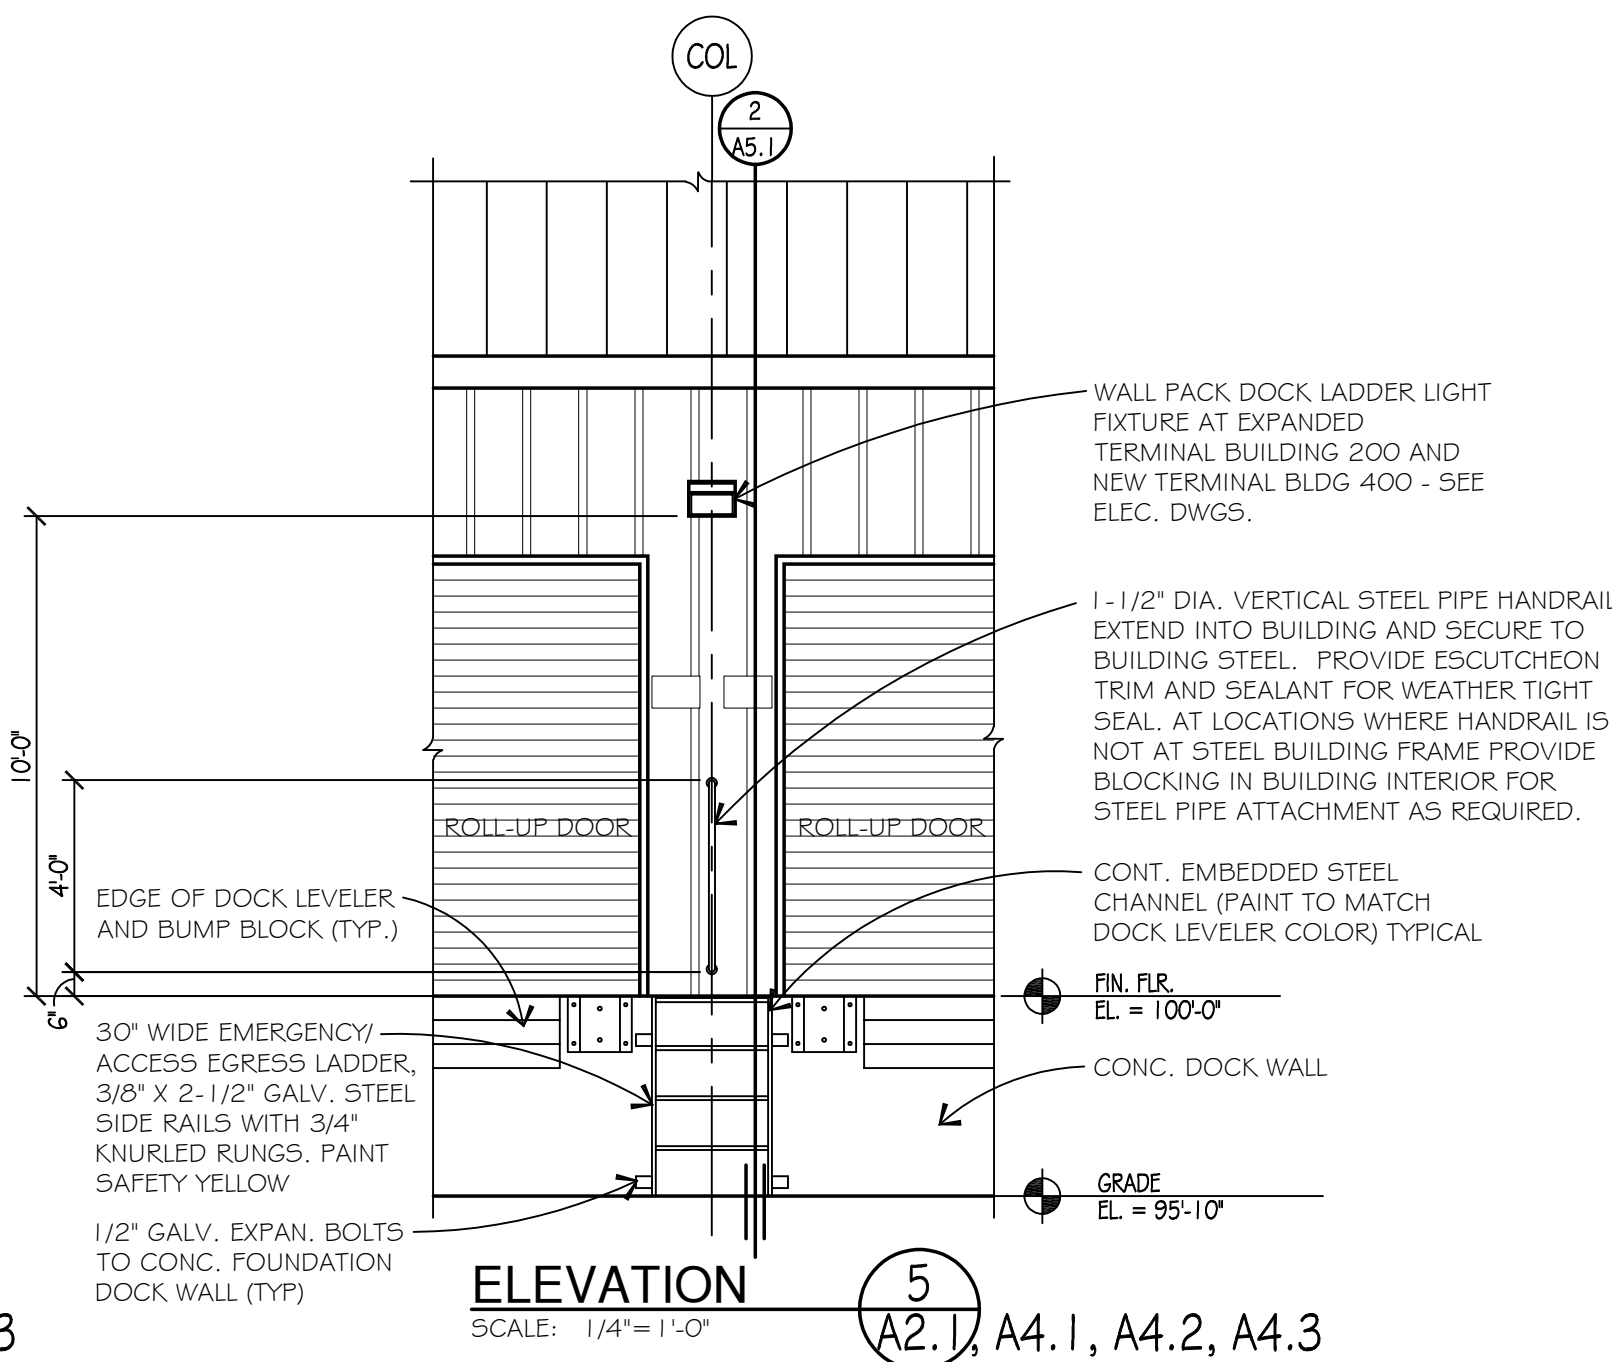


ELEVATION 5  
SCALE: 1/4" = 1'-0"

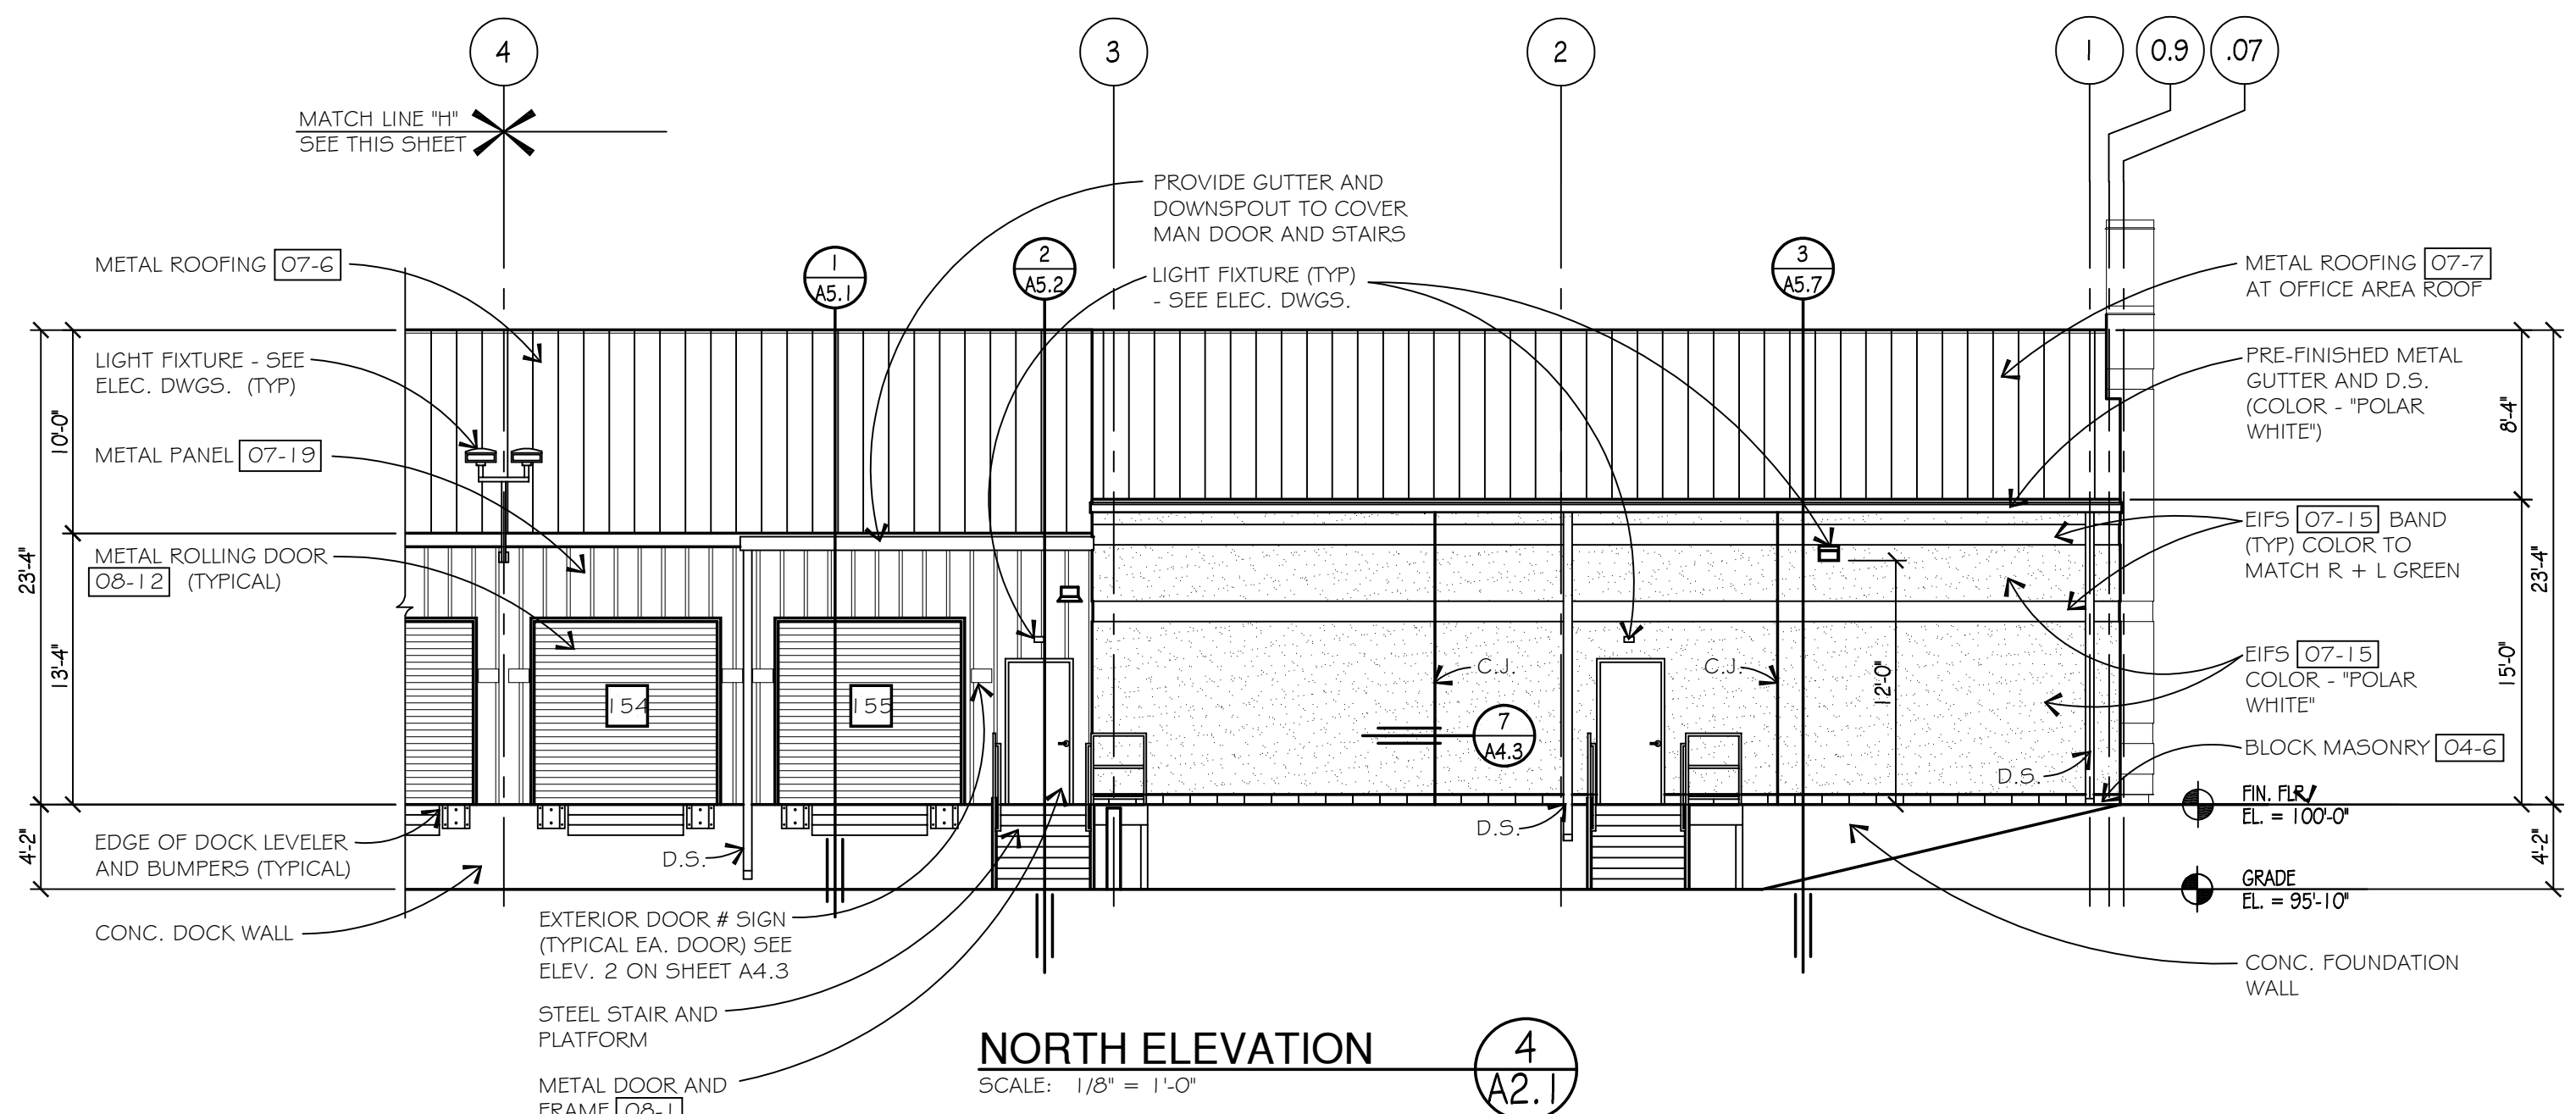


NORTH ELEVATION 4  
SCALE: 1/8" = 1'-0"

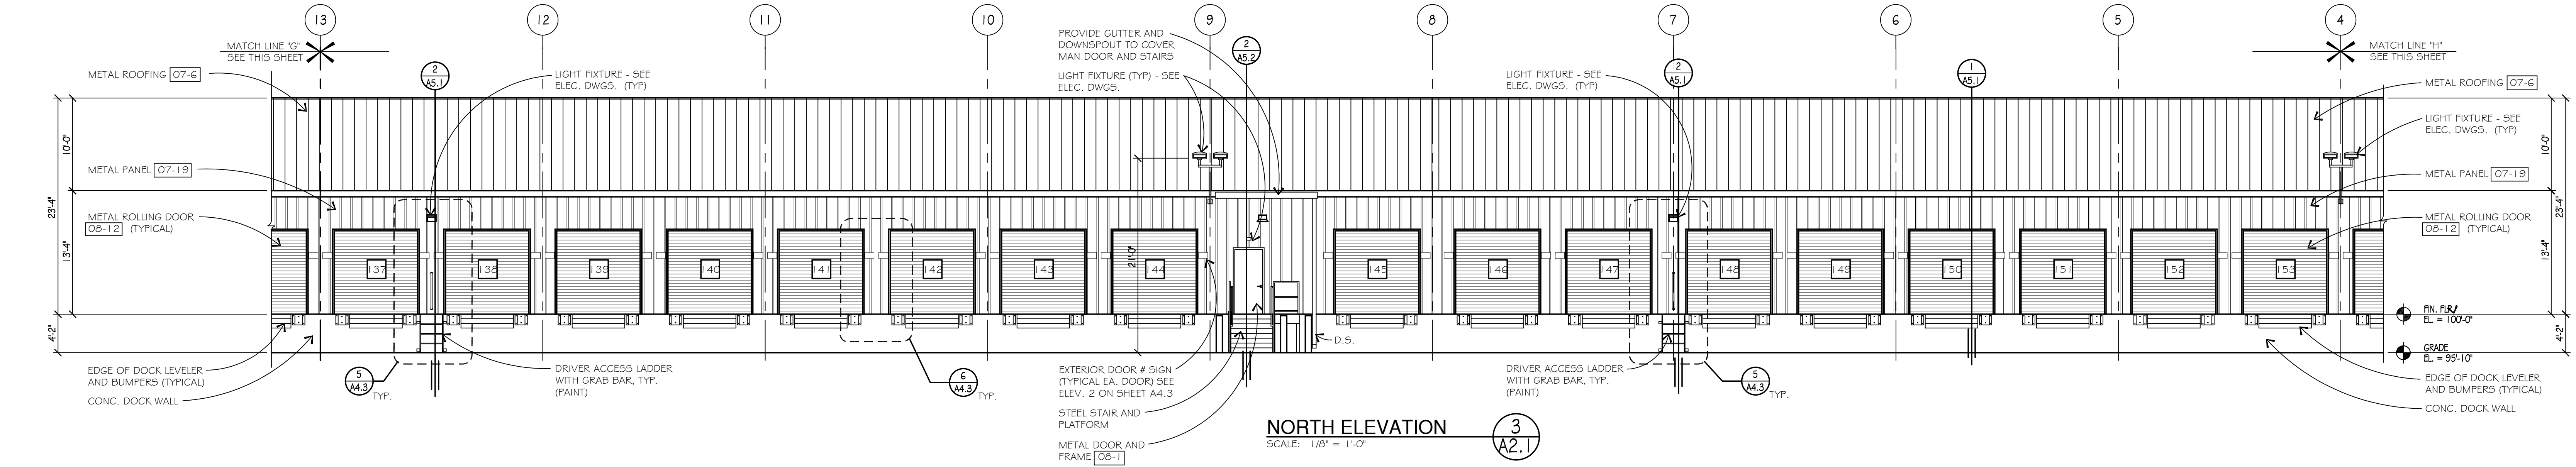


NORTH ELEVATION 3  
SCALE: 1/8" = 1'-0"

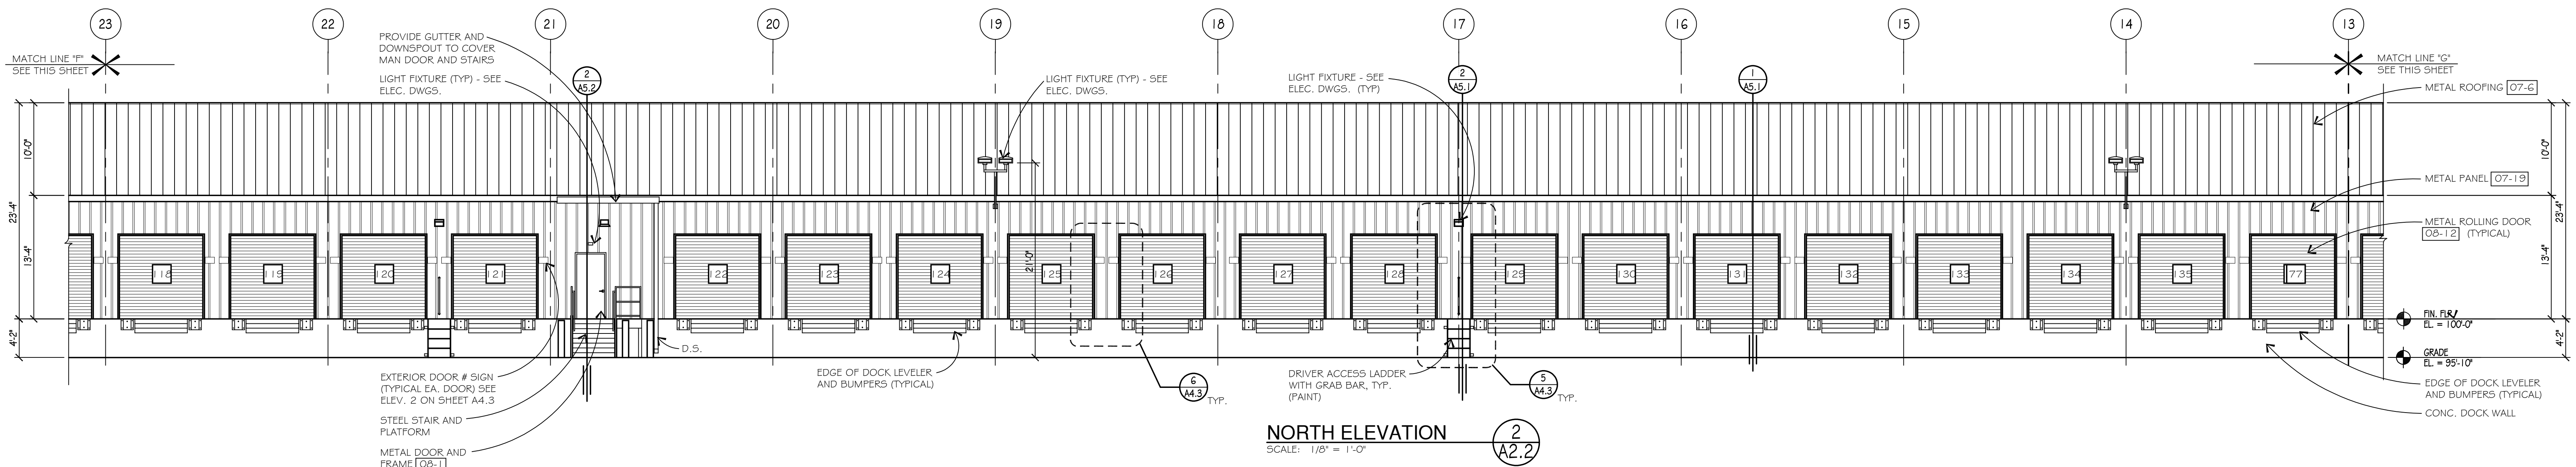

NORTH ELEVATION 2  
SCALE: 1/8" = 1'-0"

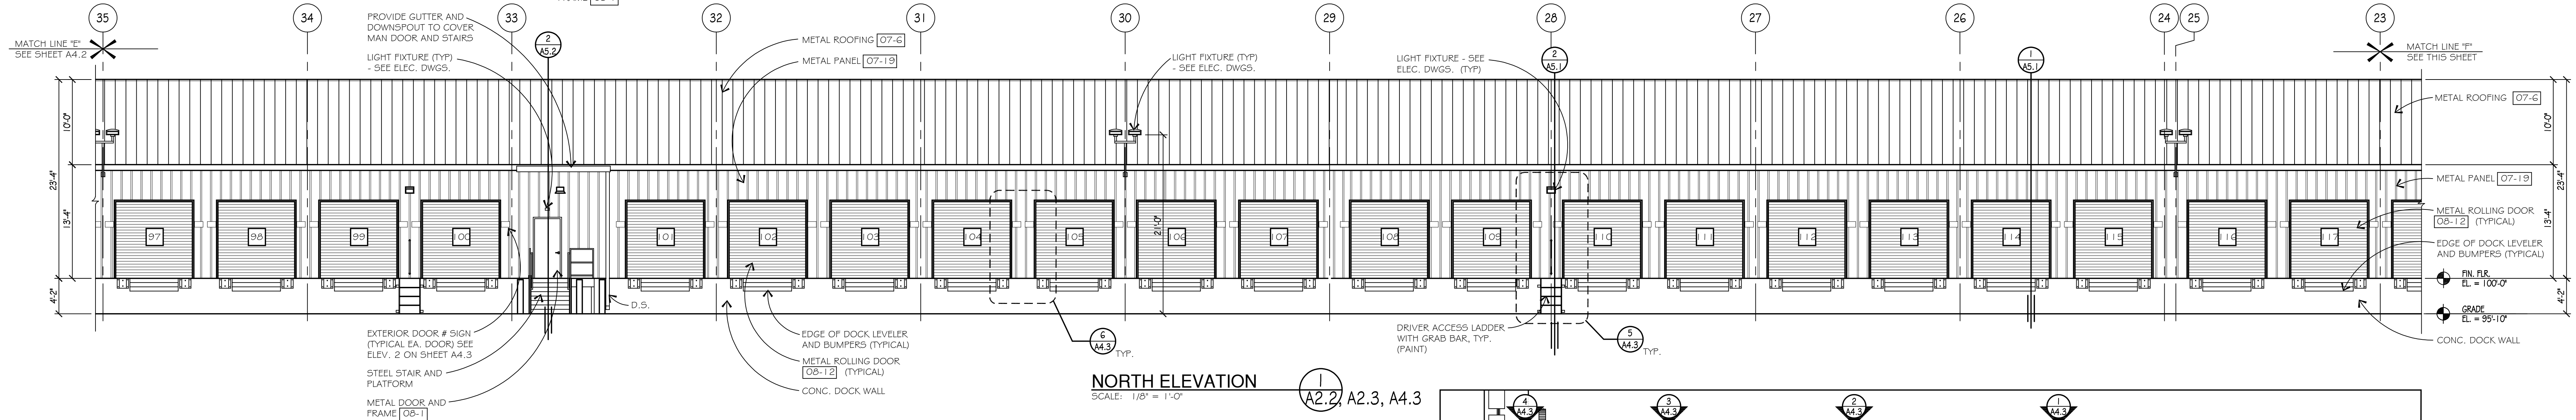


NORTH ELEVATION 1  
SCALE: 1/8" = 1'-0"

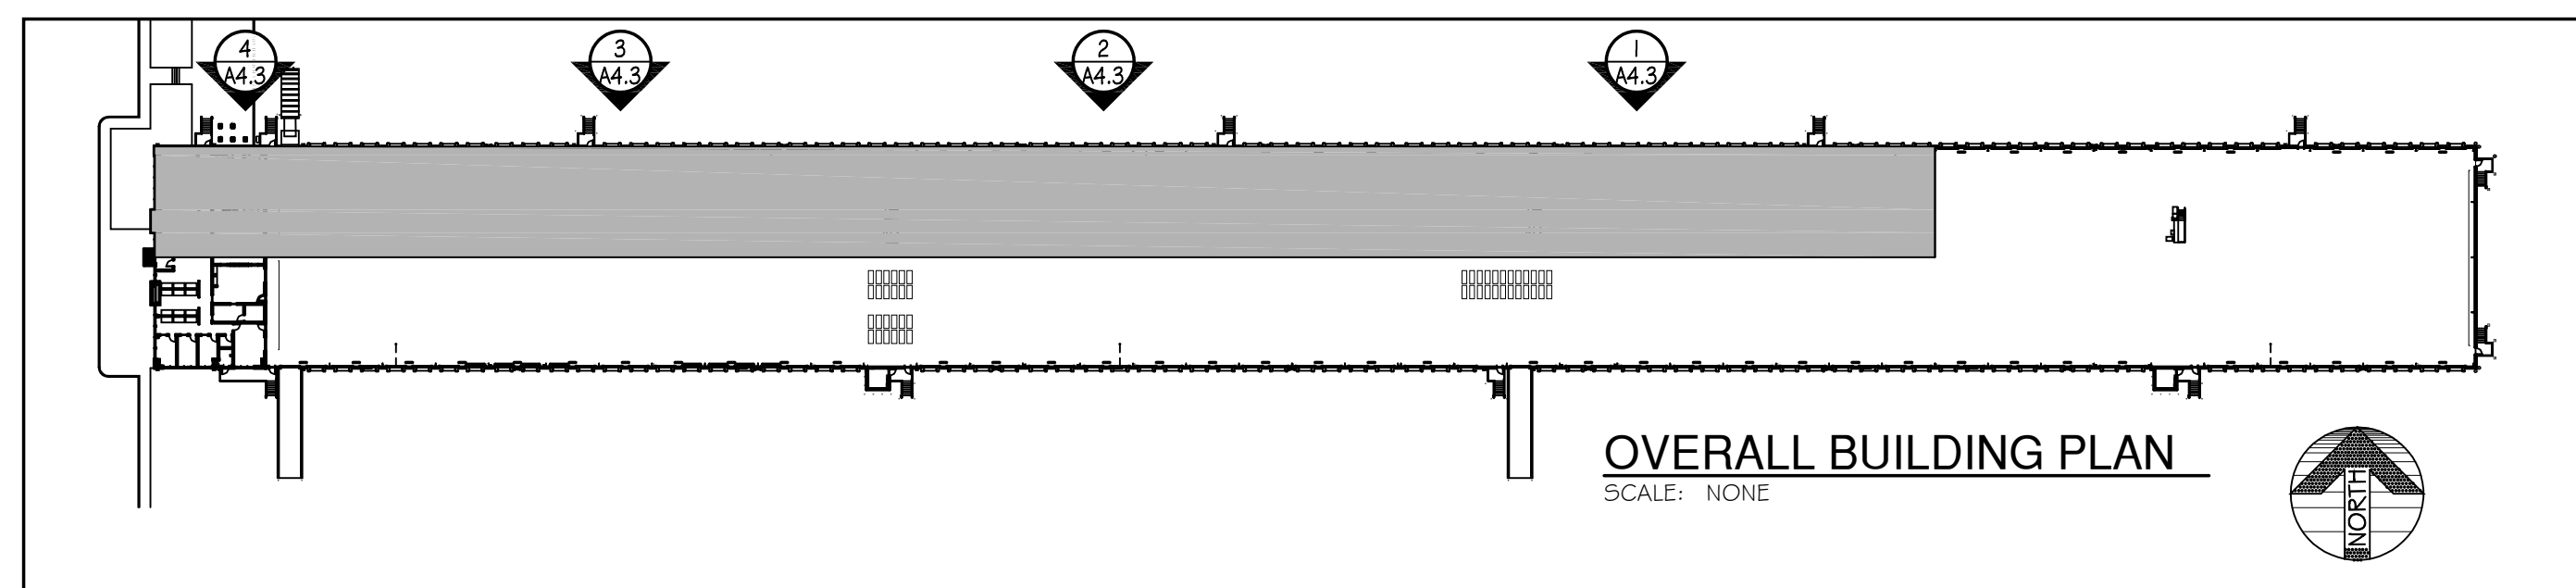

OVERALL BUILDING PLAN  
SCALE: NONE



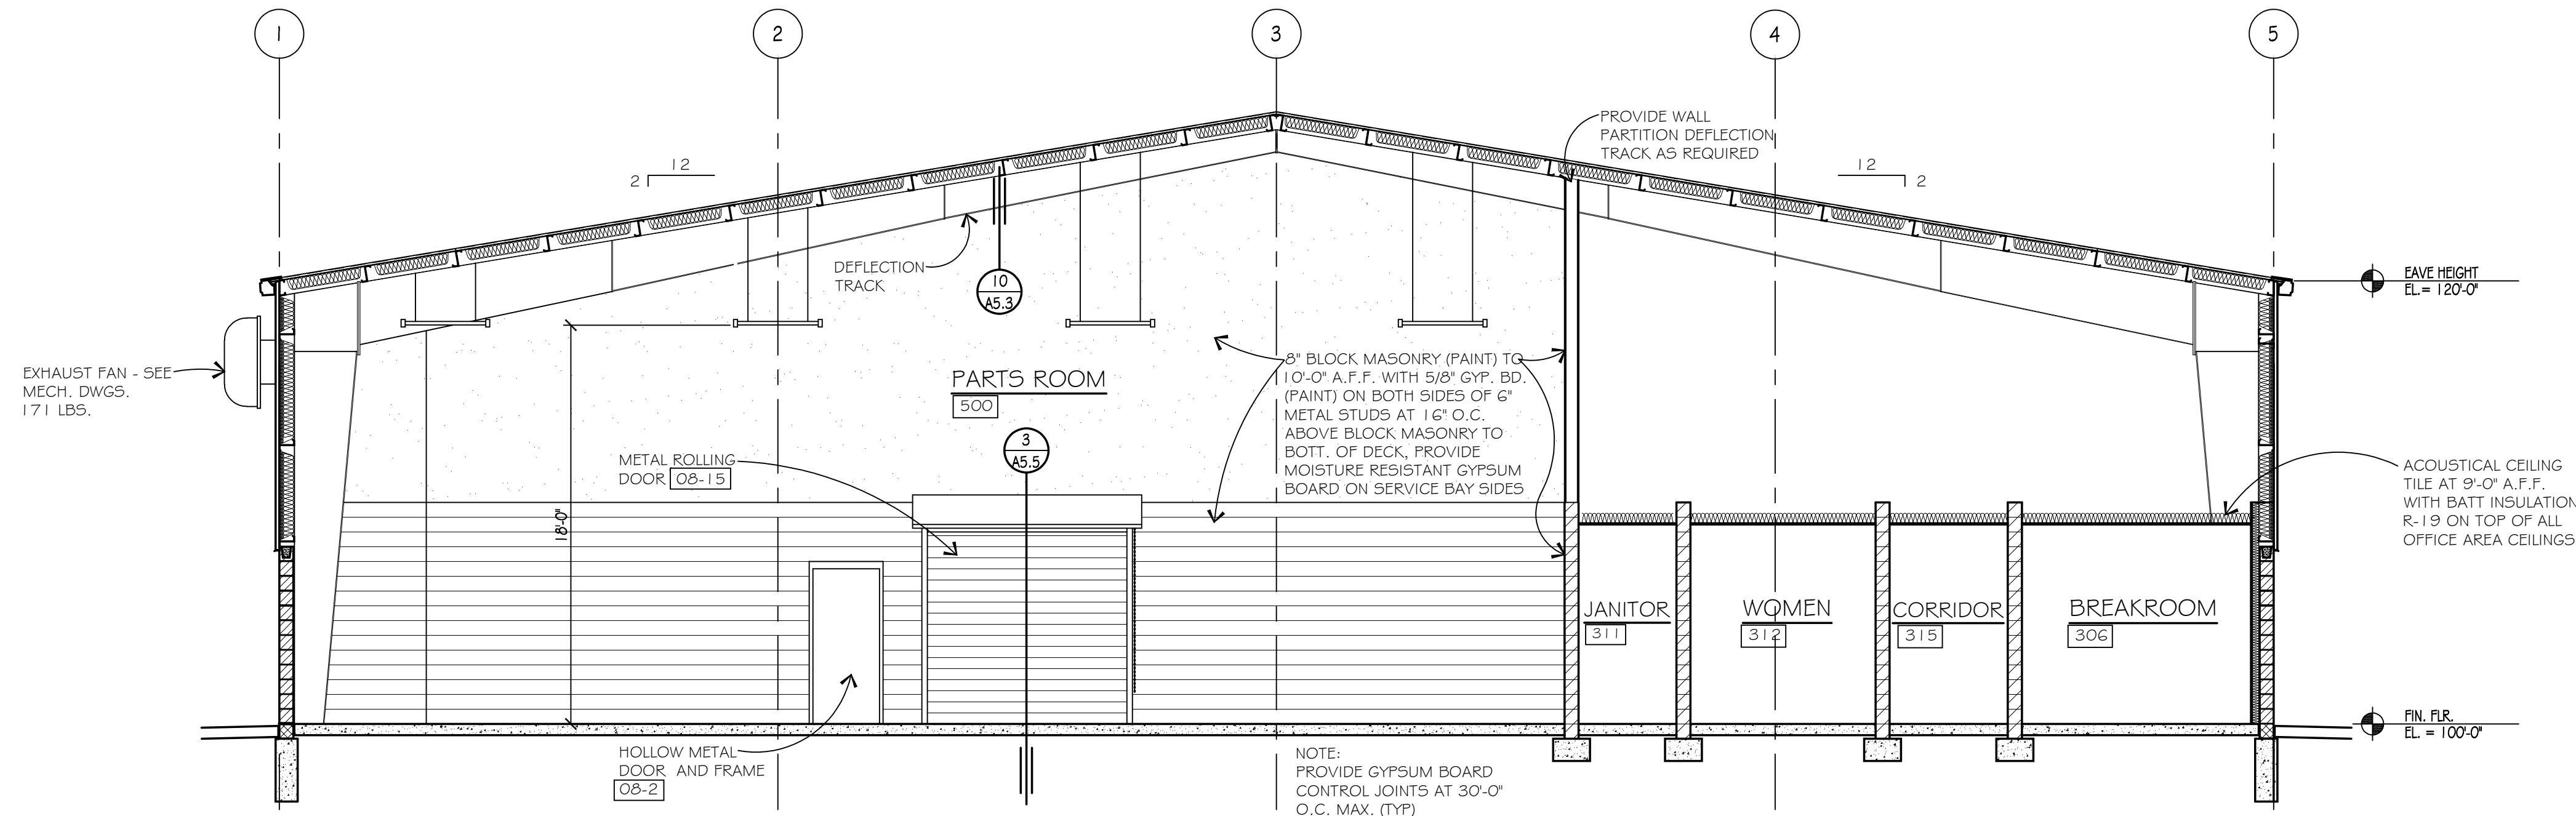


**MAINTENANCE BUILDING SECTION**  
SCALE: 3/16" = 1'-0"

**MAINTENANCE BUILDING - EXTERIOR FINISH SCHEDULE**


**PREFINISHED METAL PANELS:**  
ROOF: COLOR "POLAR WHITE"  
NOTE: STANDING SEAM ROOF PANELS, 24 GA.  
WALLS: COLOR "POLAR WHITE"  
NOTE: WALL PANELS SHALL BE 26 GA. WITH EXPOSED FASTENERS.  
**DOORS AND WINDOWS:**  
SECTIONAL OVERHEAD DOORS: STANDARD WHITE  
HOLLOW METAL DOORS AND FRAMES: PAINT TO MATCH METAL SIDING "POLAR WHITE"  
ALUMINUM FRAME GLASS WINDOWS: 1" INSULATED TINTED GLASS WITH DARK BRONZE ANODIZED ALUMINUM FRAME.  
**GUTTERS AND DOWNSPOUTS:**  
REFINISHED "POLAR WHITE".  
**BOLLARDS:**  
FRIMED AND PAINTED "SAFETY YELLOW"  
**UTILITY CONDUITS AND PIPING:**  
PAINT TO MATCH ADJACENT MATERIAL COLOR.

**NOTES:**  
1. SEE SPECIFICATIONS FOR ADDITIONAL INFORMATION ON PRODUCTS AND MANUFACTURERS.  
2. VERIFY ALL FINISH COLORS WITH OWNER.  
3. SUBMIT COLOR SAMPLES FOR ALL FINISH MATERIAL LISTED FOR REVIEW AND APPROVAL PRIOR TO PURCHASING AND INSTALLATION OF FINISH MATERIALS.


**NOTE:**  
1. MECHANICAL AND ELECTRICAL TRADES SHALL PROVIDE ALL THE NECESSARY BLOCKING, METAL STUDS, P.R.T. PLYWOOD BACKING, UNISTRUT, ETC. AS REQUIRED TO MOUNT ALL THEIR EQUIPMENT, INCLUDING LIGHTING TO THE EXTERIOR METAL SIDING BUILDING WALL CONSTRUCTION AND METAL PANEL ROOF CONSTRUCTION, TYPICAL.  
2. GENERAL CONTRACTOR IS TO COORDINATE WITH THE LIGHTING FIXTURE VENDOR FOR THE METHOD REQUIRED TO MOUNT EXTERIOR LIGHTING FIXTURES TO FACE OF BUILDING.  
3. ALL EXTERIOR BUILDING PENETRATIONS SHALL BE SEALED WEATHERTIGHT.

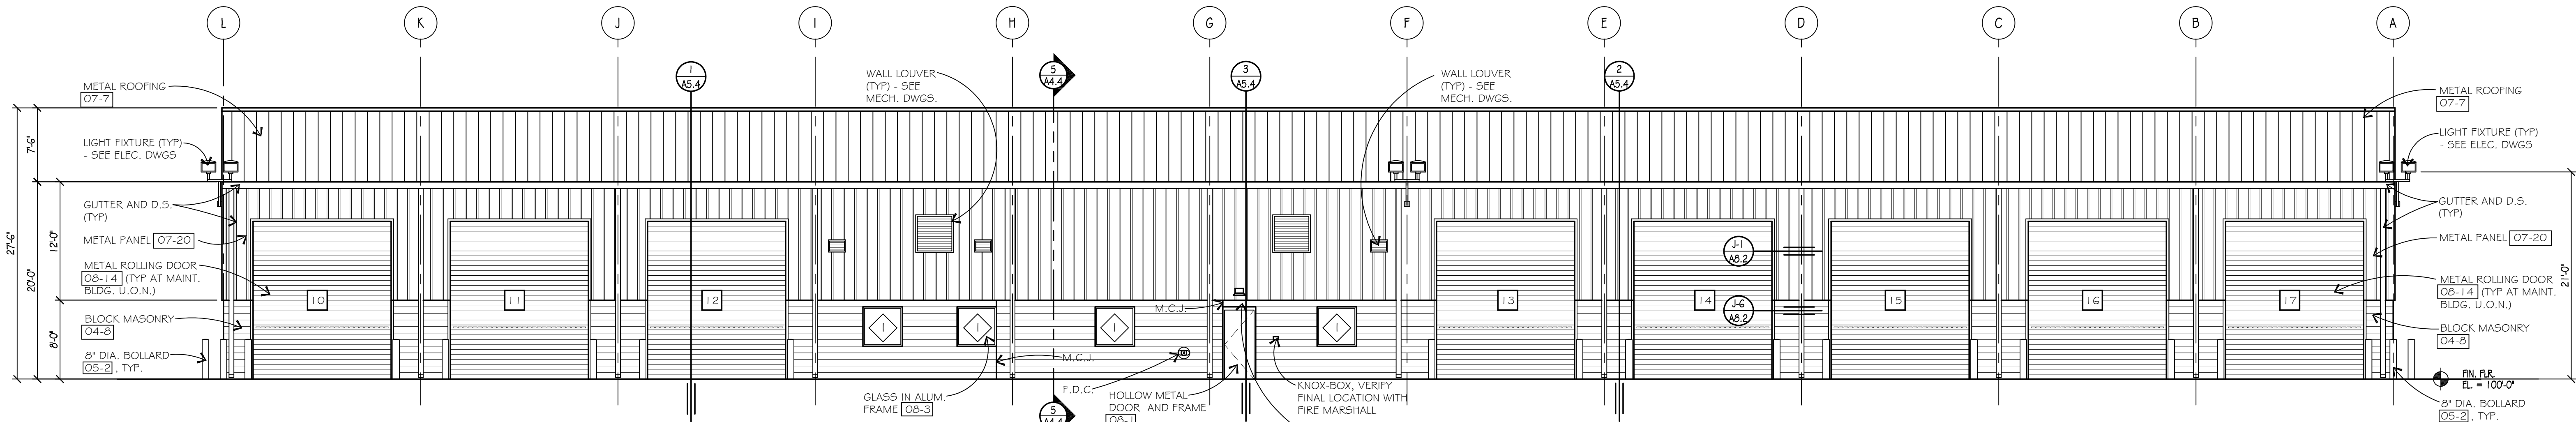


**MAINTENANCE BUILDING ELEVATION**  
SCALE: 1/8" = 1'-0"

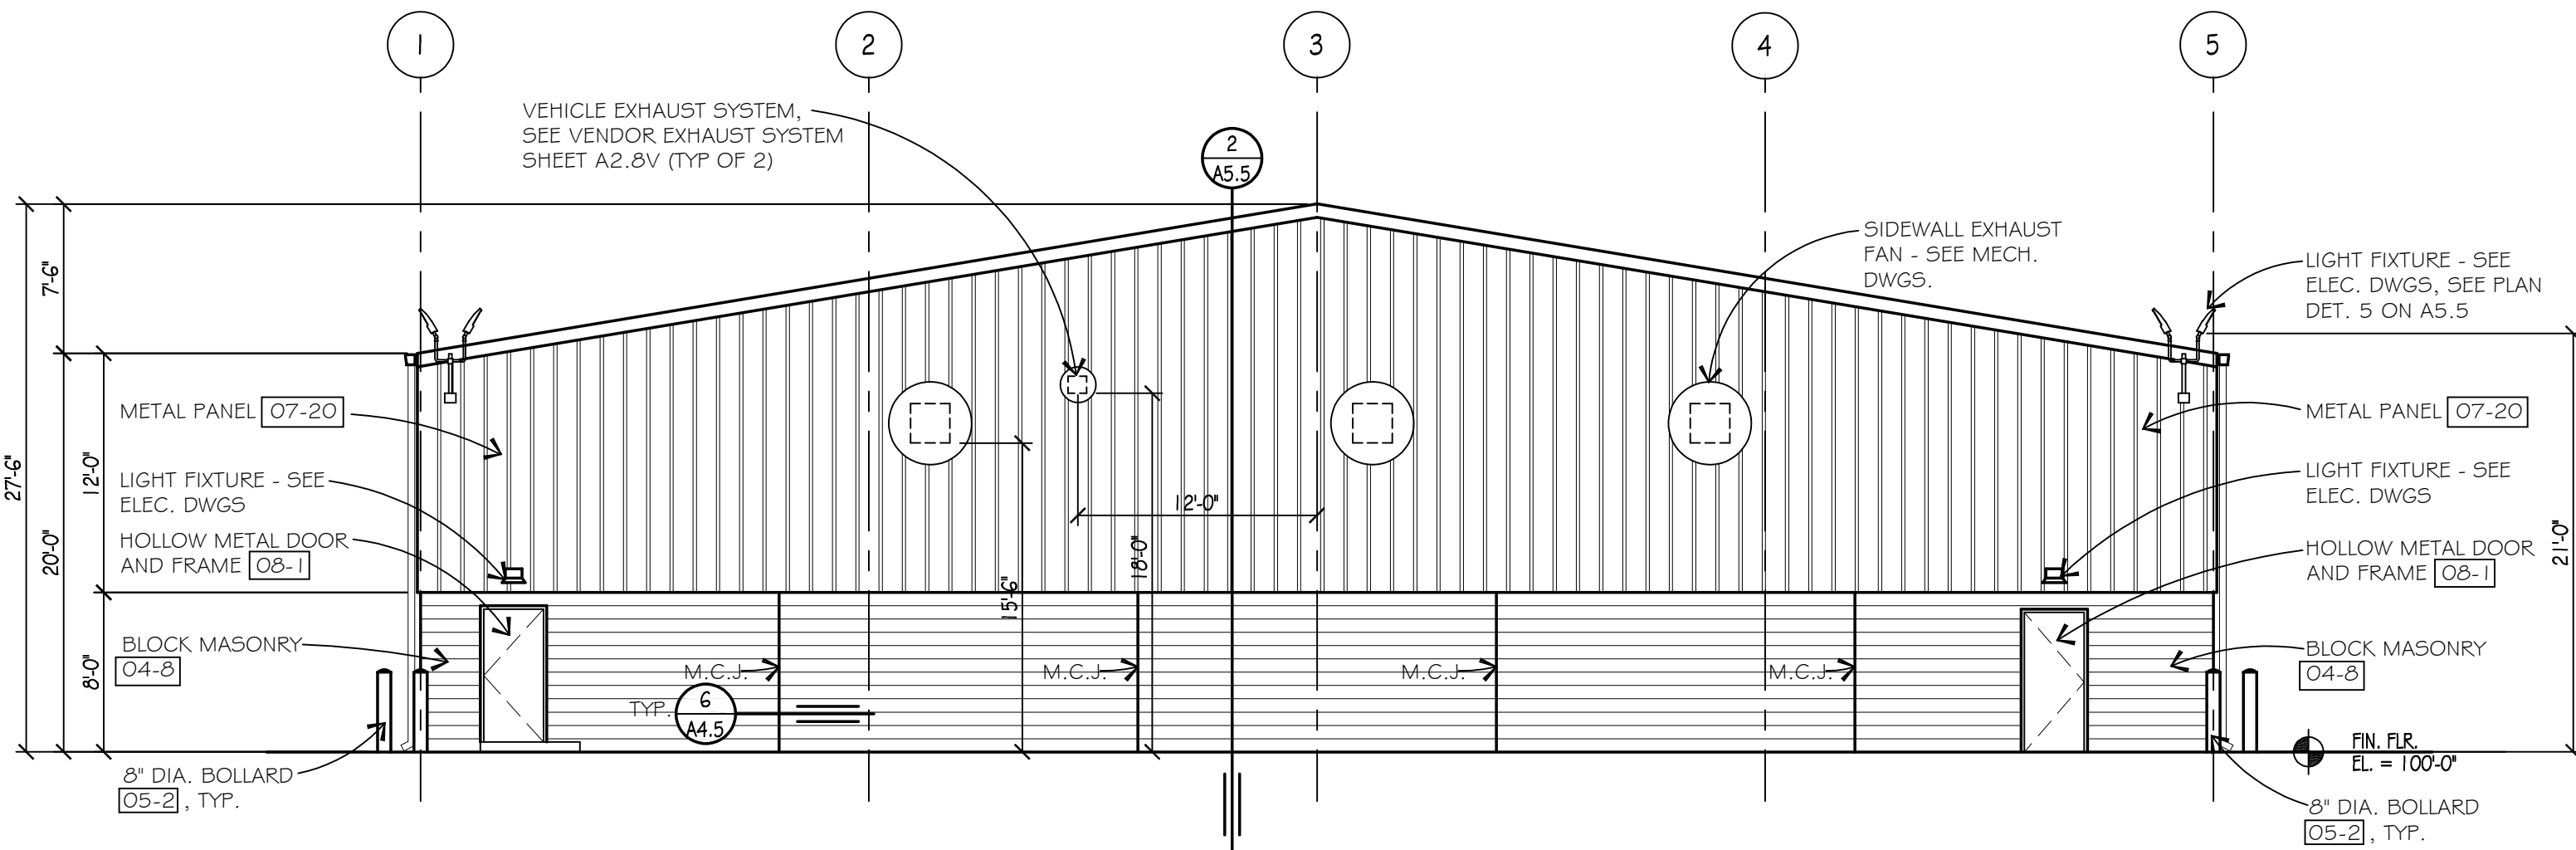


**MAINTENANCE BUILDING ELEVATION**  
SCALE: 1/8" = 1'-0"

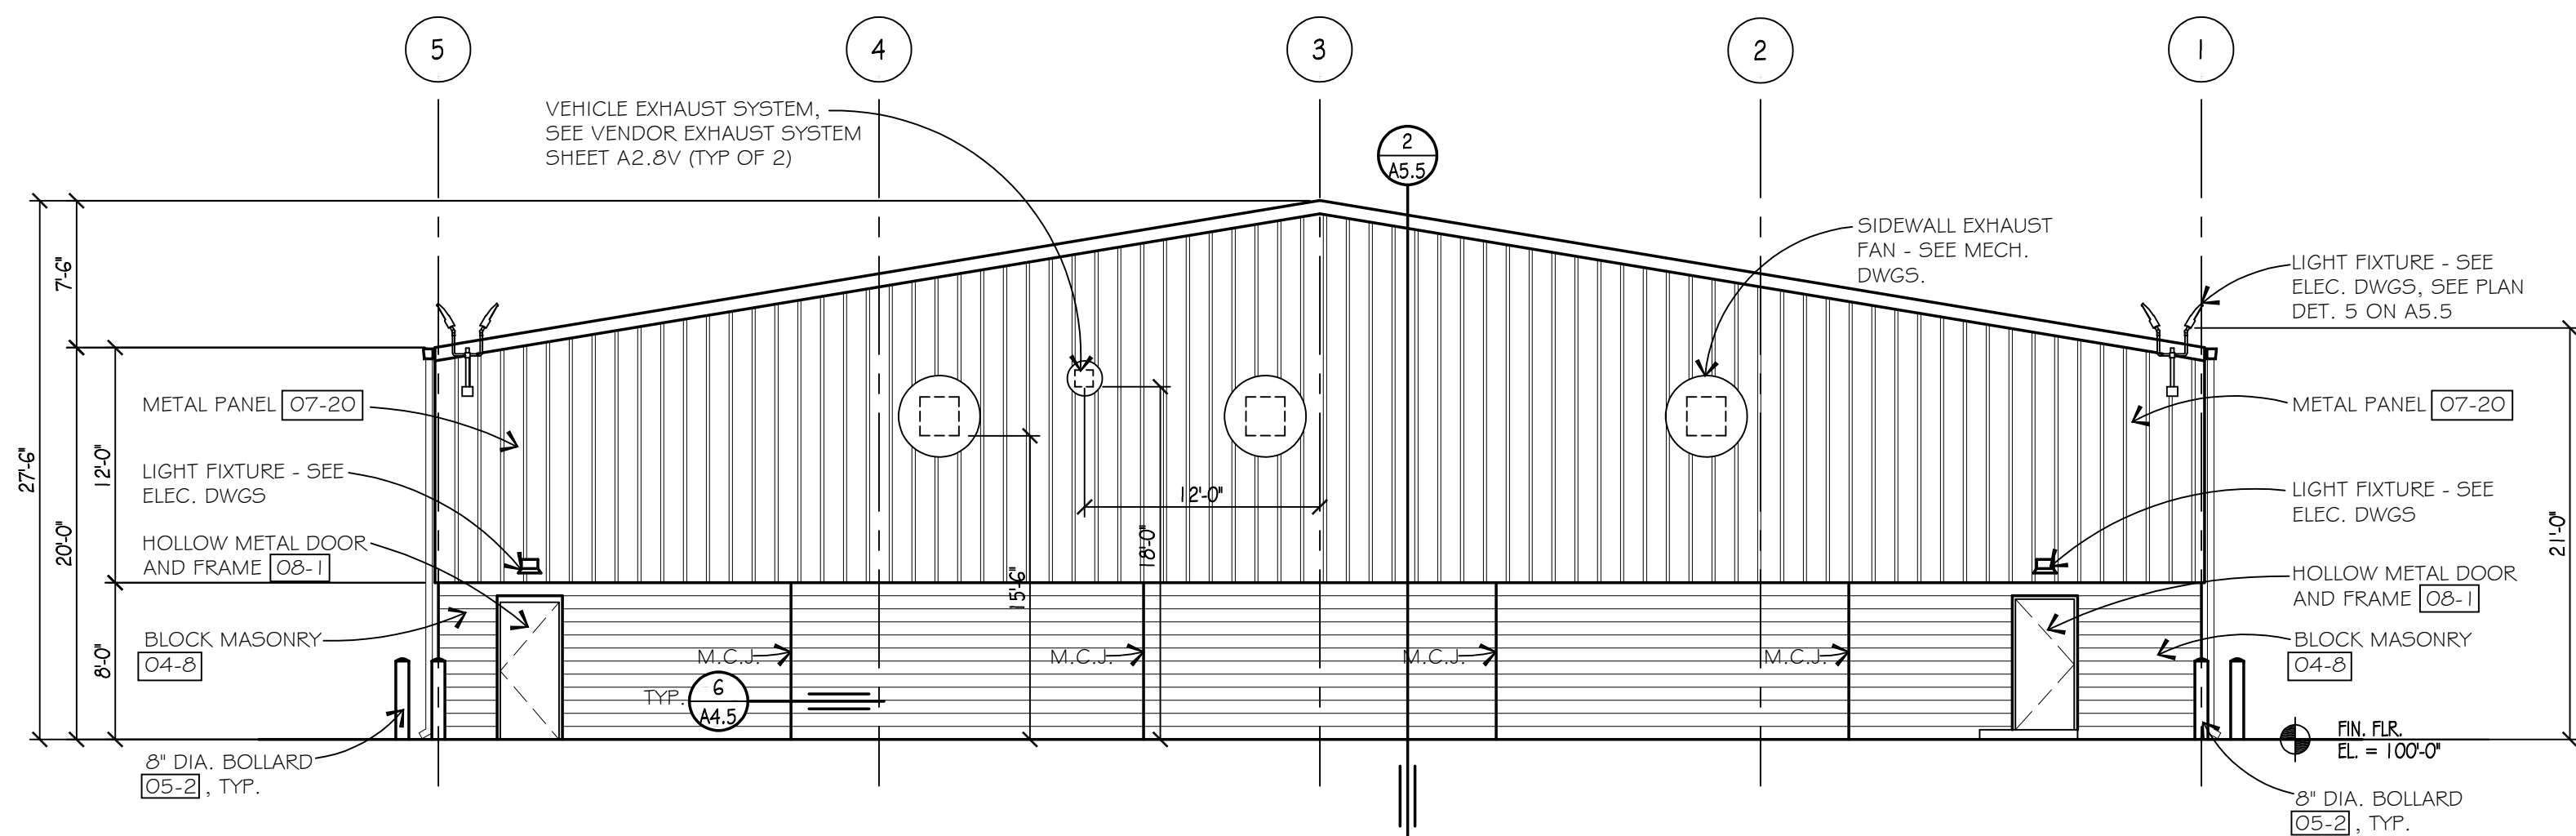


**MAINTENANCE BUILDING ELEVATION**  
SCALE: 1/8" = 1'-0"

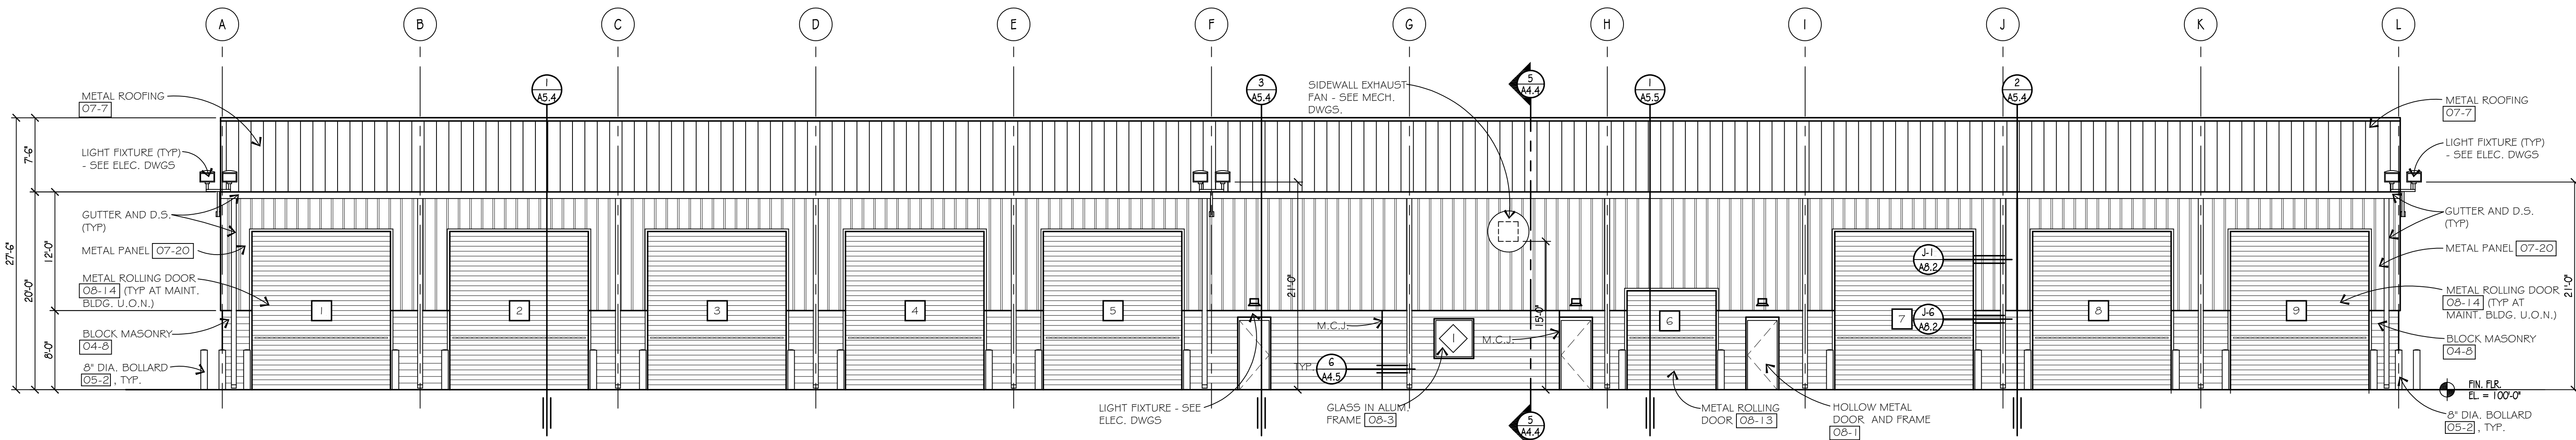


**MAINTENANCE BUILDING ELEVATION**  
SCALE: 1/8" = 1'-0"

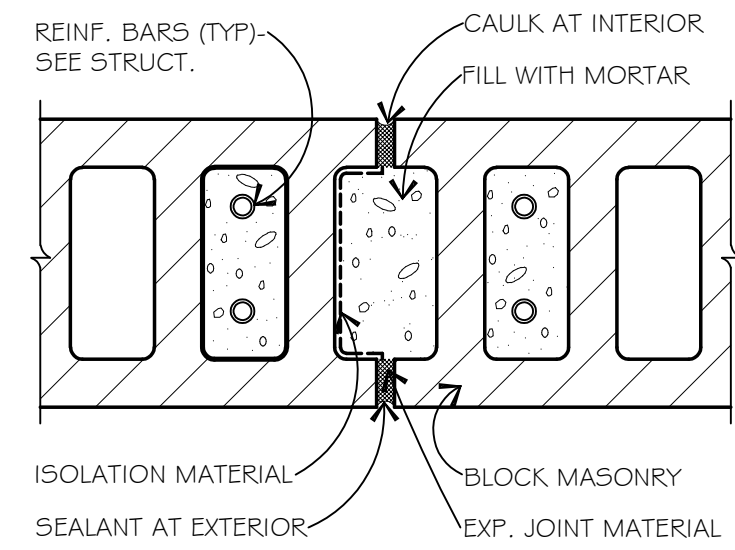

MASONRY CONTROL JT. DETAIL  
SCALE: 1-1/2" = 1'-0"

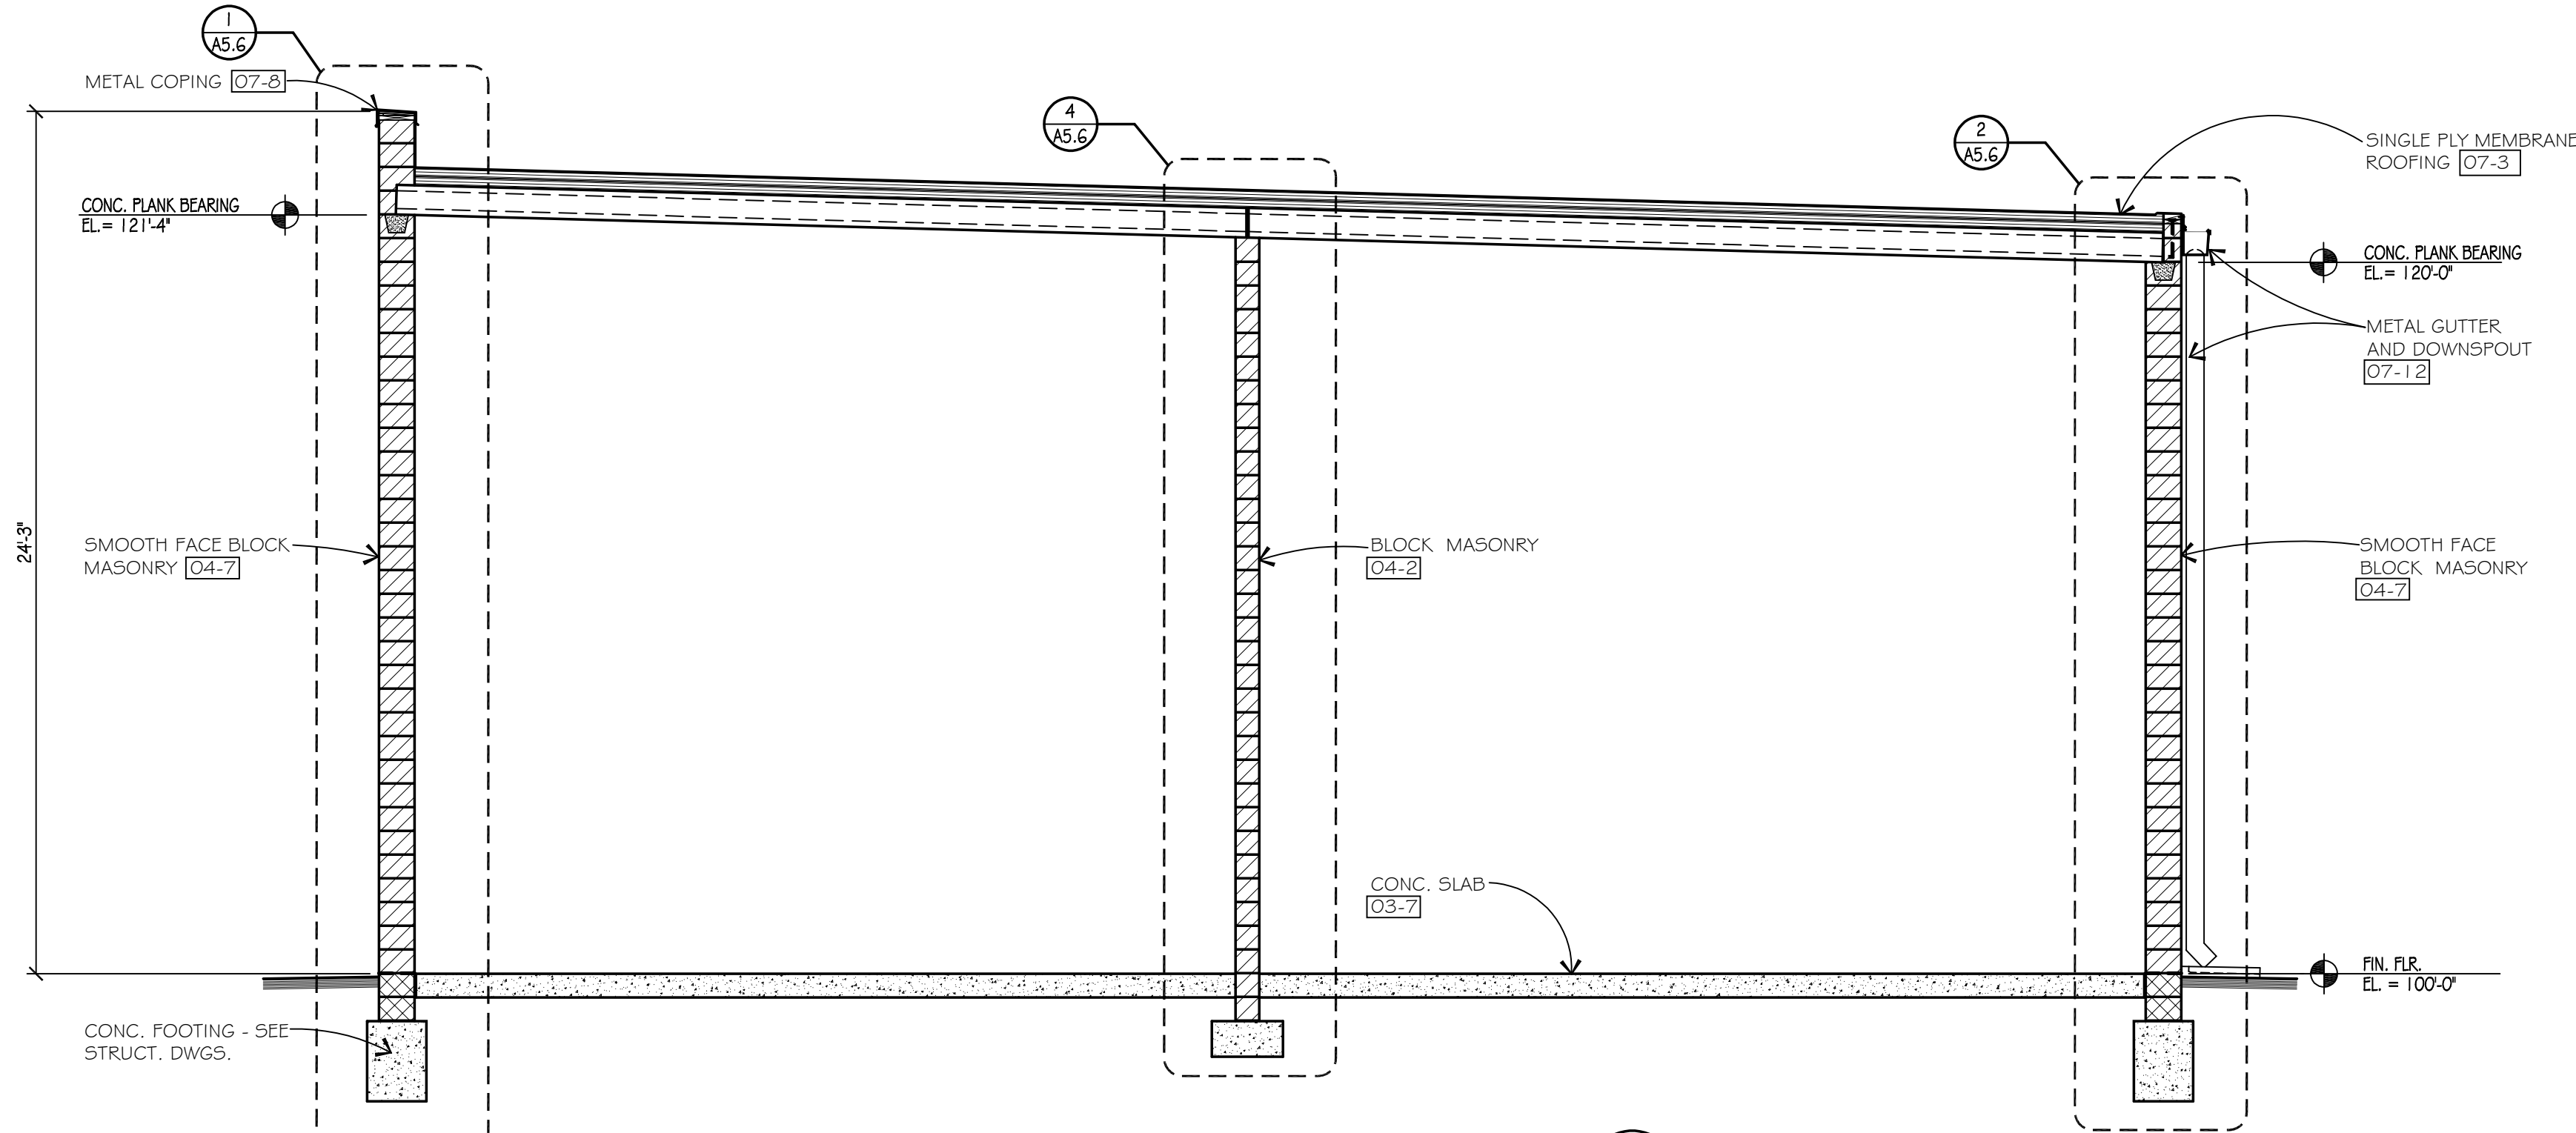


TRUCK WASH BUILDING SECTION  
SCALE: 1/4" = 1'-0"

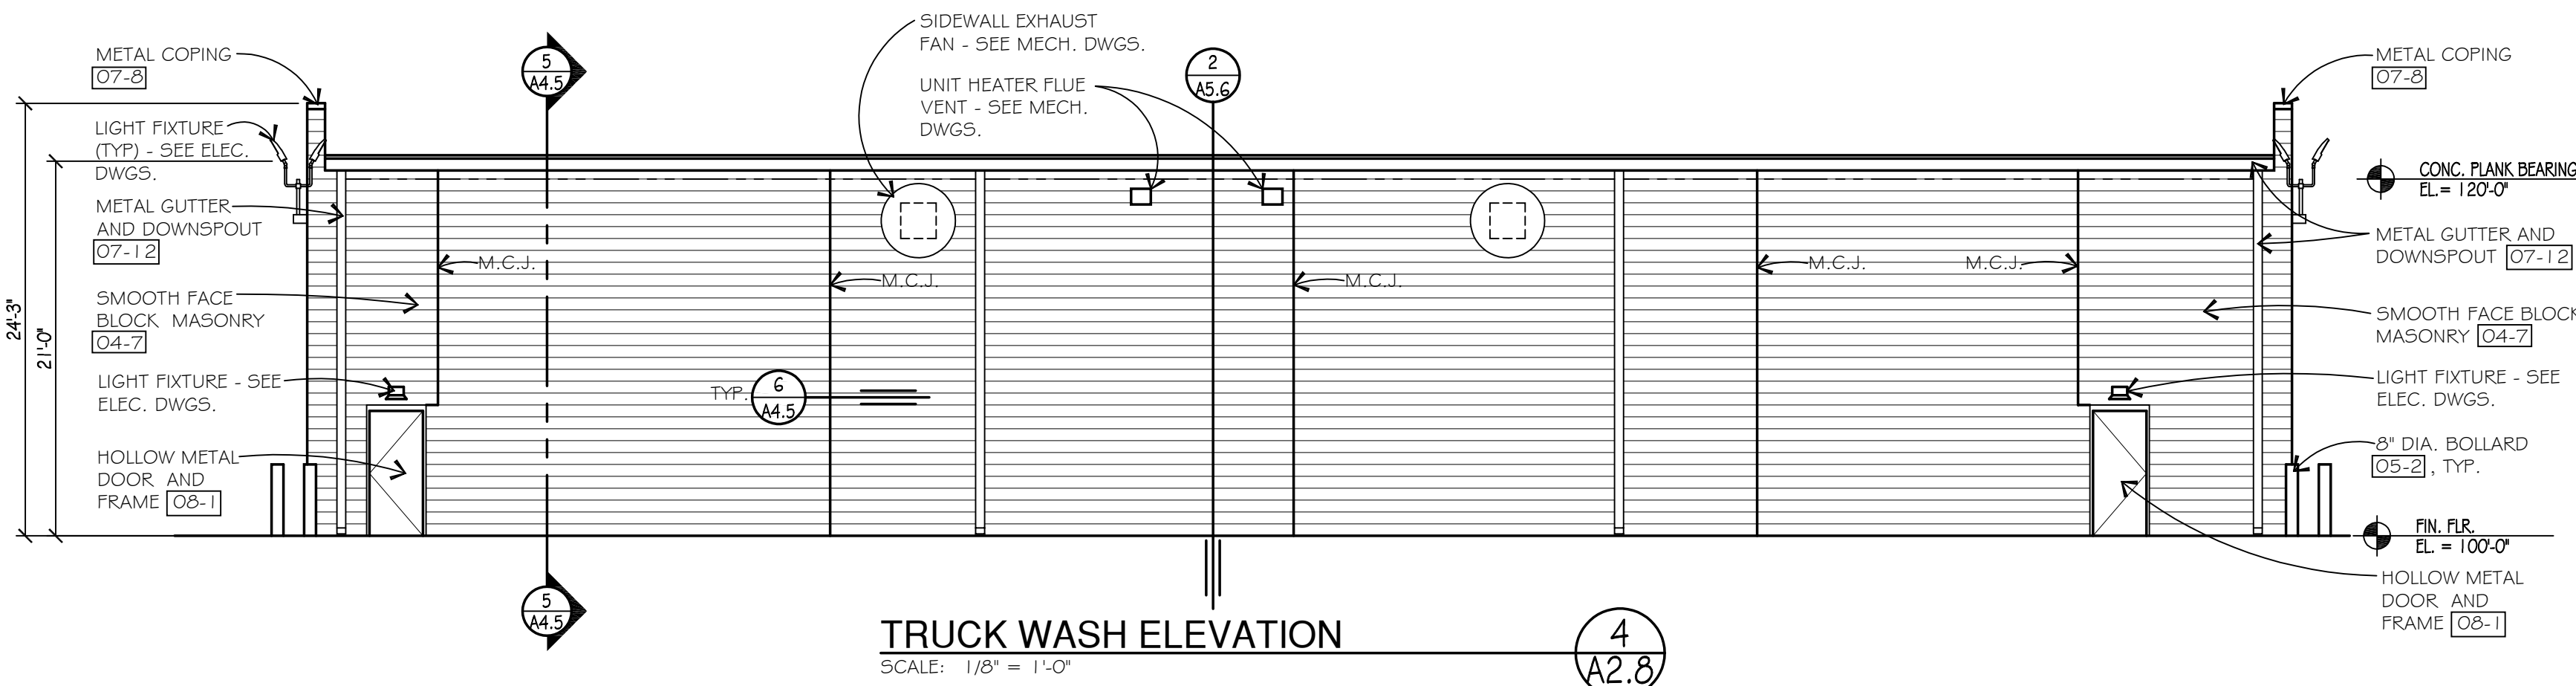


TRUCK WASH ELEVATION  
SCALE: 1/8" = 1'-0"

NOTE:  
1. MECHANICAL AND ELECTRICAL TRADES SHALL PROVIDE ALL THE NECESSARY BLOCKING, METAL STUDS, P.R.T. PLYWOOD BACKING, UNISTRUT, ETC. AS REQUIRED TO MOUNT ALL THEIR EQUIPMENT, INCLUDING LIGHTING TO THE EXTERIOR METAL SIDING BUILDING WALL CONSTRUCTION AND METAL PANEL ROOF CONSTRUCTION, TYPICAL.  
2. GENERAL CONTRACTOR IS TO COORDINATE WITH THE LIGHTING FIXTURE VENDOR FOR THE METHOD REQUIRED TO MOUNT EXTERIOR LIGHTING FIXTURES TO FACE OF BUILDING.  
3. ALL EXTERIOR BUILDING PENETRATIONS SHALL BE SEALED WEATHERTIGHT.

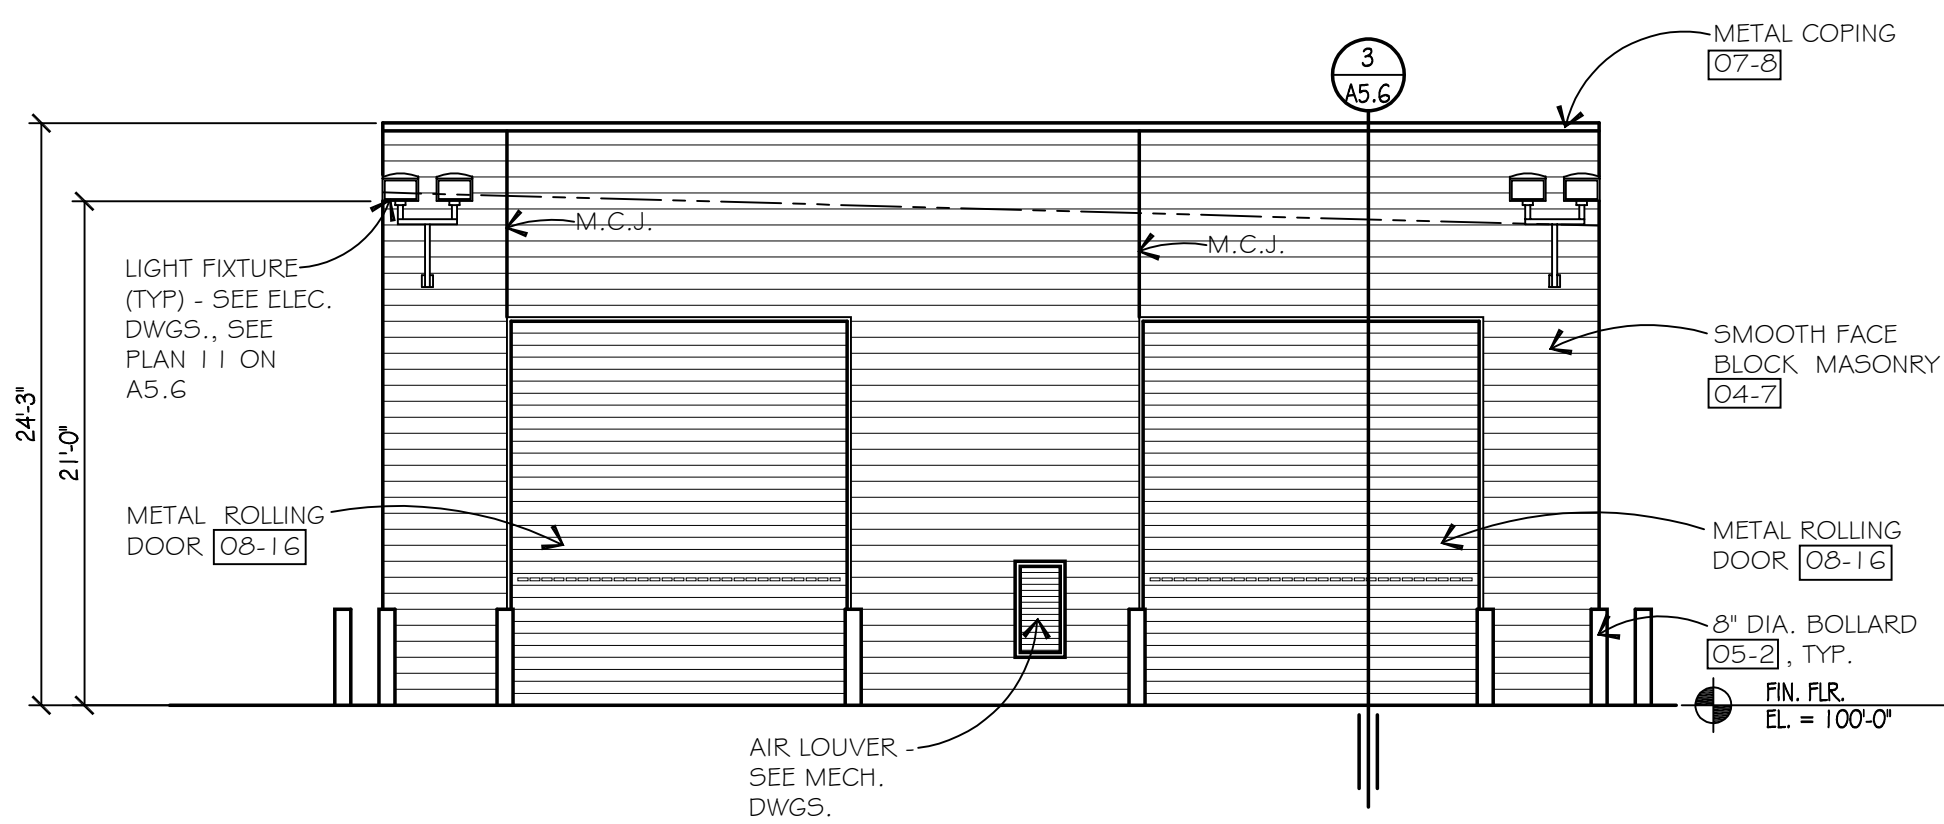


TRUCK WASH ELEVATION  
SCALE: 1/8" = 1'-0"

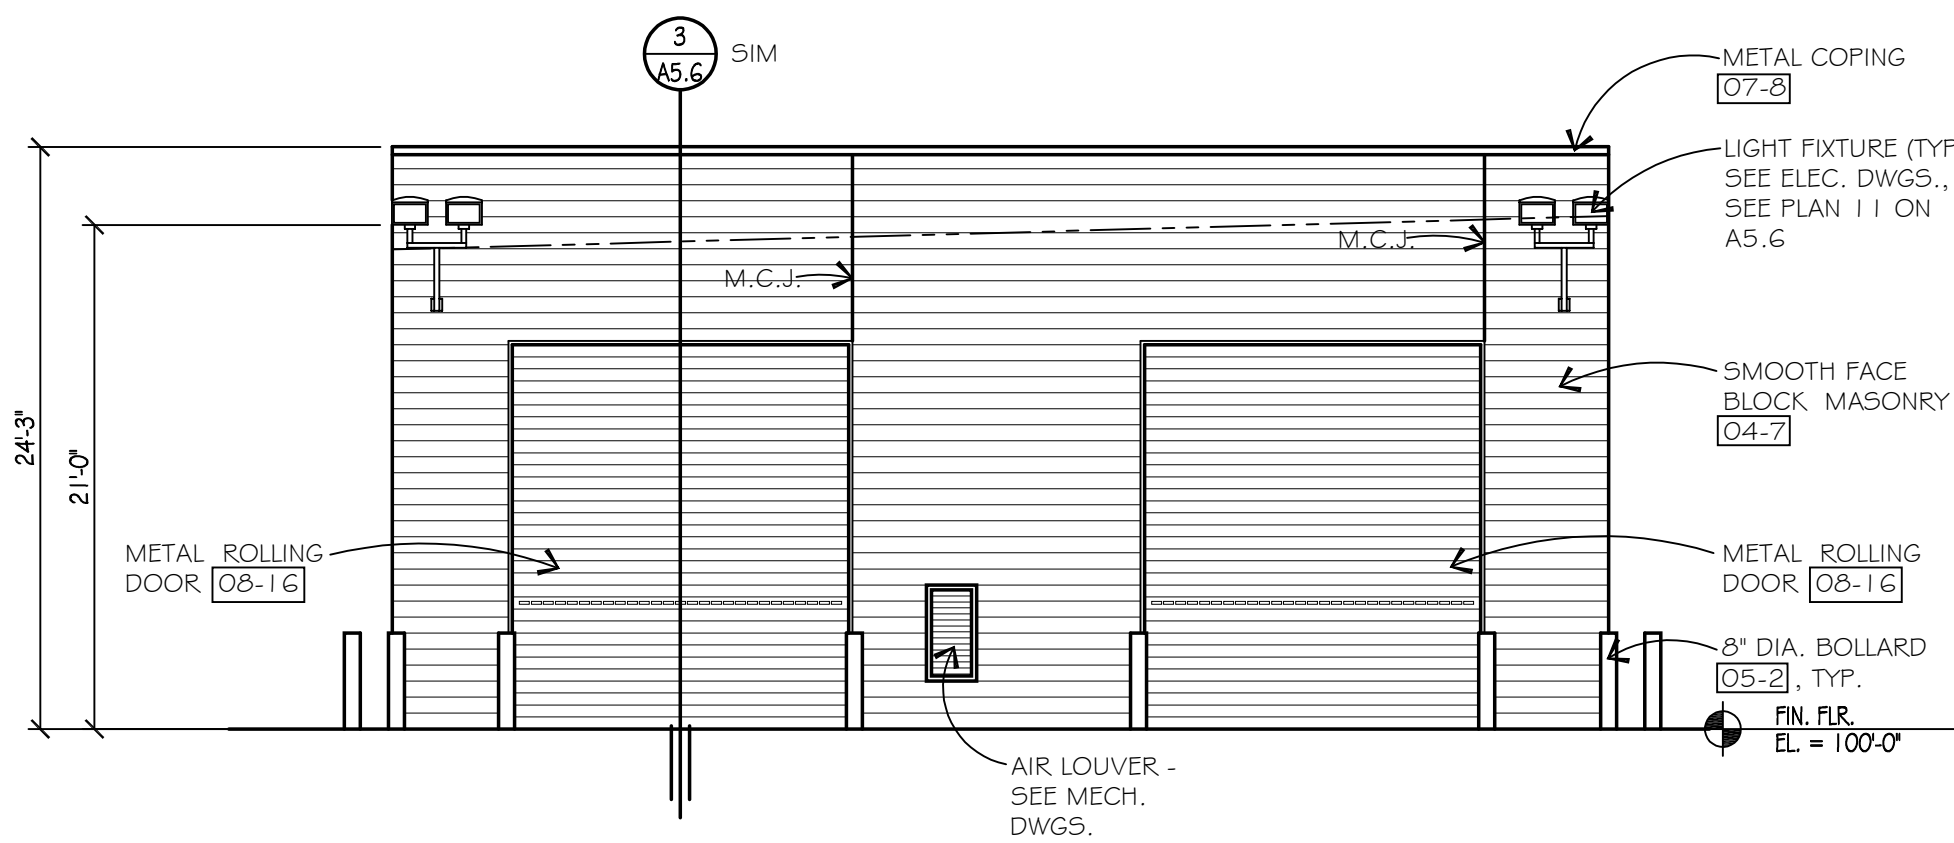


TRUCK WASH ELEVATION  
SCALE: 1/8" = 1'-0"

TRUCK WASH - EXTERIOR FINISH SCHEDULE
SMOOTH FACE BLOCK MASONRY: INTEGRALLY COLORED SMOOTH FACE BLOCK MASONRY: GRAND BLANC CEMENT PRODUCTS - COLOR WHITE COLORED MORTAR: GLEN-GERY COLOR G-501
DOORS: ROLLING OVERHEAD DOORS: STANDARD WHITE HOLLOW METAL DOORS AND FRAMES: PAINT TO MATCH "POLAR WHITE"
GUTTERS AND DOWNSPOUTS: PREFINISHED "POLAR WHITE"
BOLLARDS: PRIMED AND PAINTED "SAFETY YELLOW"
UTILITY CONDUITS AND PIPING: PAINT TO MATCH ADJACENT MATERIAL COLOR.
NOTES: 1. SEE SPECIFICATIONS FOR ADDITIONAL INFORMATION ON PRODUCTS AND MANUFACTURERS. 2. VERIFY ALL FINISH COLORS WITH OWNER. 3. SUBMIT COLOR SAMPLES FOR ALL FINISH MATERIAL LISTED FOR REVIEW AND APPROVAL PRIOR TO PURCHASING AND INSTALLATION OF FINISH MATERIALS.

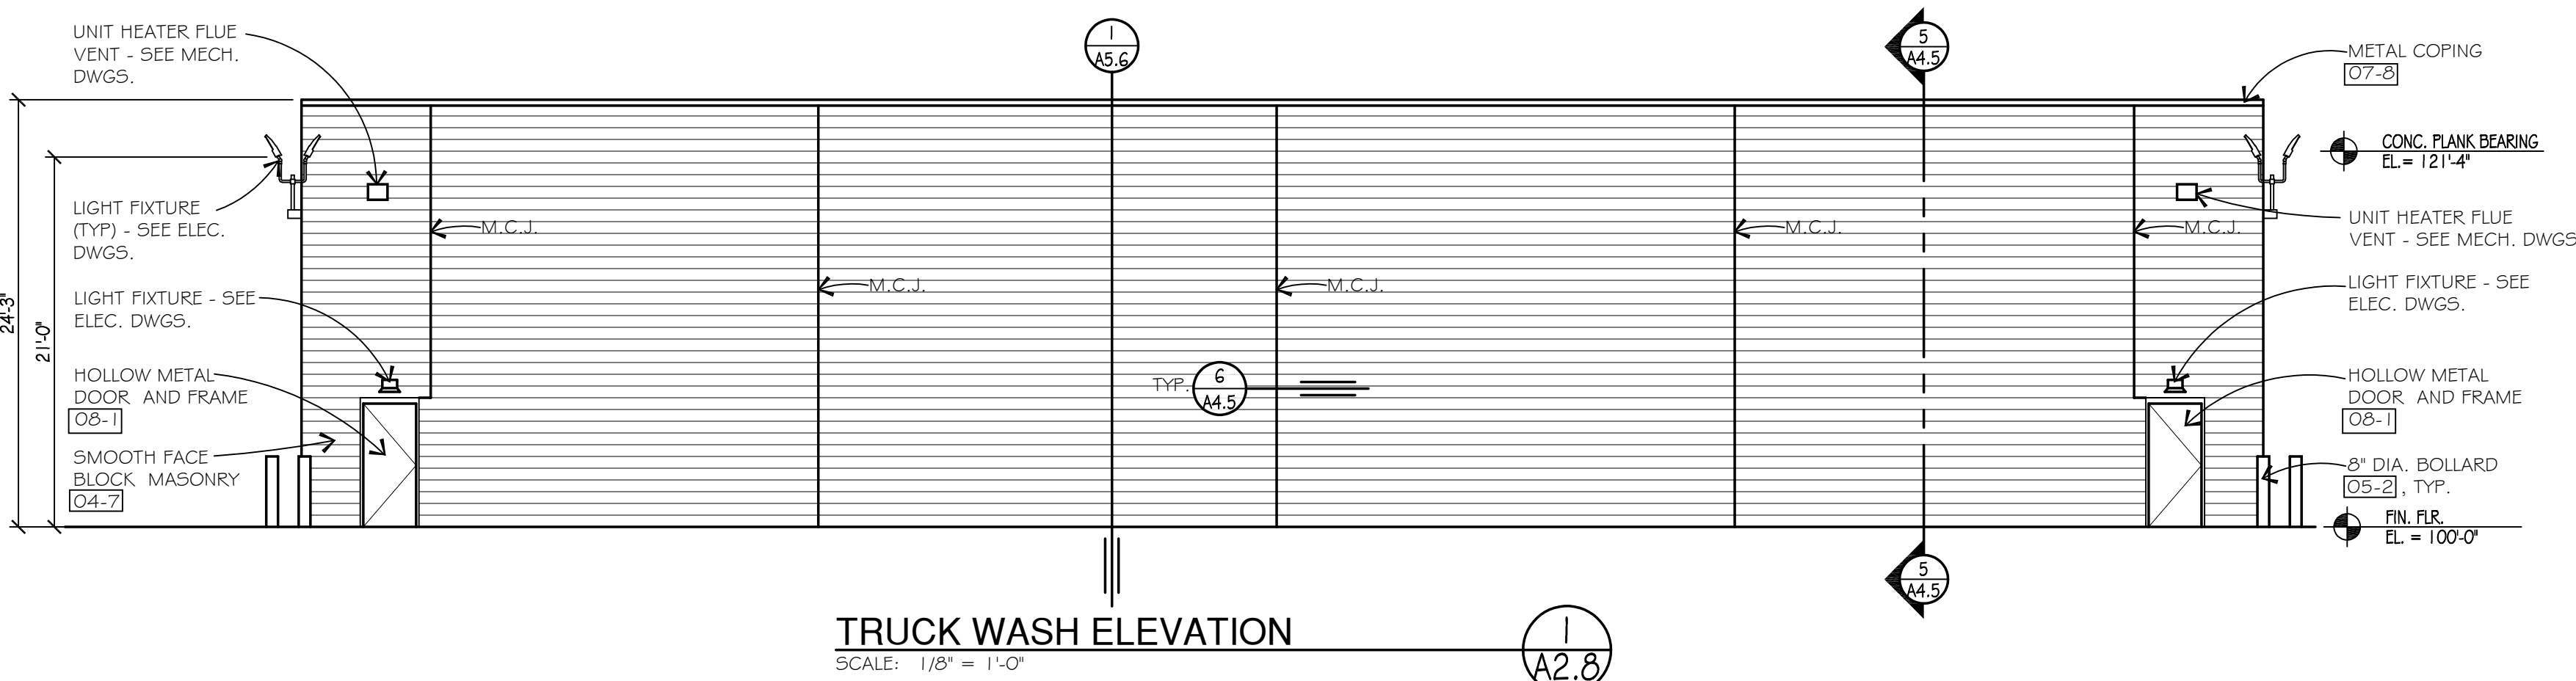


TRUCK WASH ELEVATION  
SCALE: 1/8" = 1'-0"




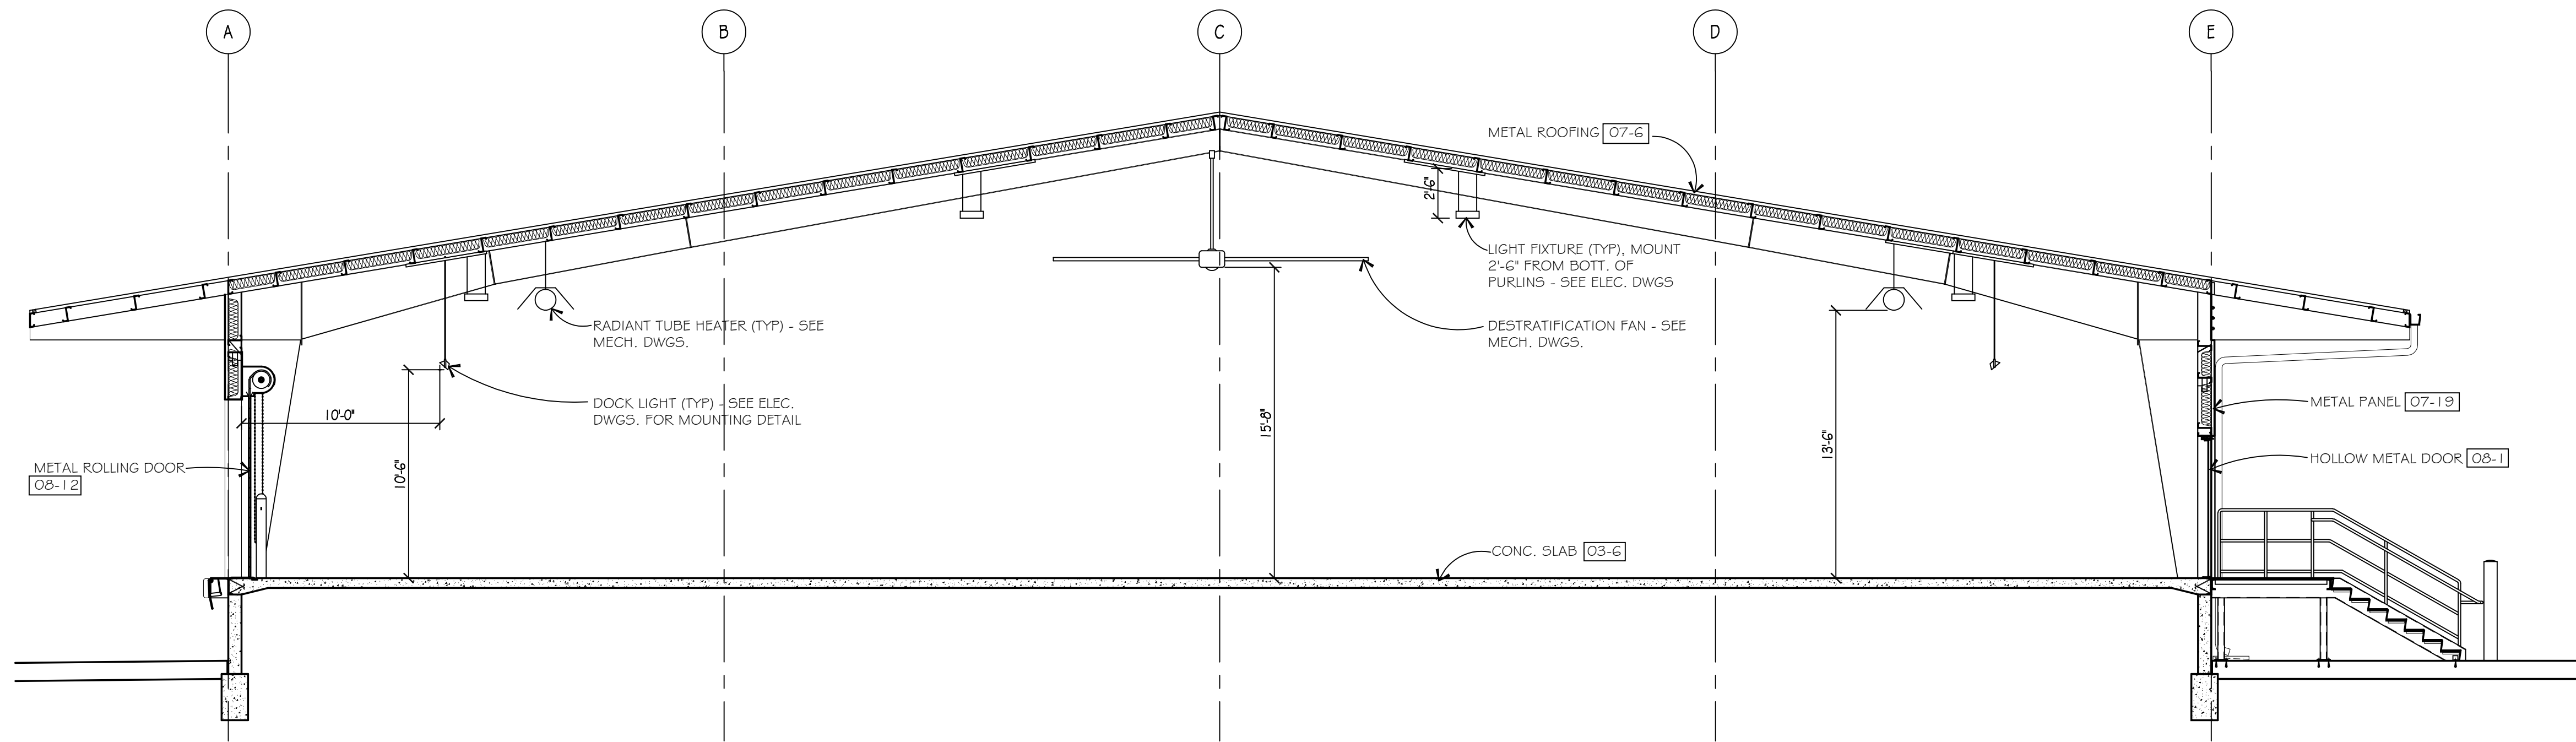


**BUILDING SECTION TERMINAL 200**  
SCALE: 3/16"=1'-0"

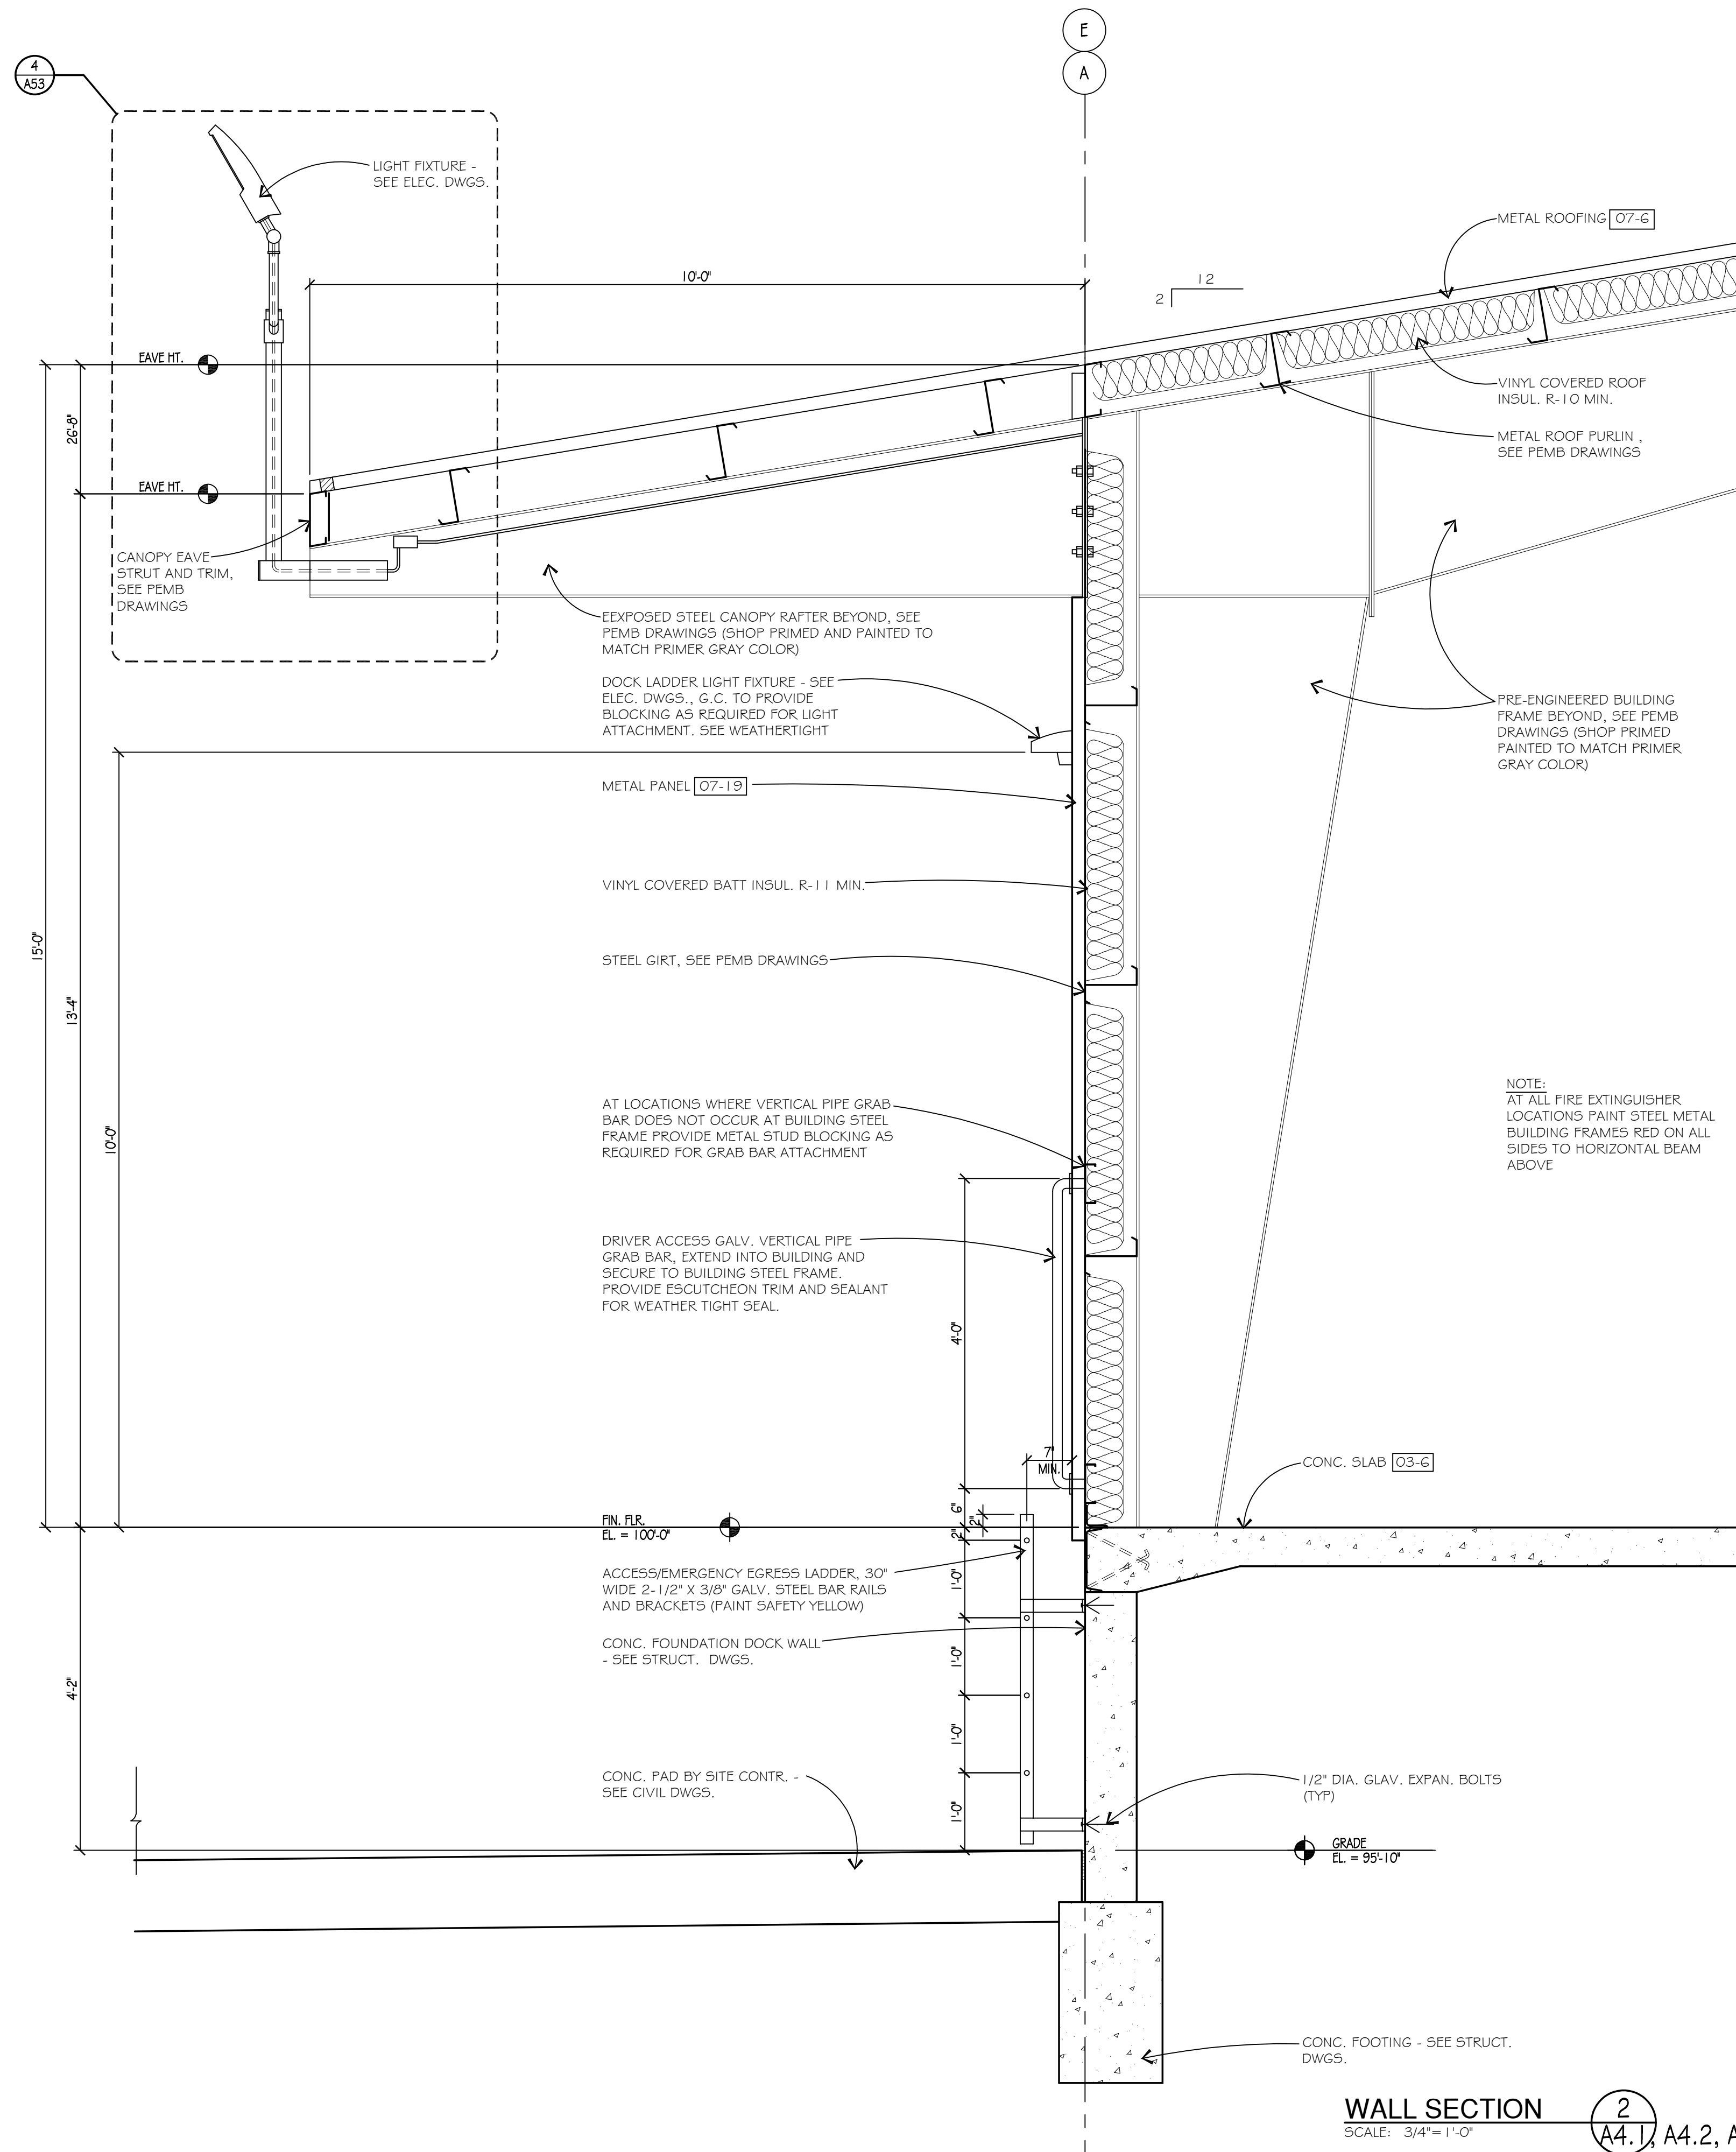


**WALL SECTION**  
SCALE: 3/4"=1'-0"

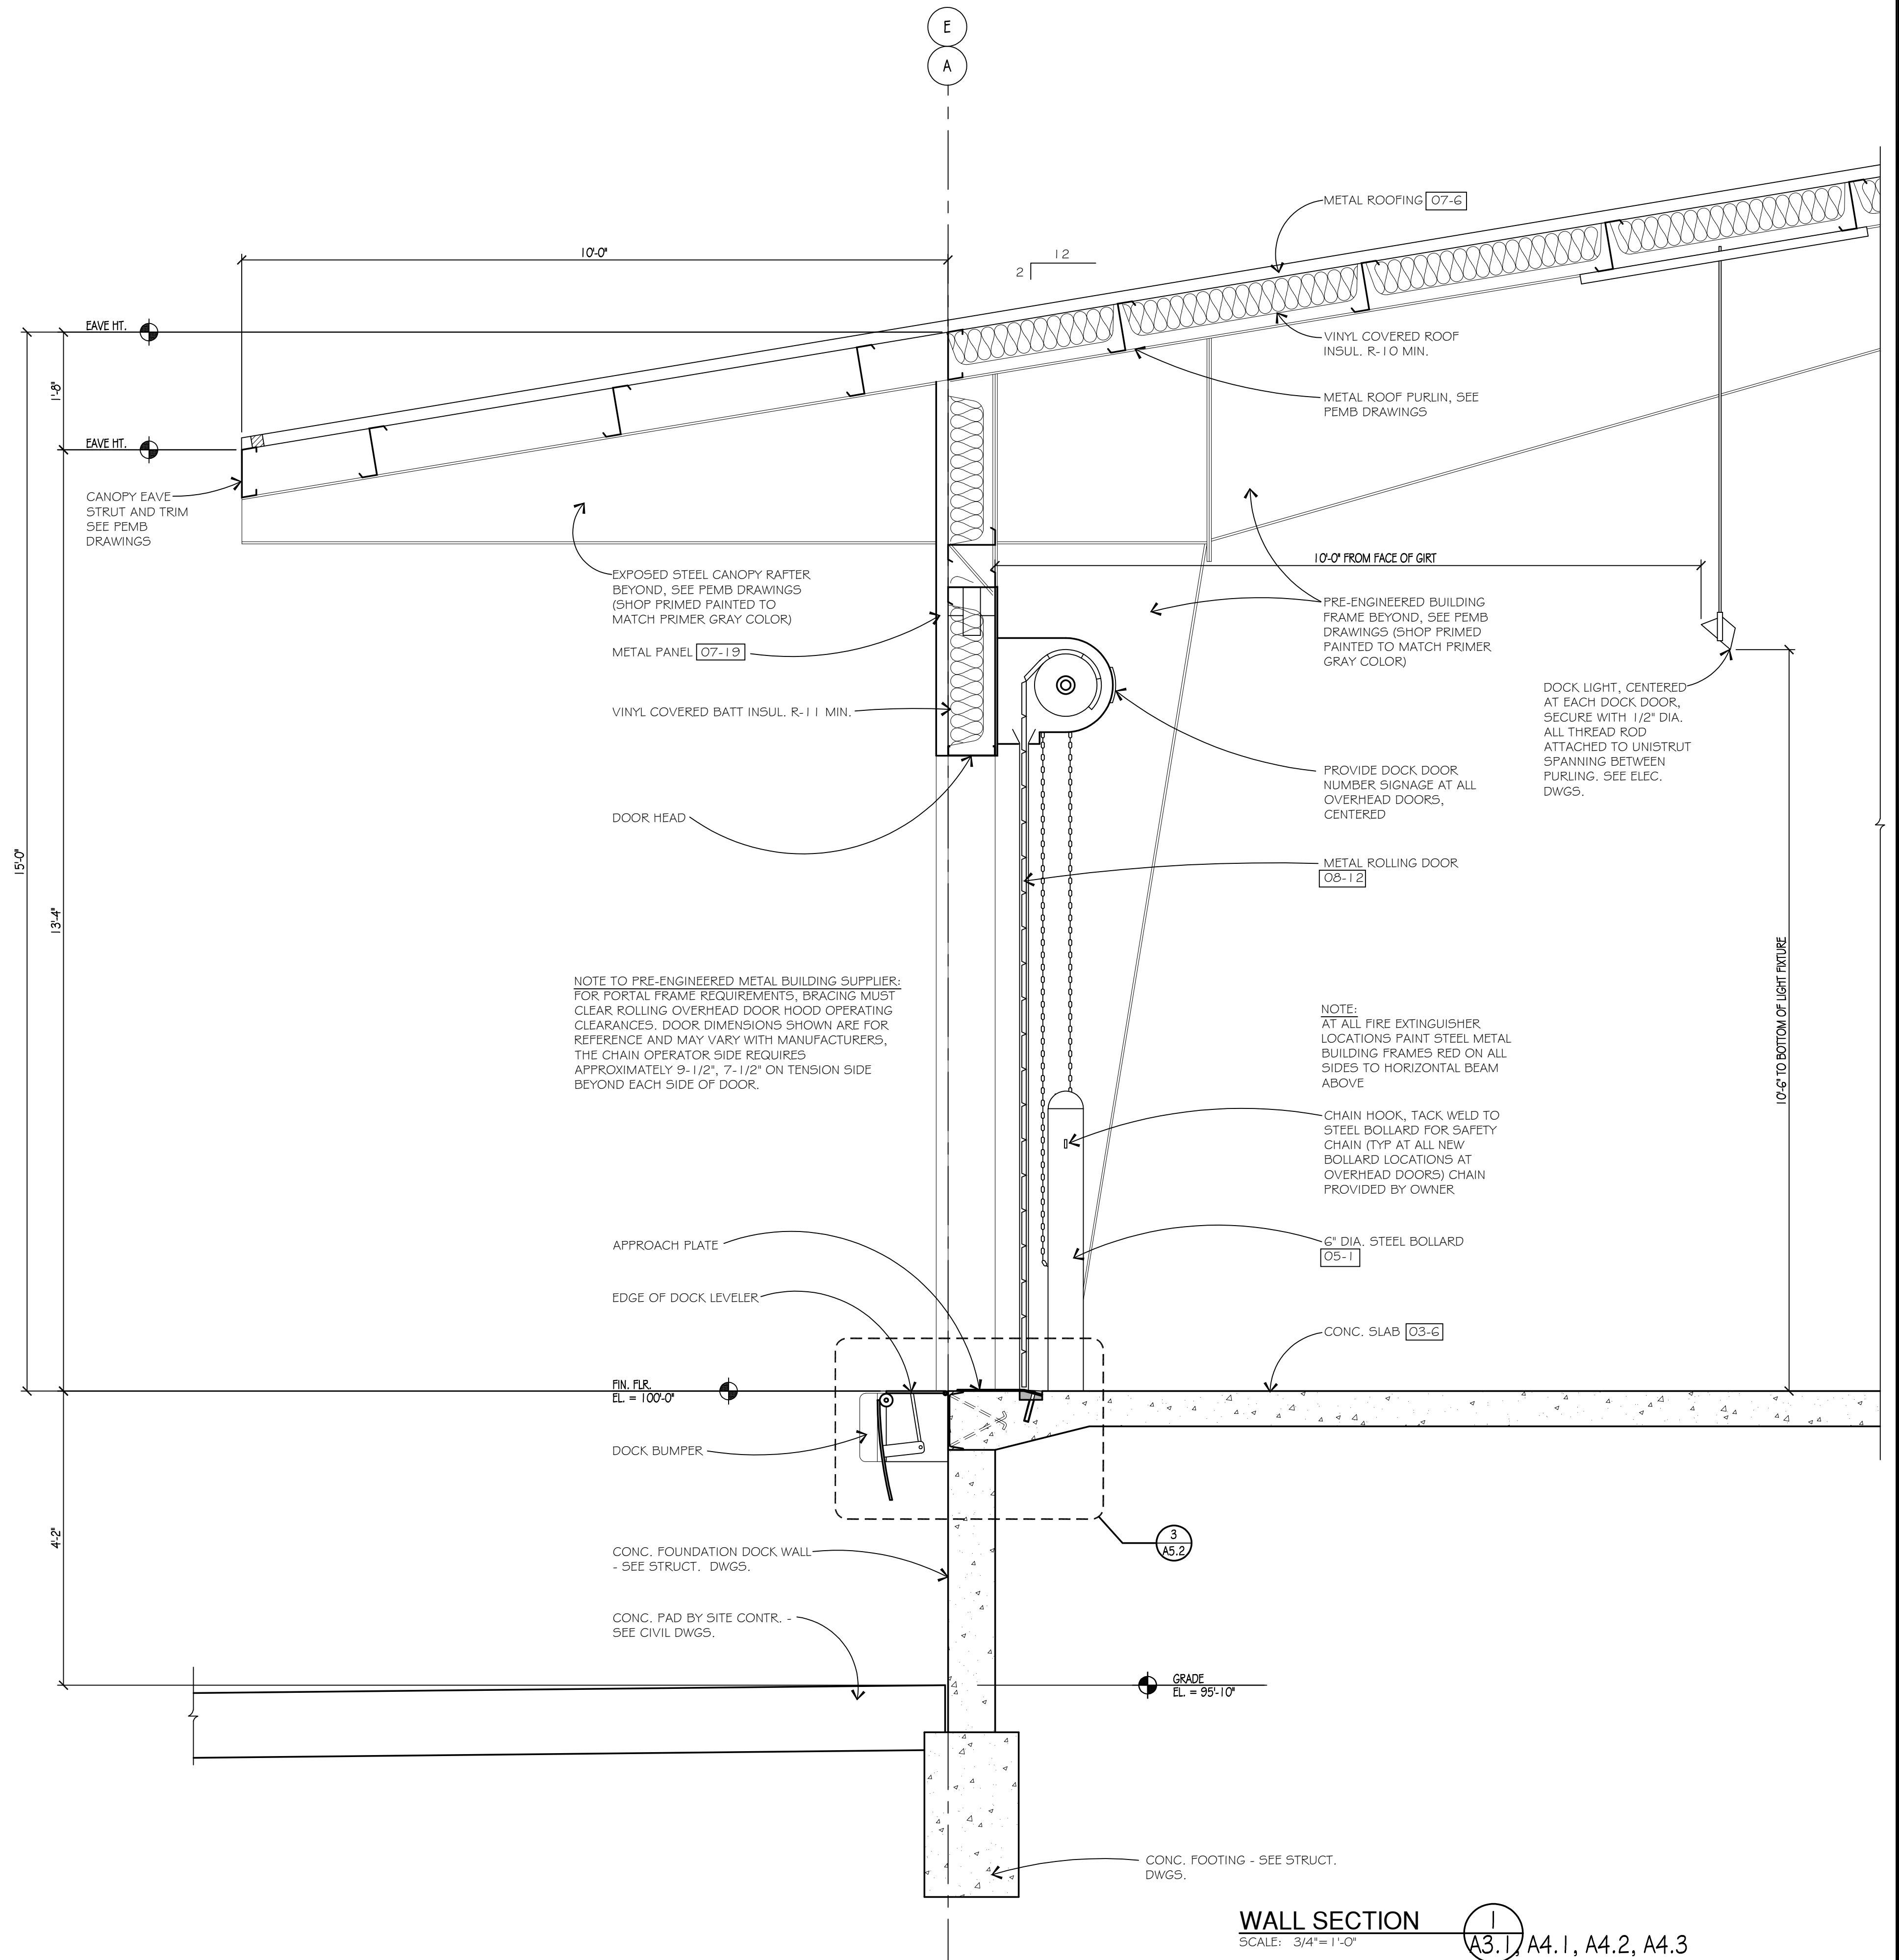


**WALL SECTION**  
SCALE: 3/4"=1'-0"

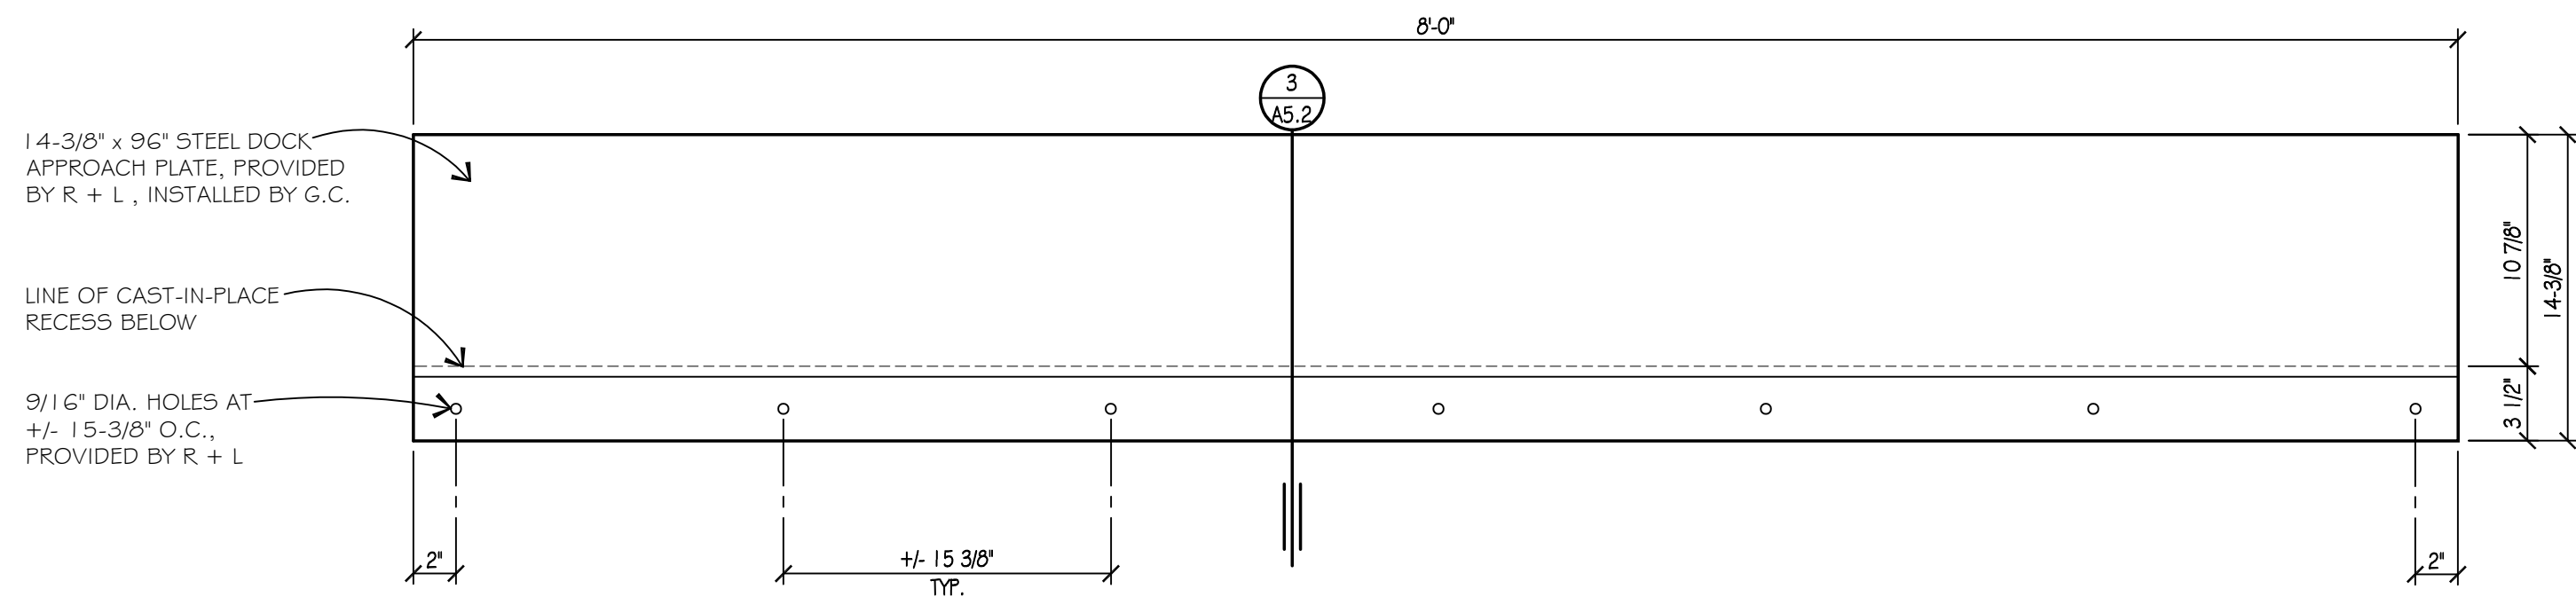


DOCK APPROACH PLATE PLAN (4)  
SCALE: 1-1/2"=1'-0"

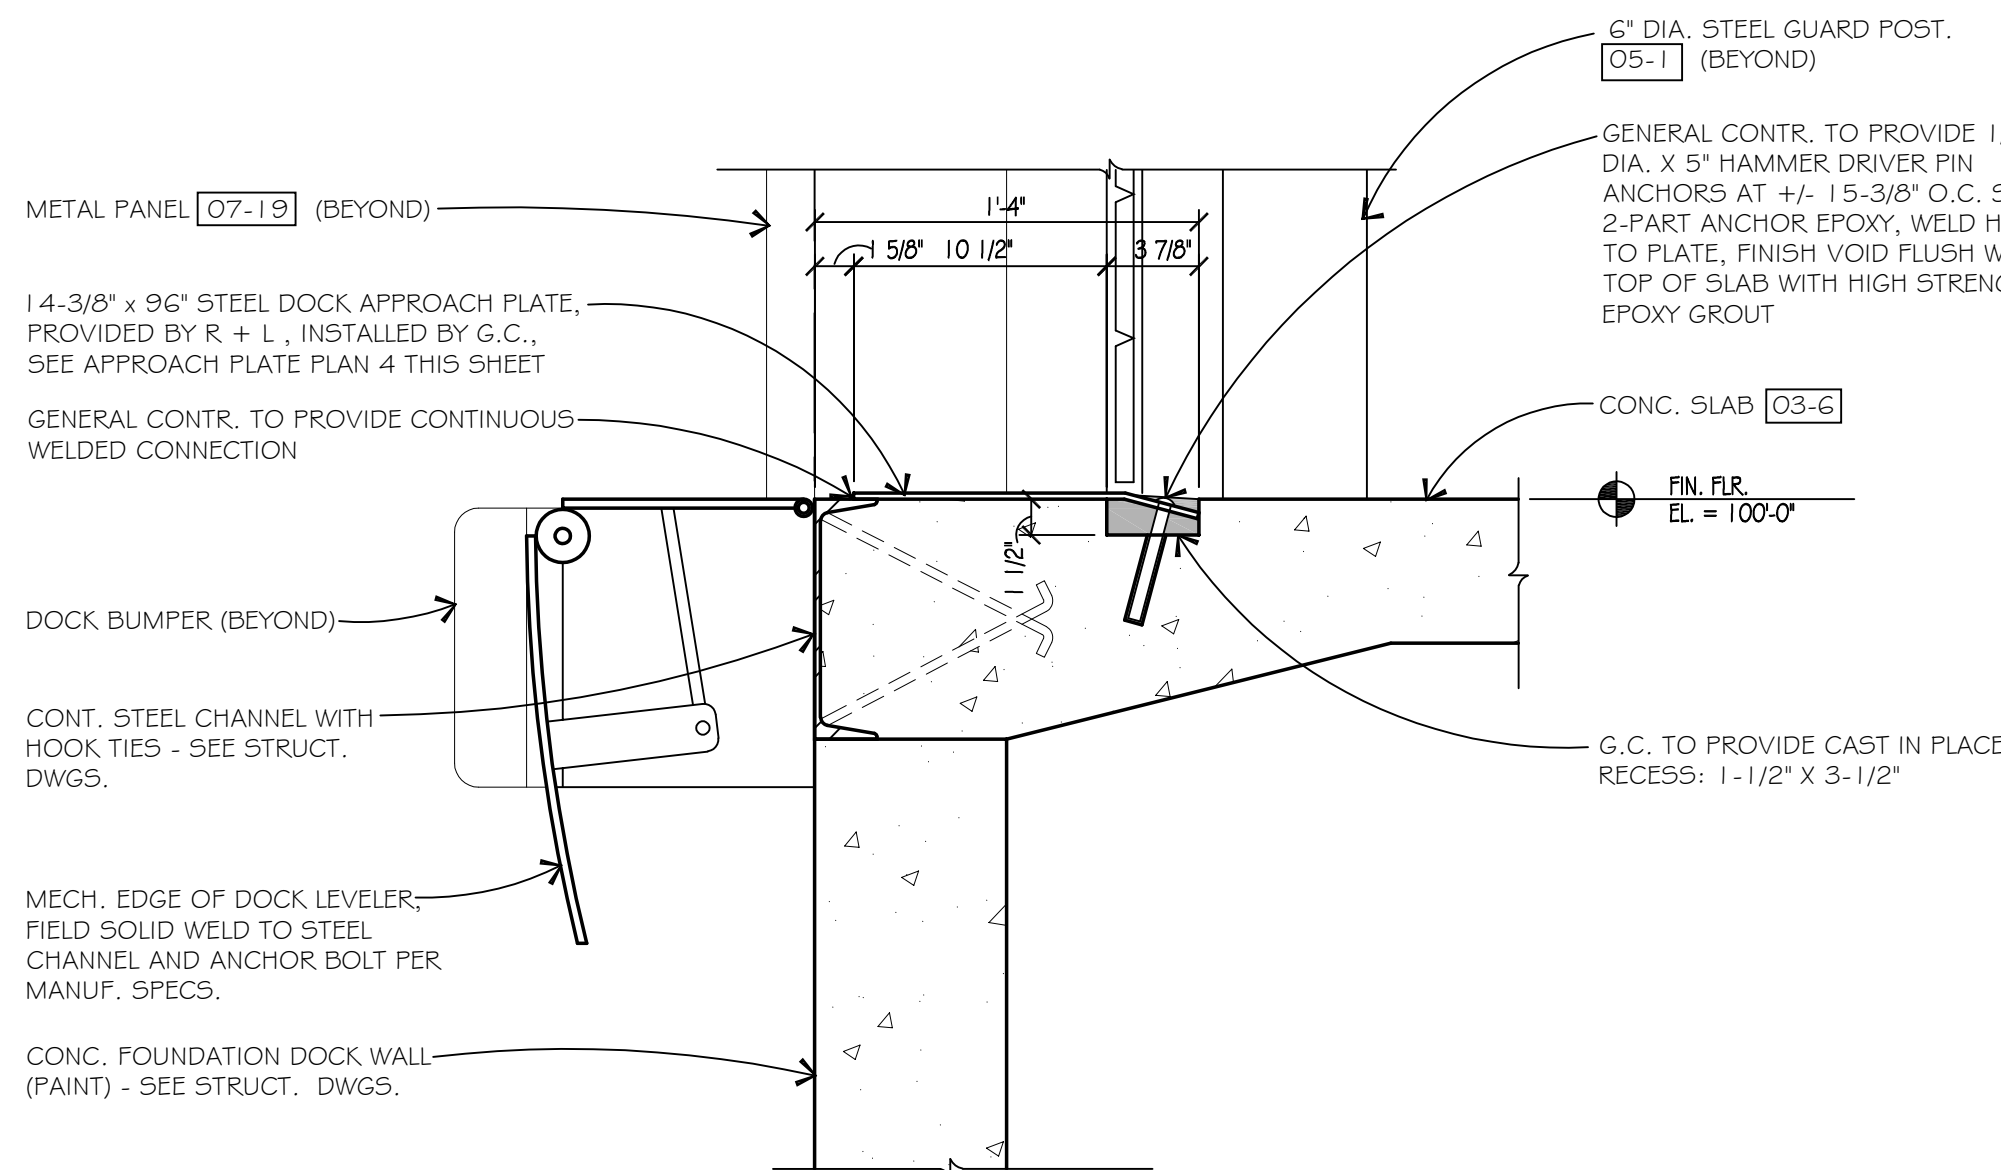

DETAIL (3)  
SCALE: 1-1/2"=1'-0"

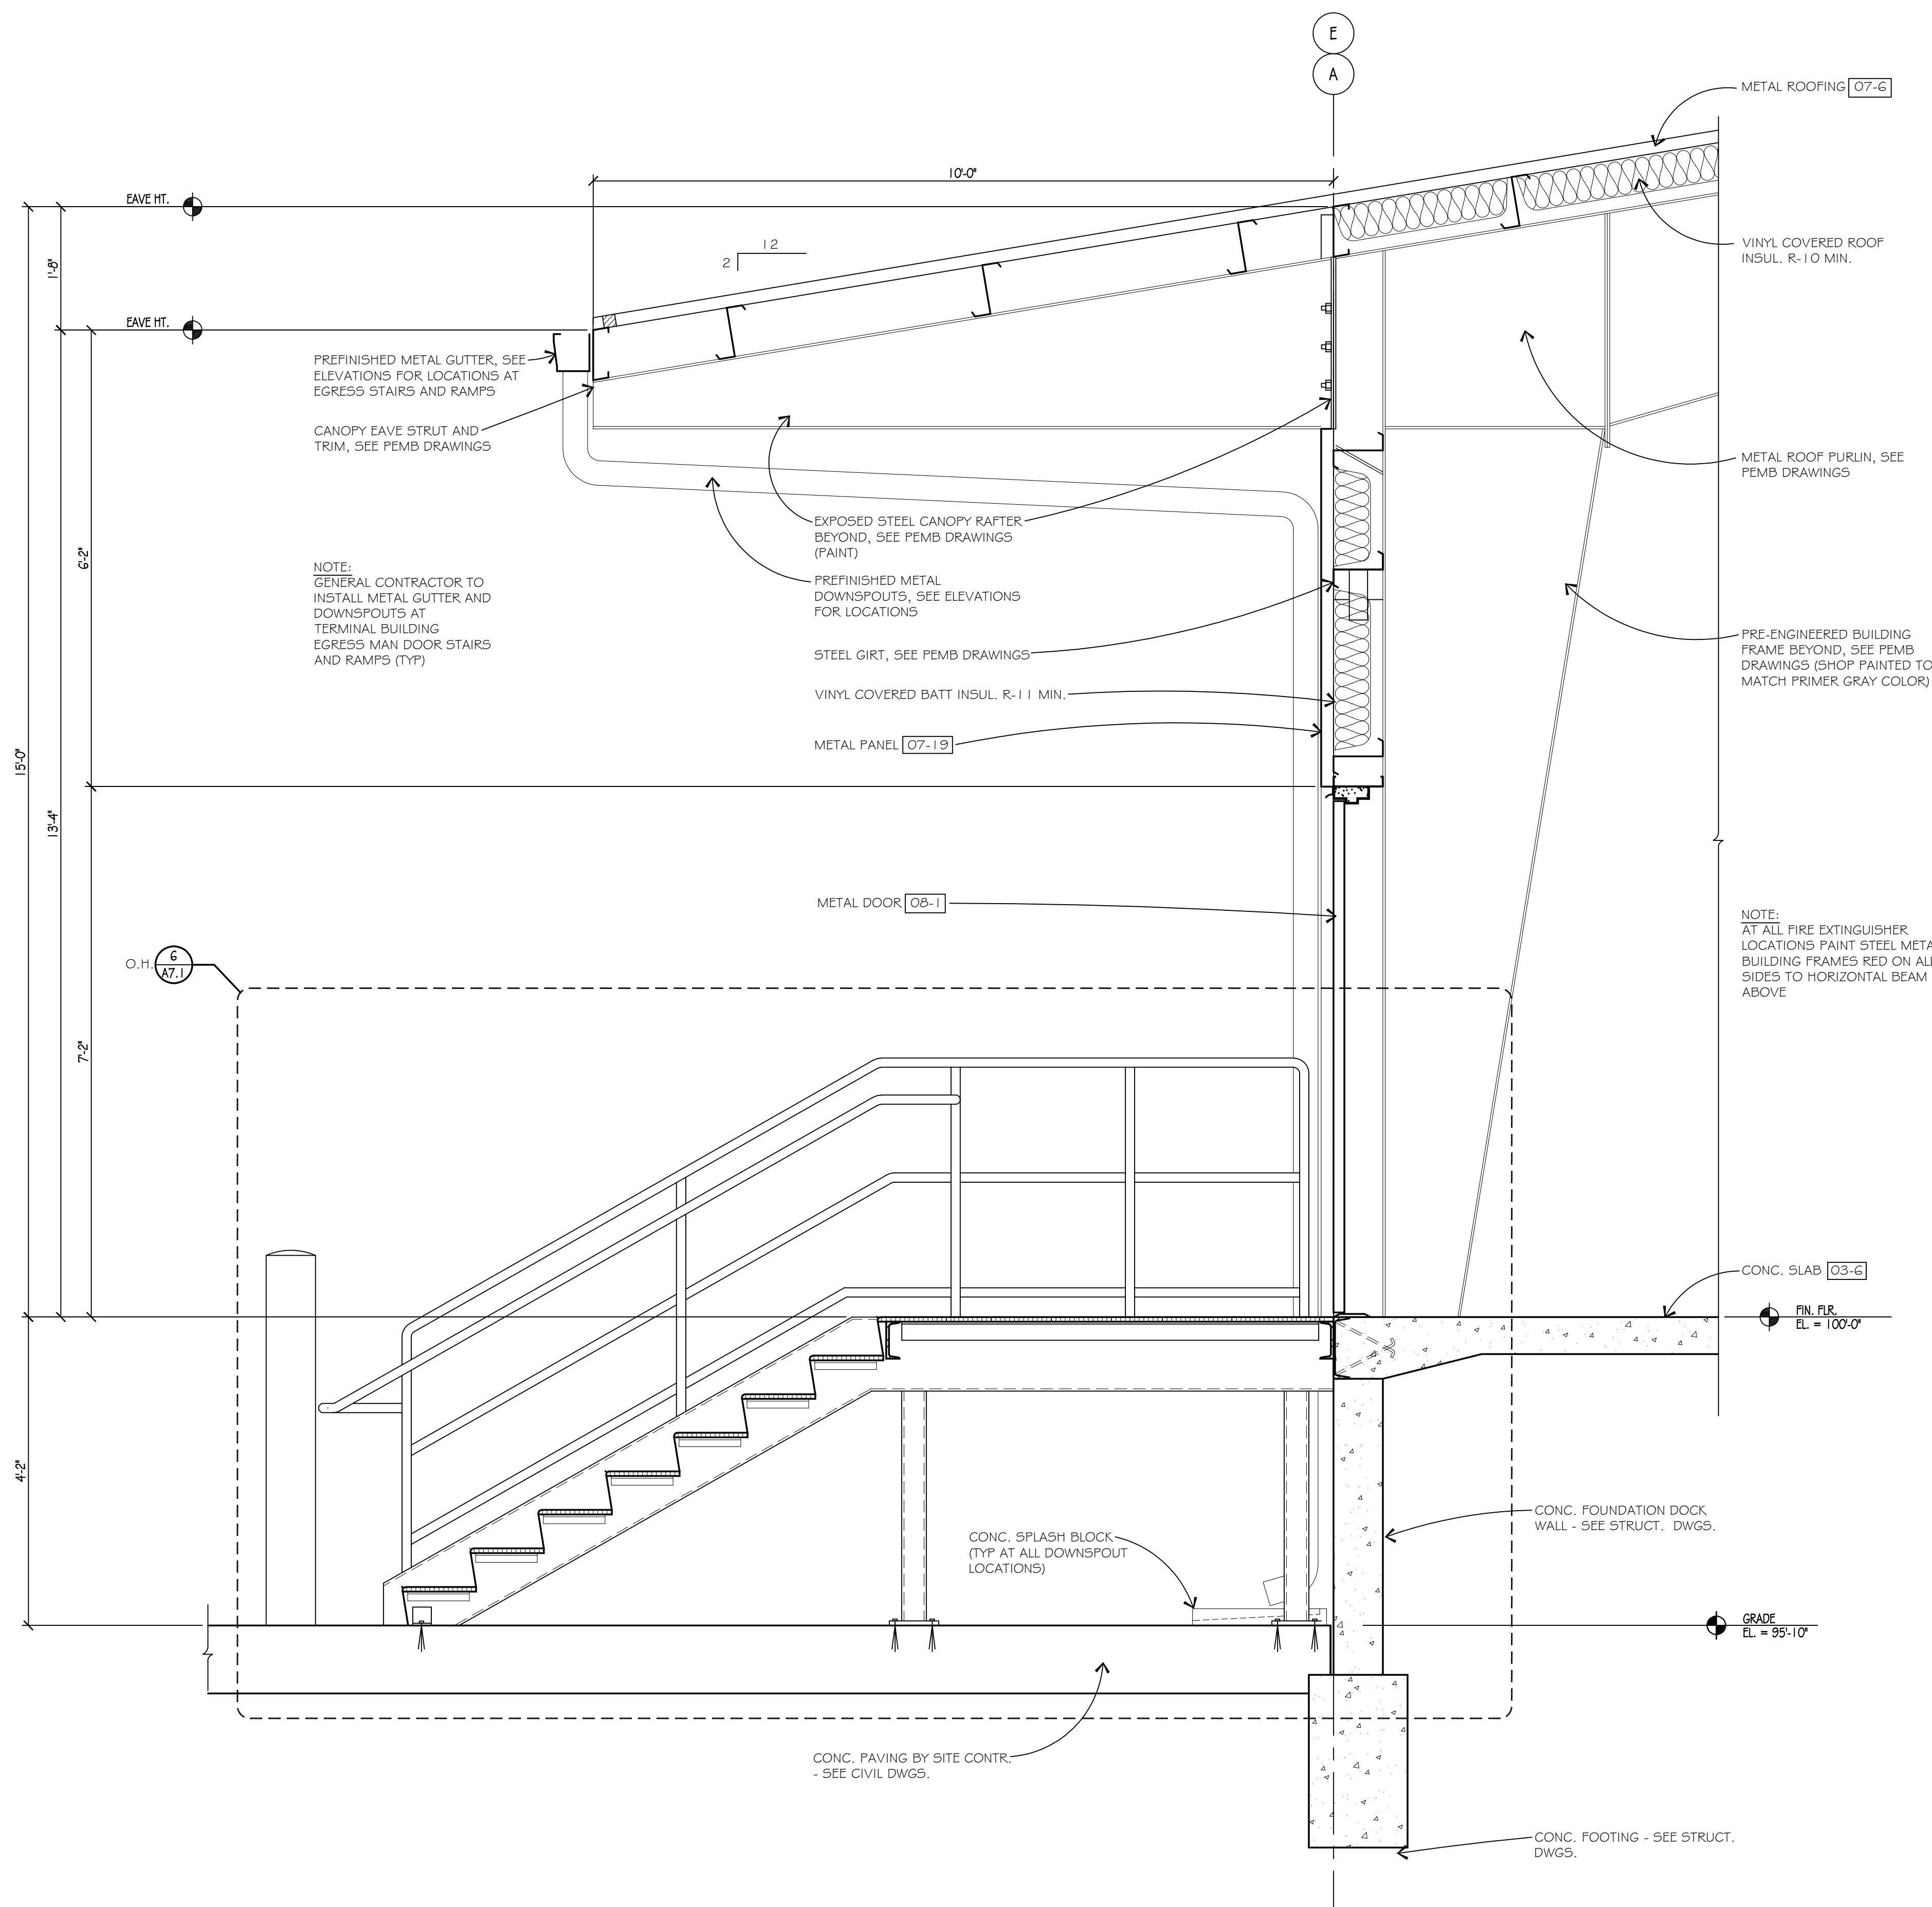


WALL SECTION (2)  
SCALE: 3/4"=1'-0"

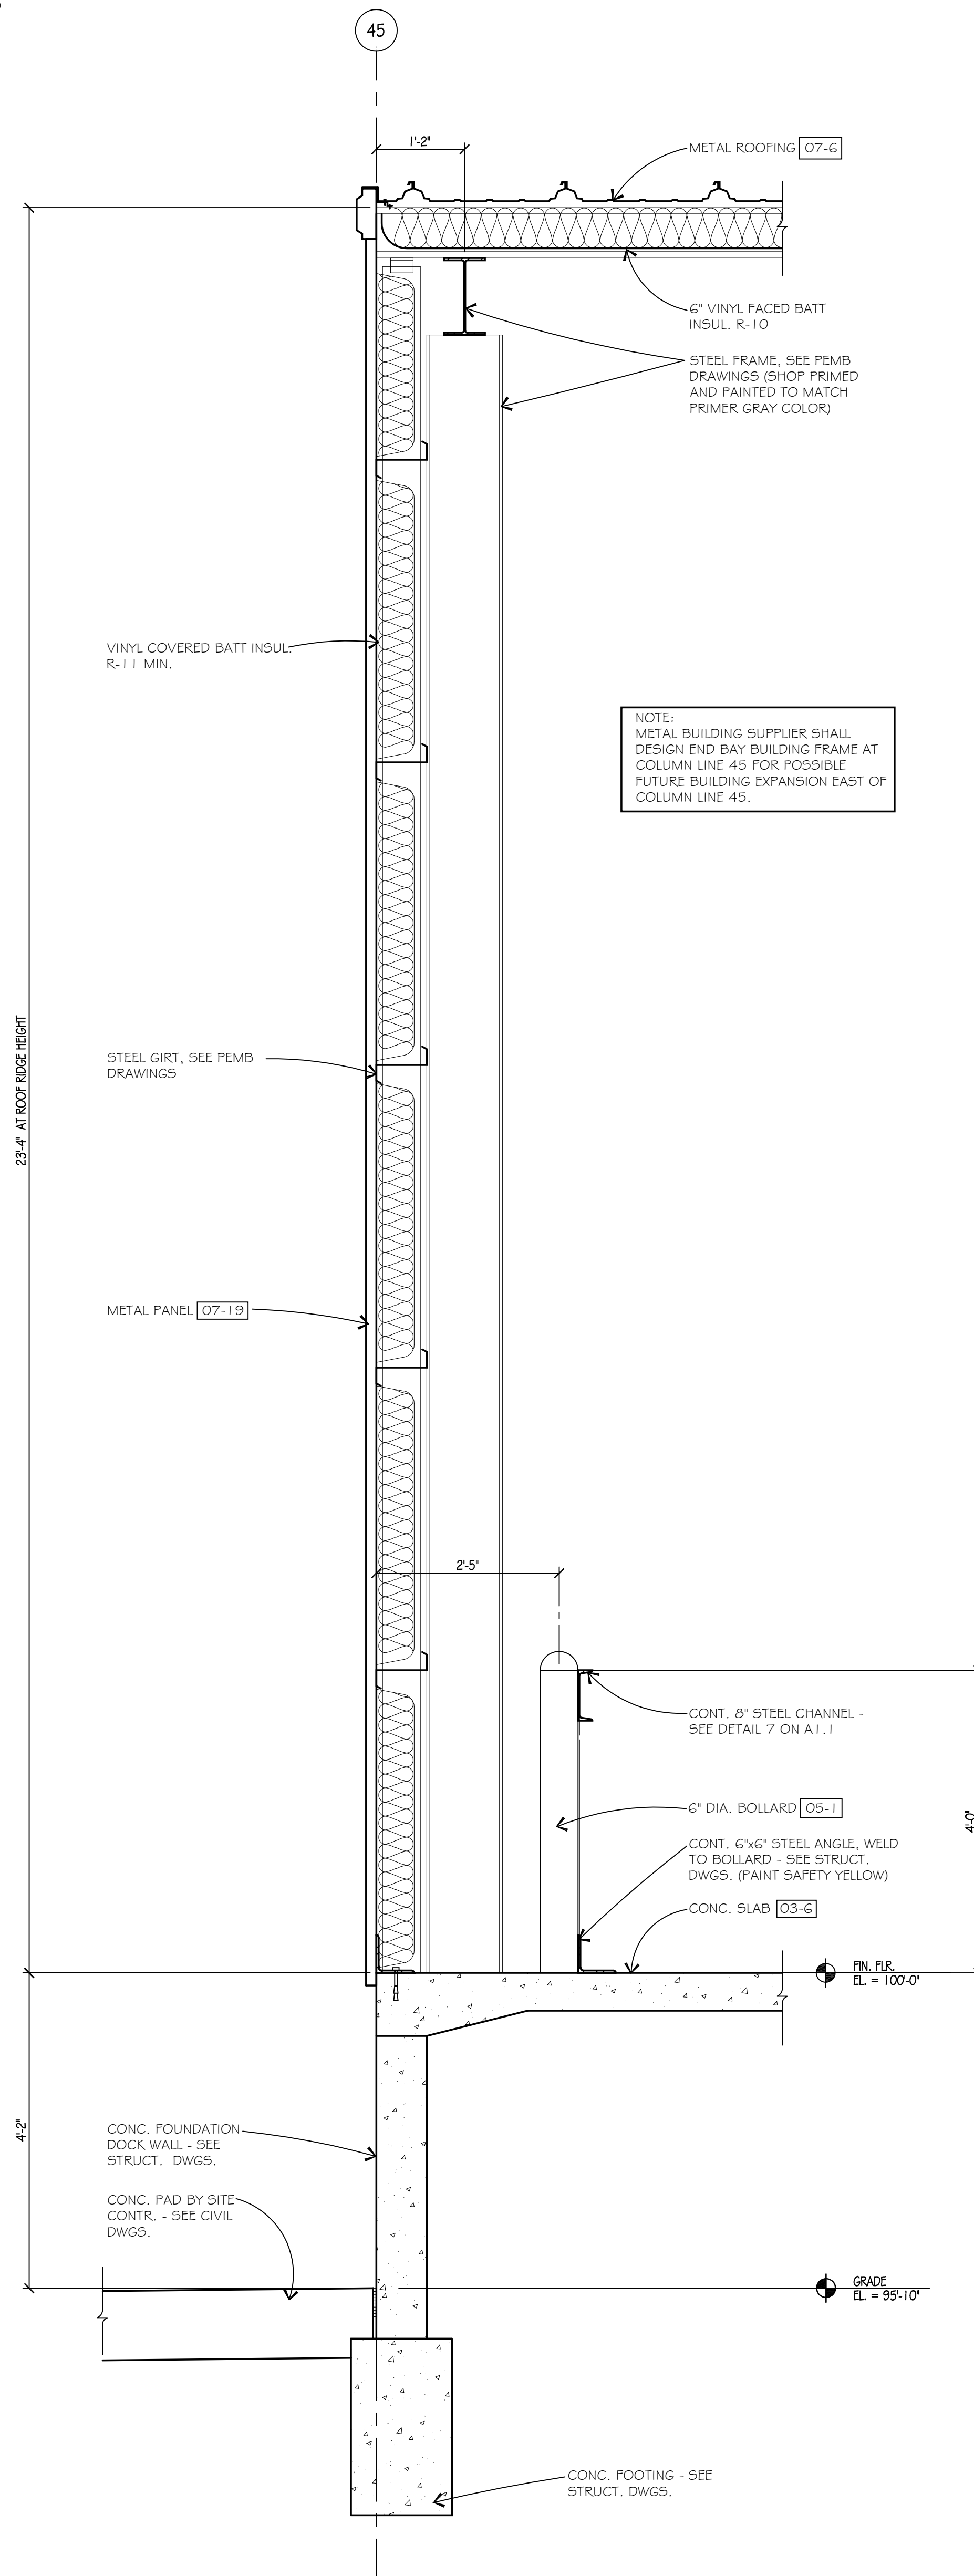


WALL SECTION (1)  
SCALE: 3/4"=1'-0"



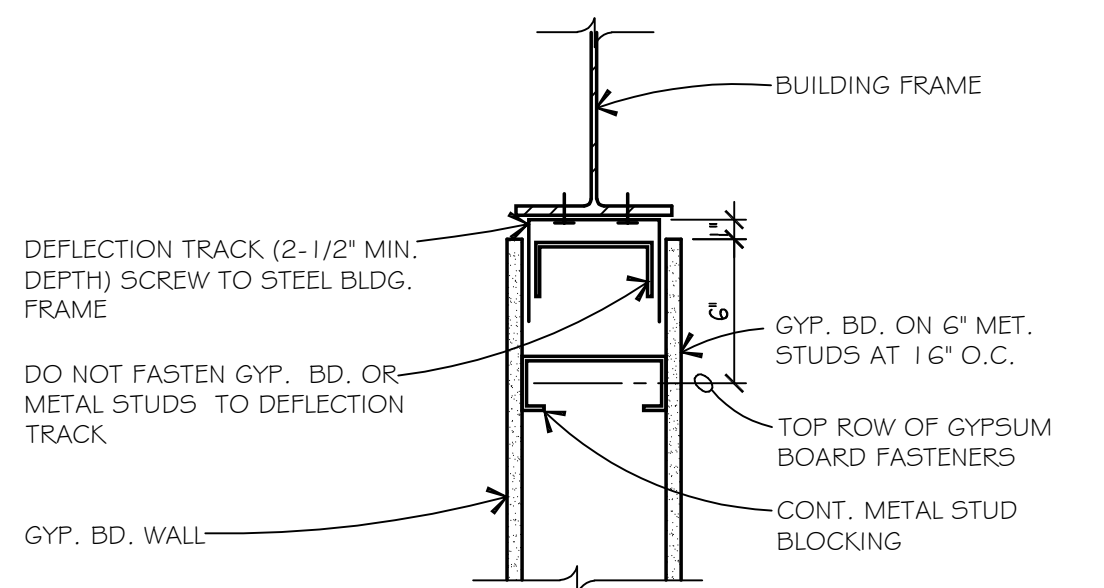


DEFLECTION TRACK DETAIL  
SCALE: 1 1/2" = 1'-0"

10  
A2.4, A4.4

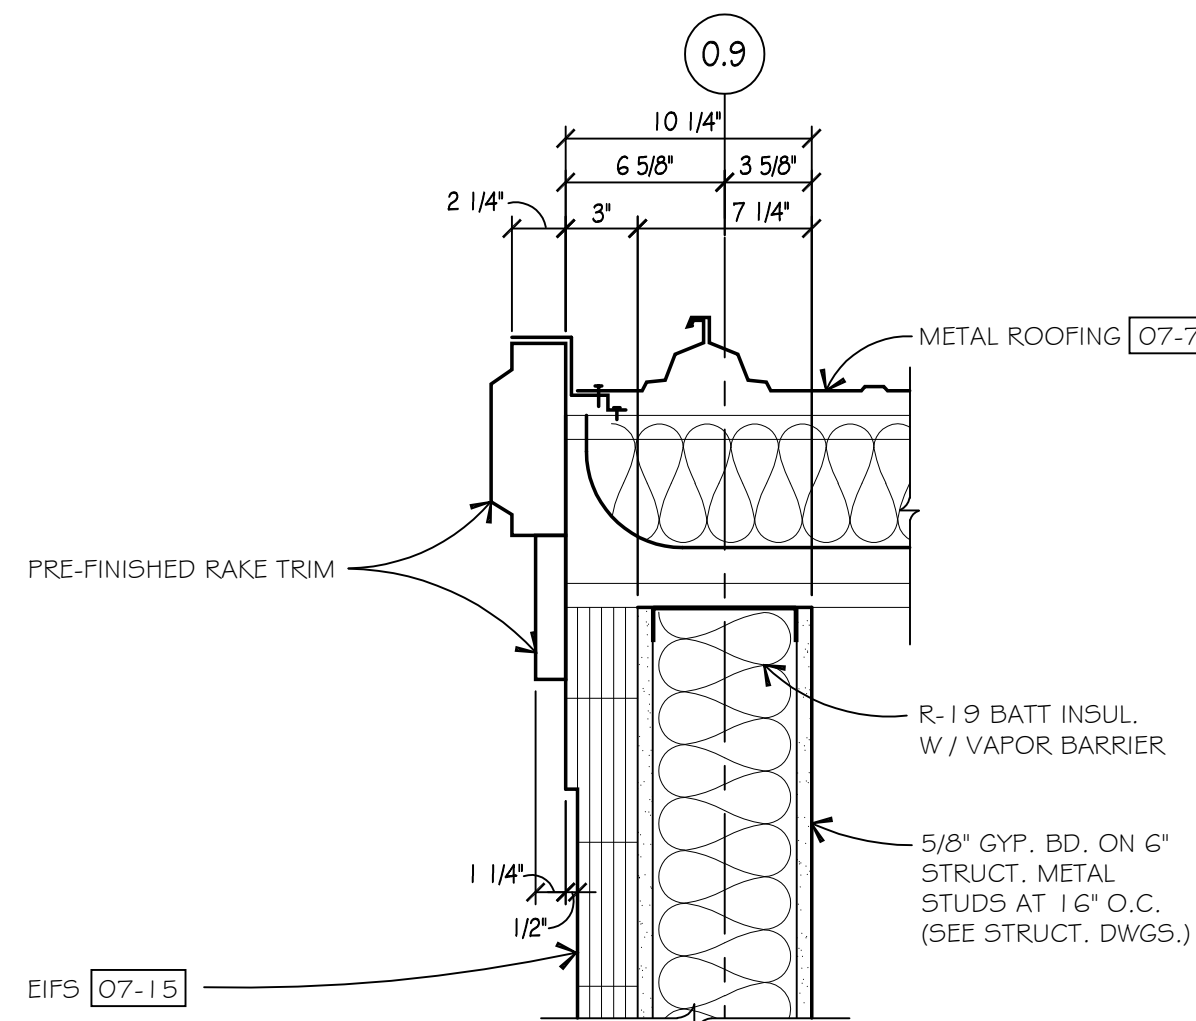


DETAIL  
SCALE: 1 1/2" = 1'-0"

9  
A5.3

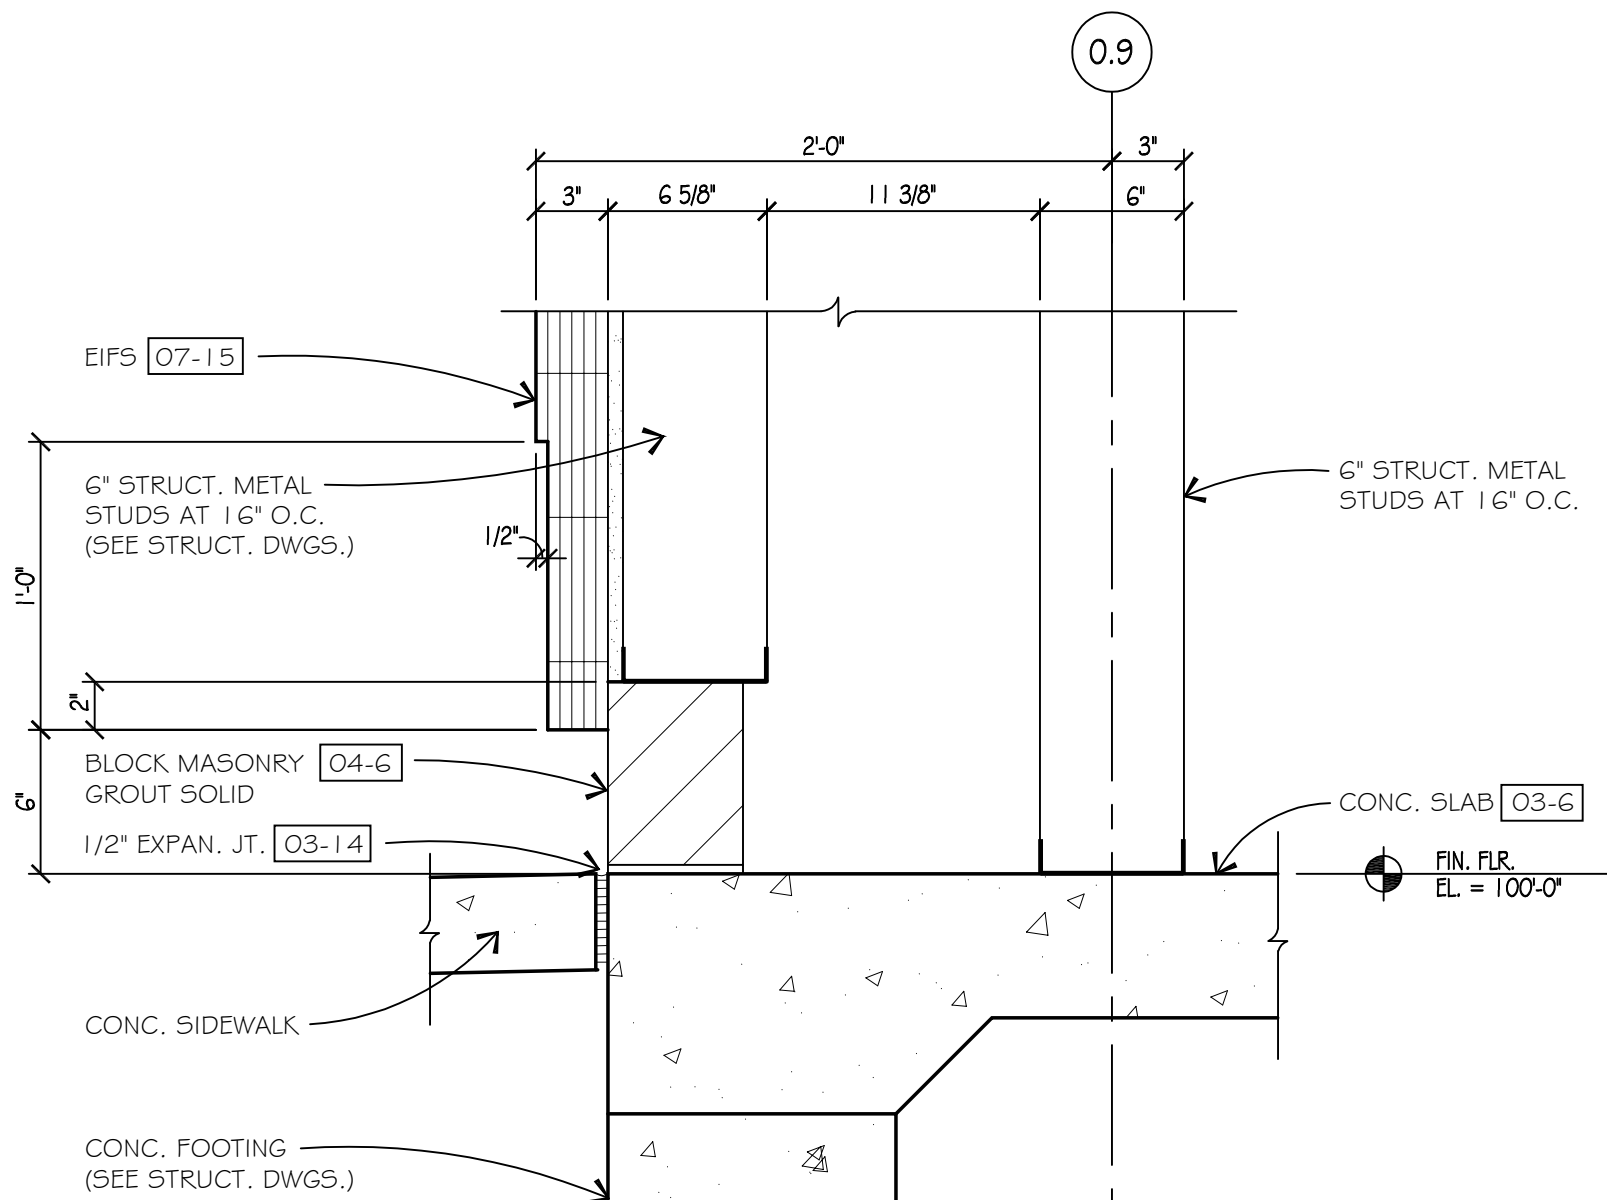


DETAIL  
SCALE: 1 1/2" = 1'-0"

5  
A5.3

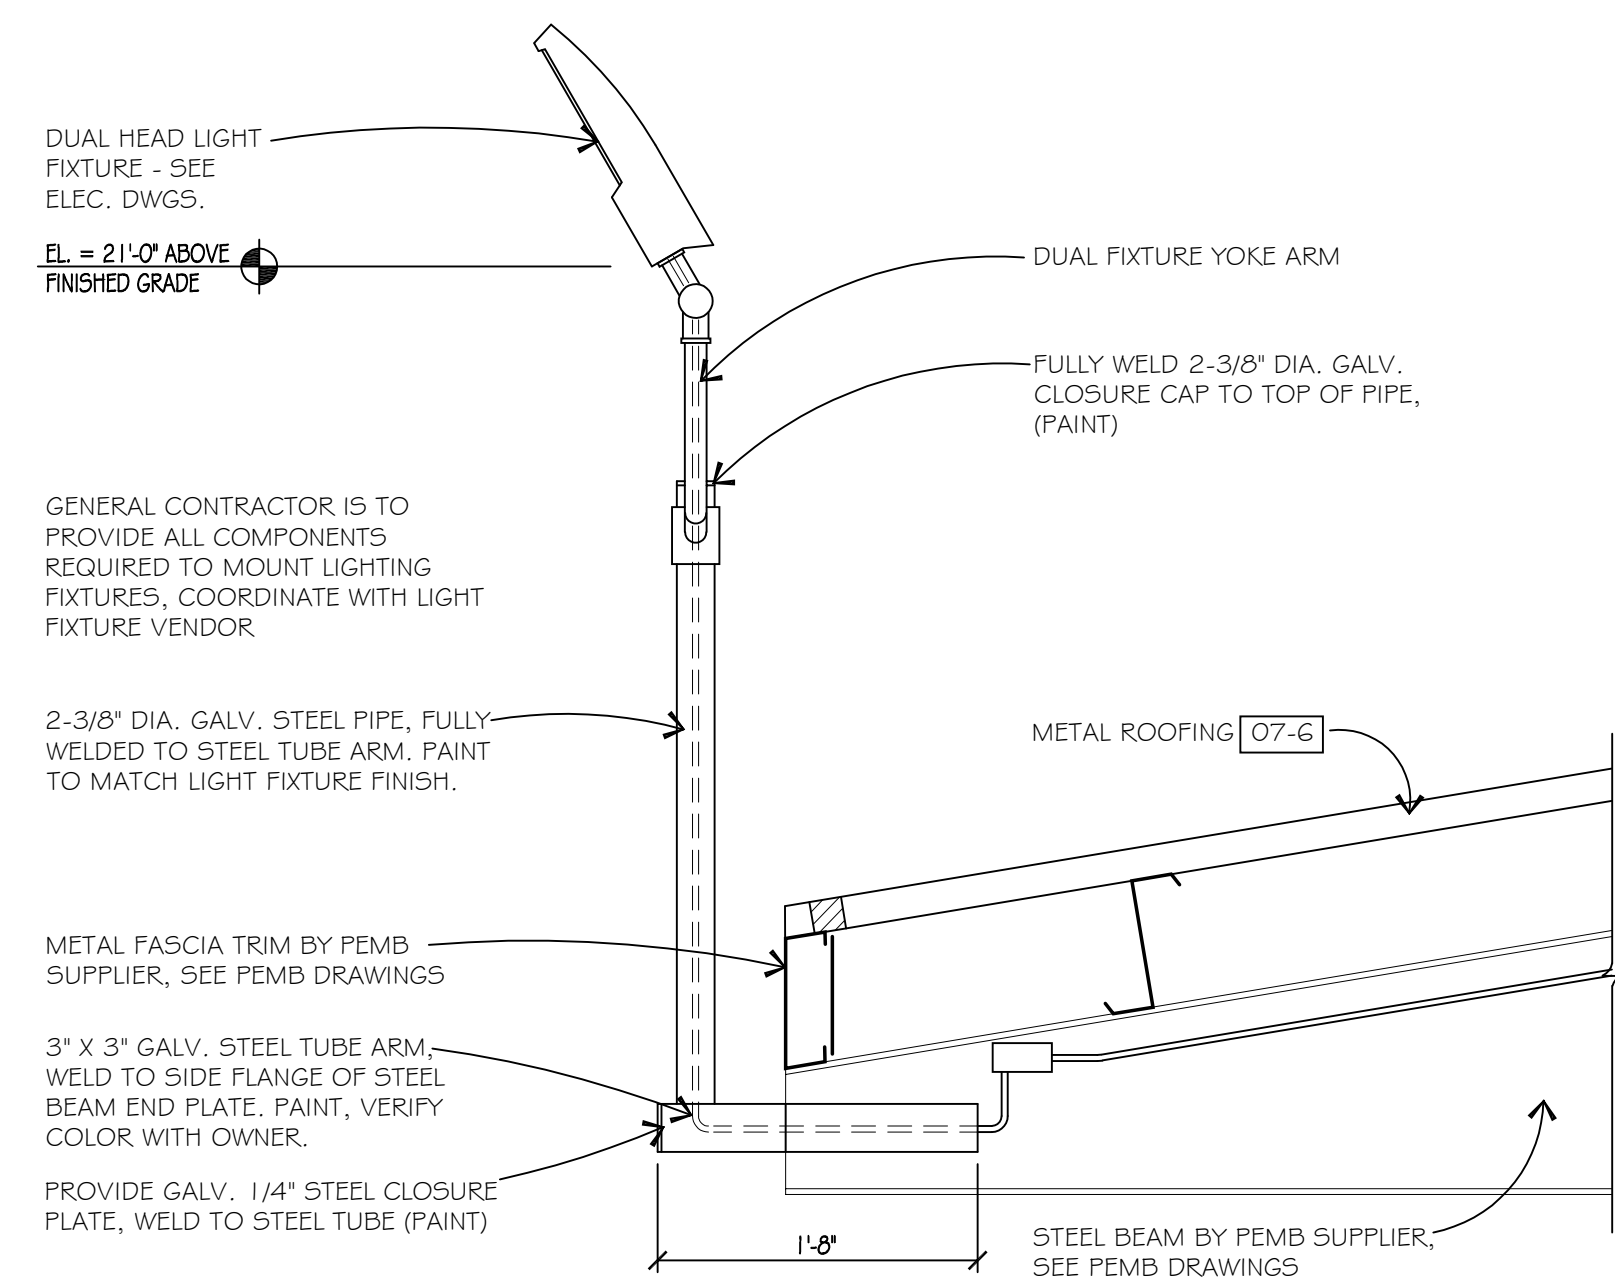


DETAIL  
SCALE: 1" = 1'-0"

4  
A5.1

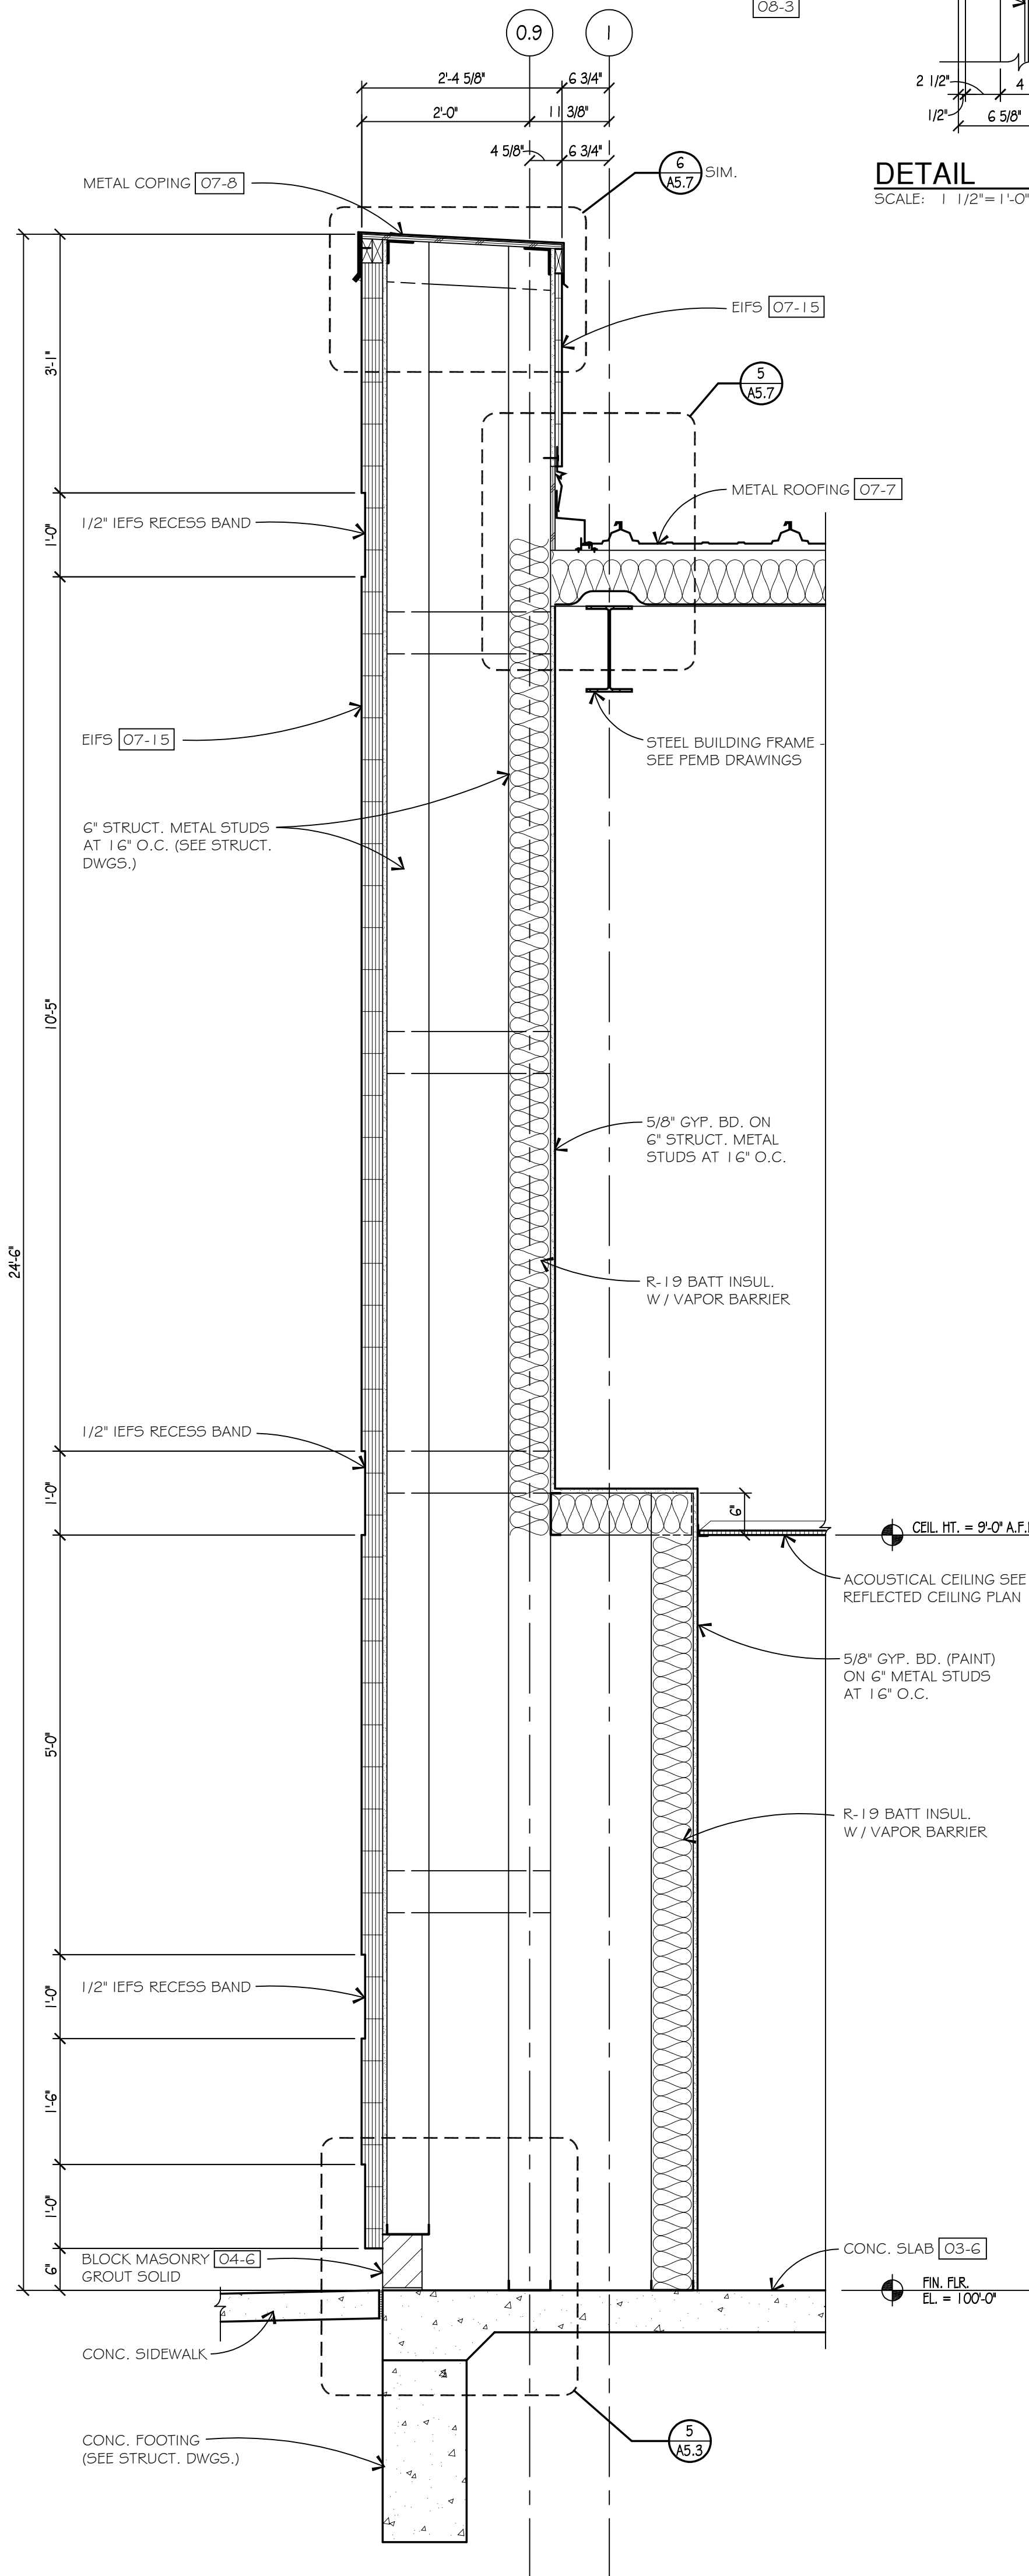


WALL SECTION  
SCALE: 3/4" = 1'-0"

3  
A4.1

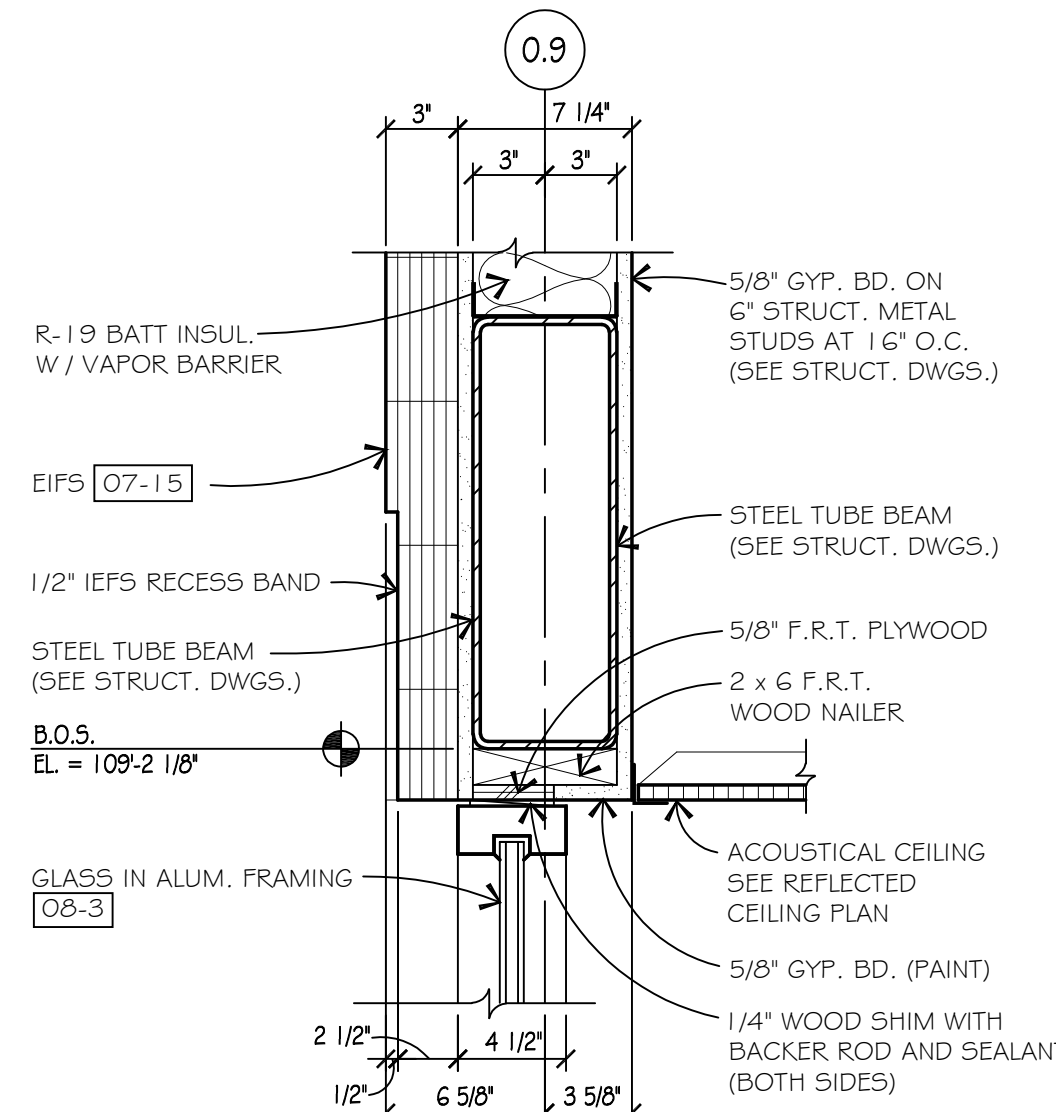


DETAIL  
SCALE: 1 1/2" = 1'-0"

8  
A5.7

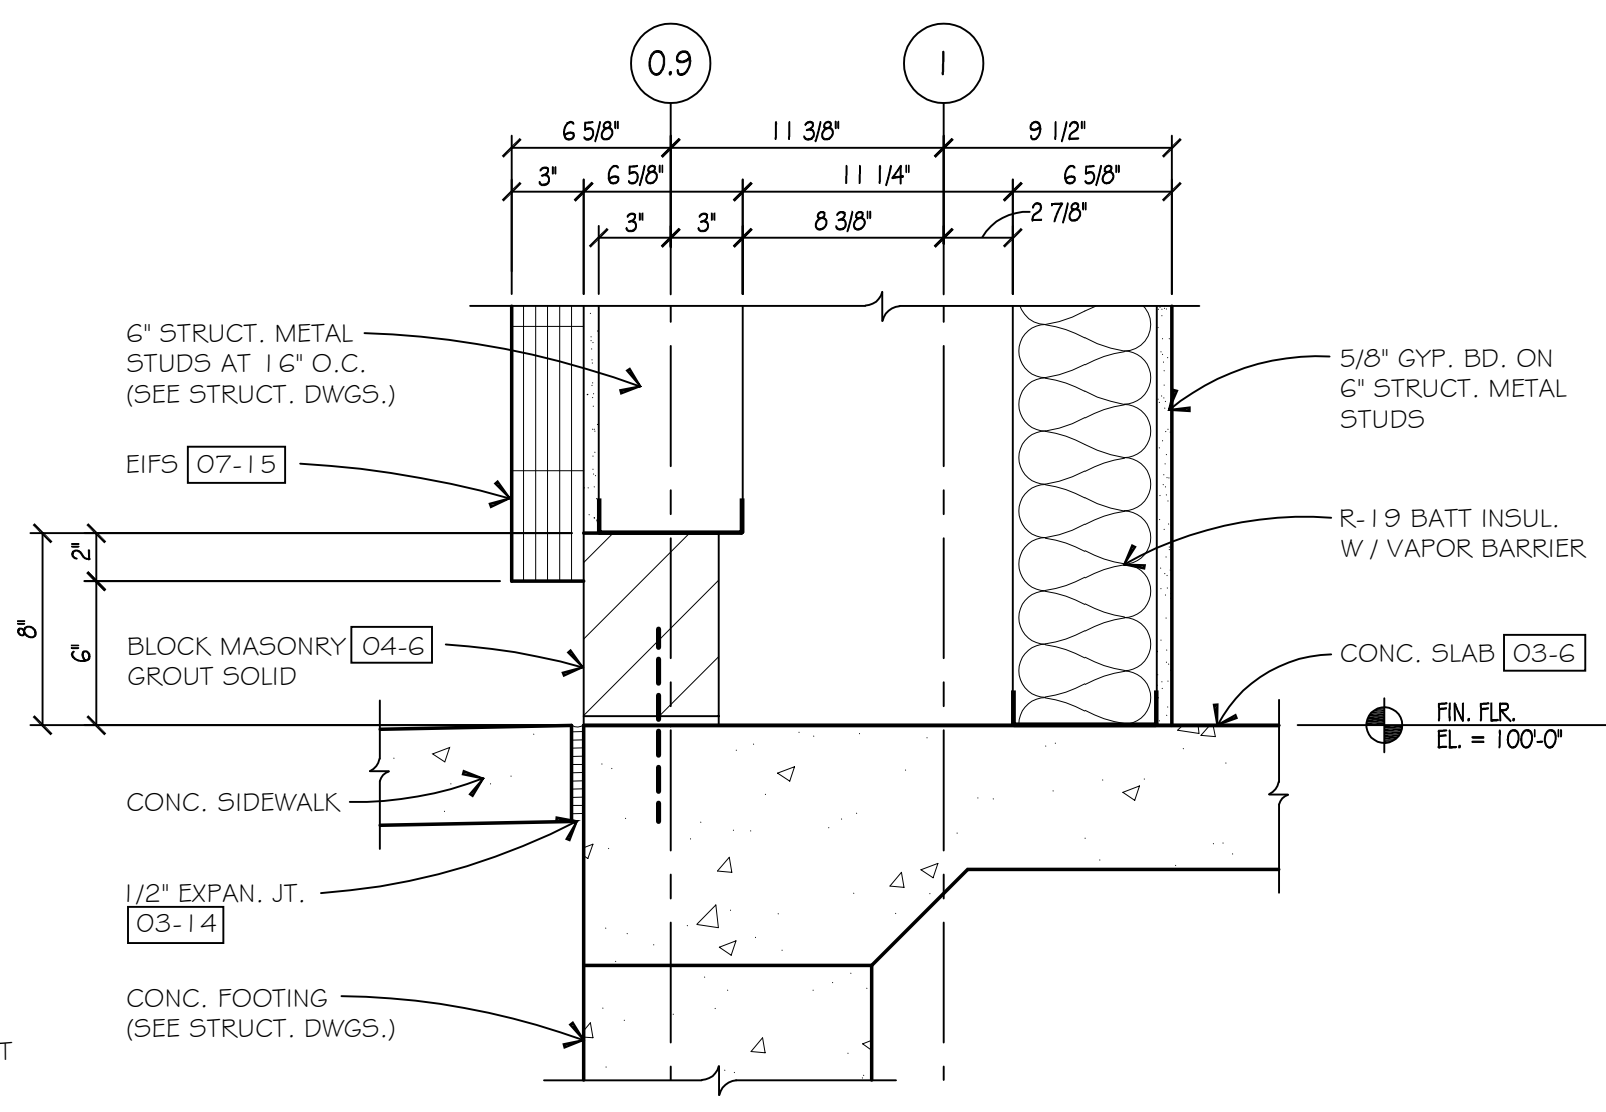


DETAIL  
SCALE: 1 1/2" = 1'-0"

7  
A5.3

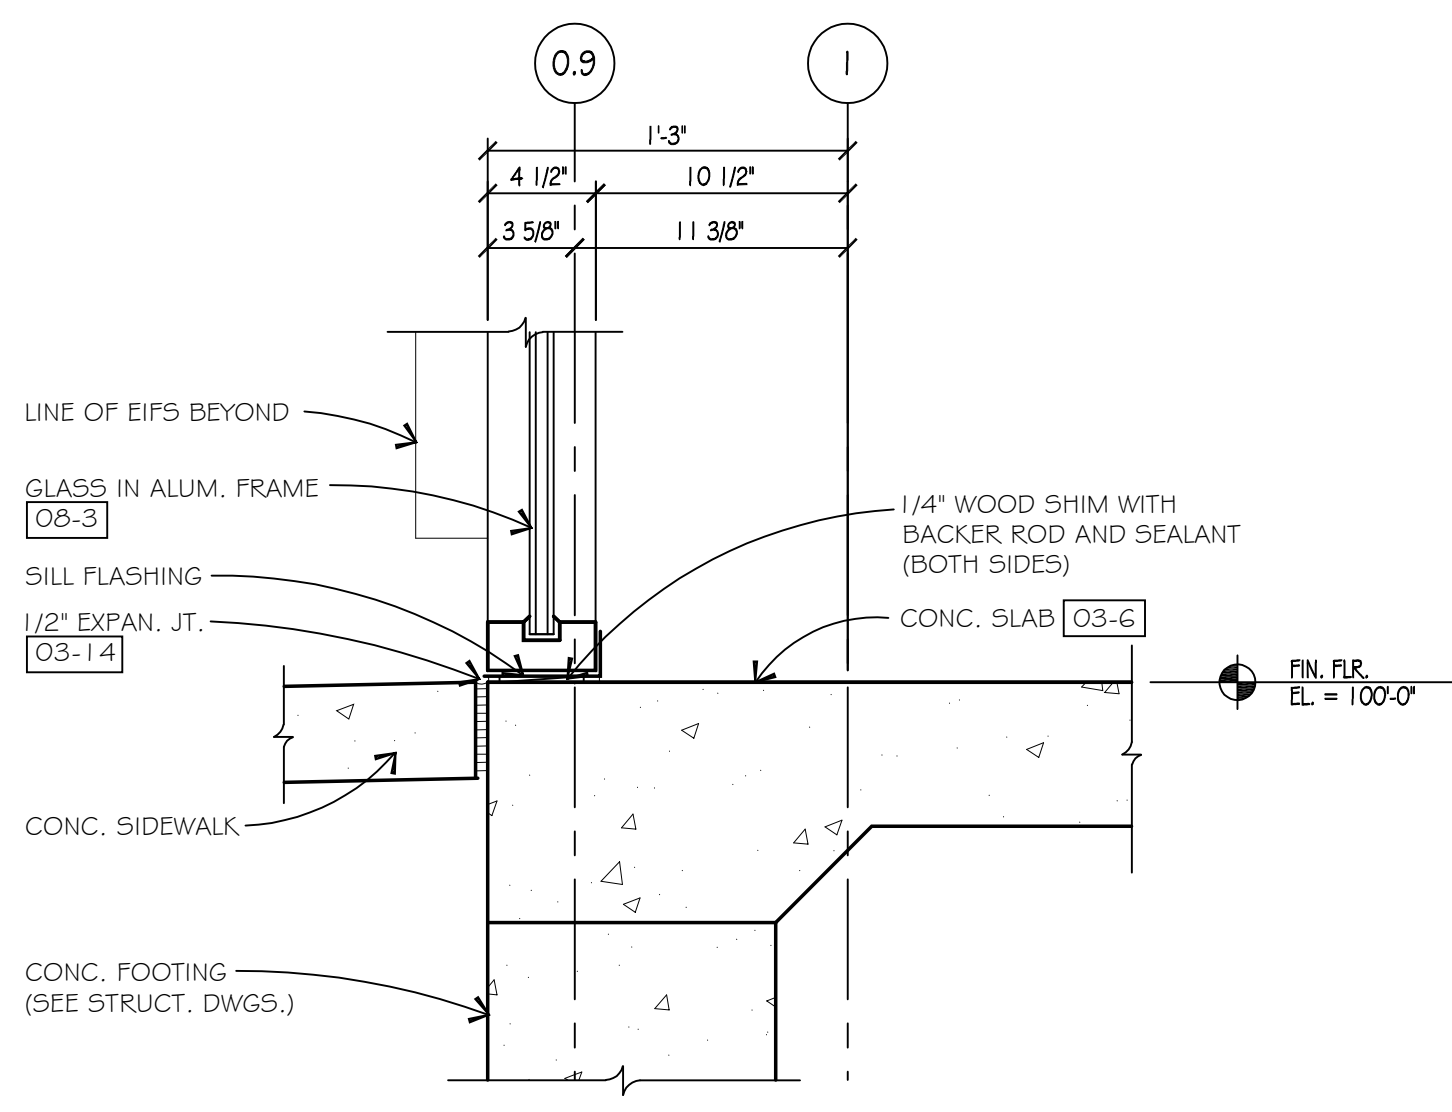


DETAIL  
SCALE: 1 1/2" = 1'-0"

6  
A5.3

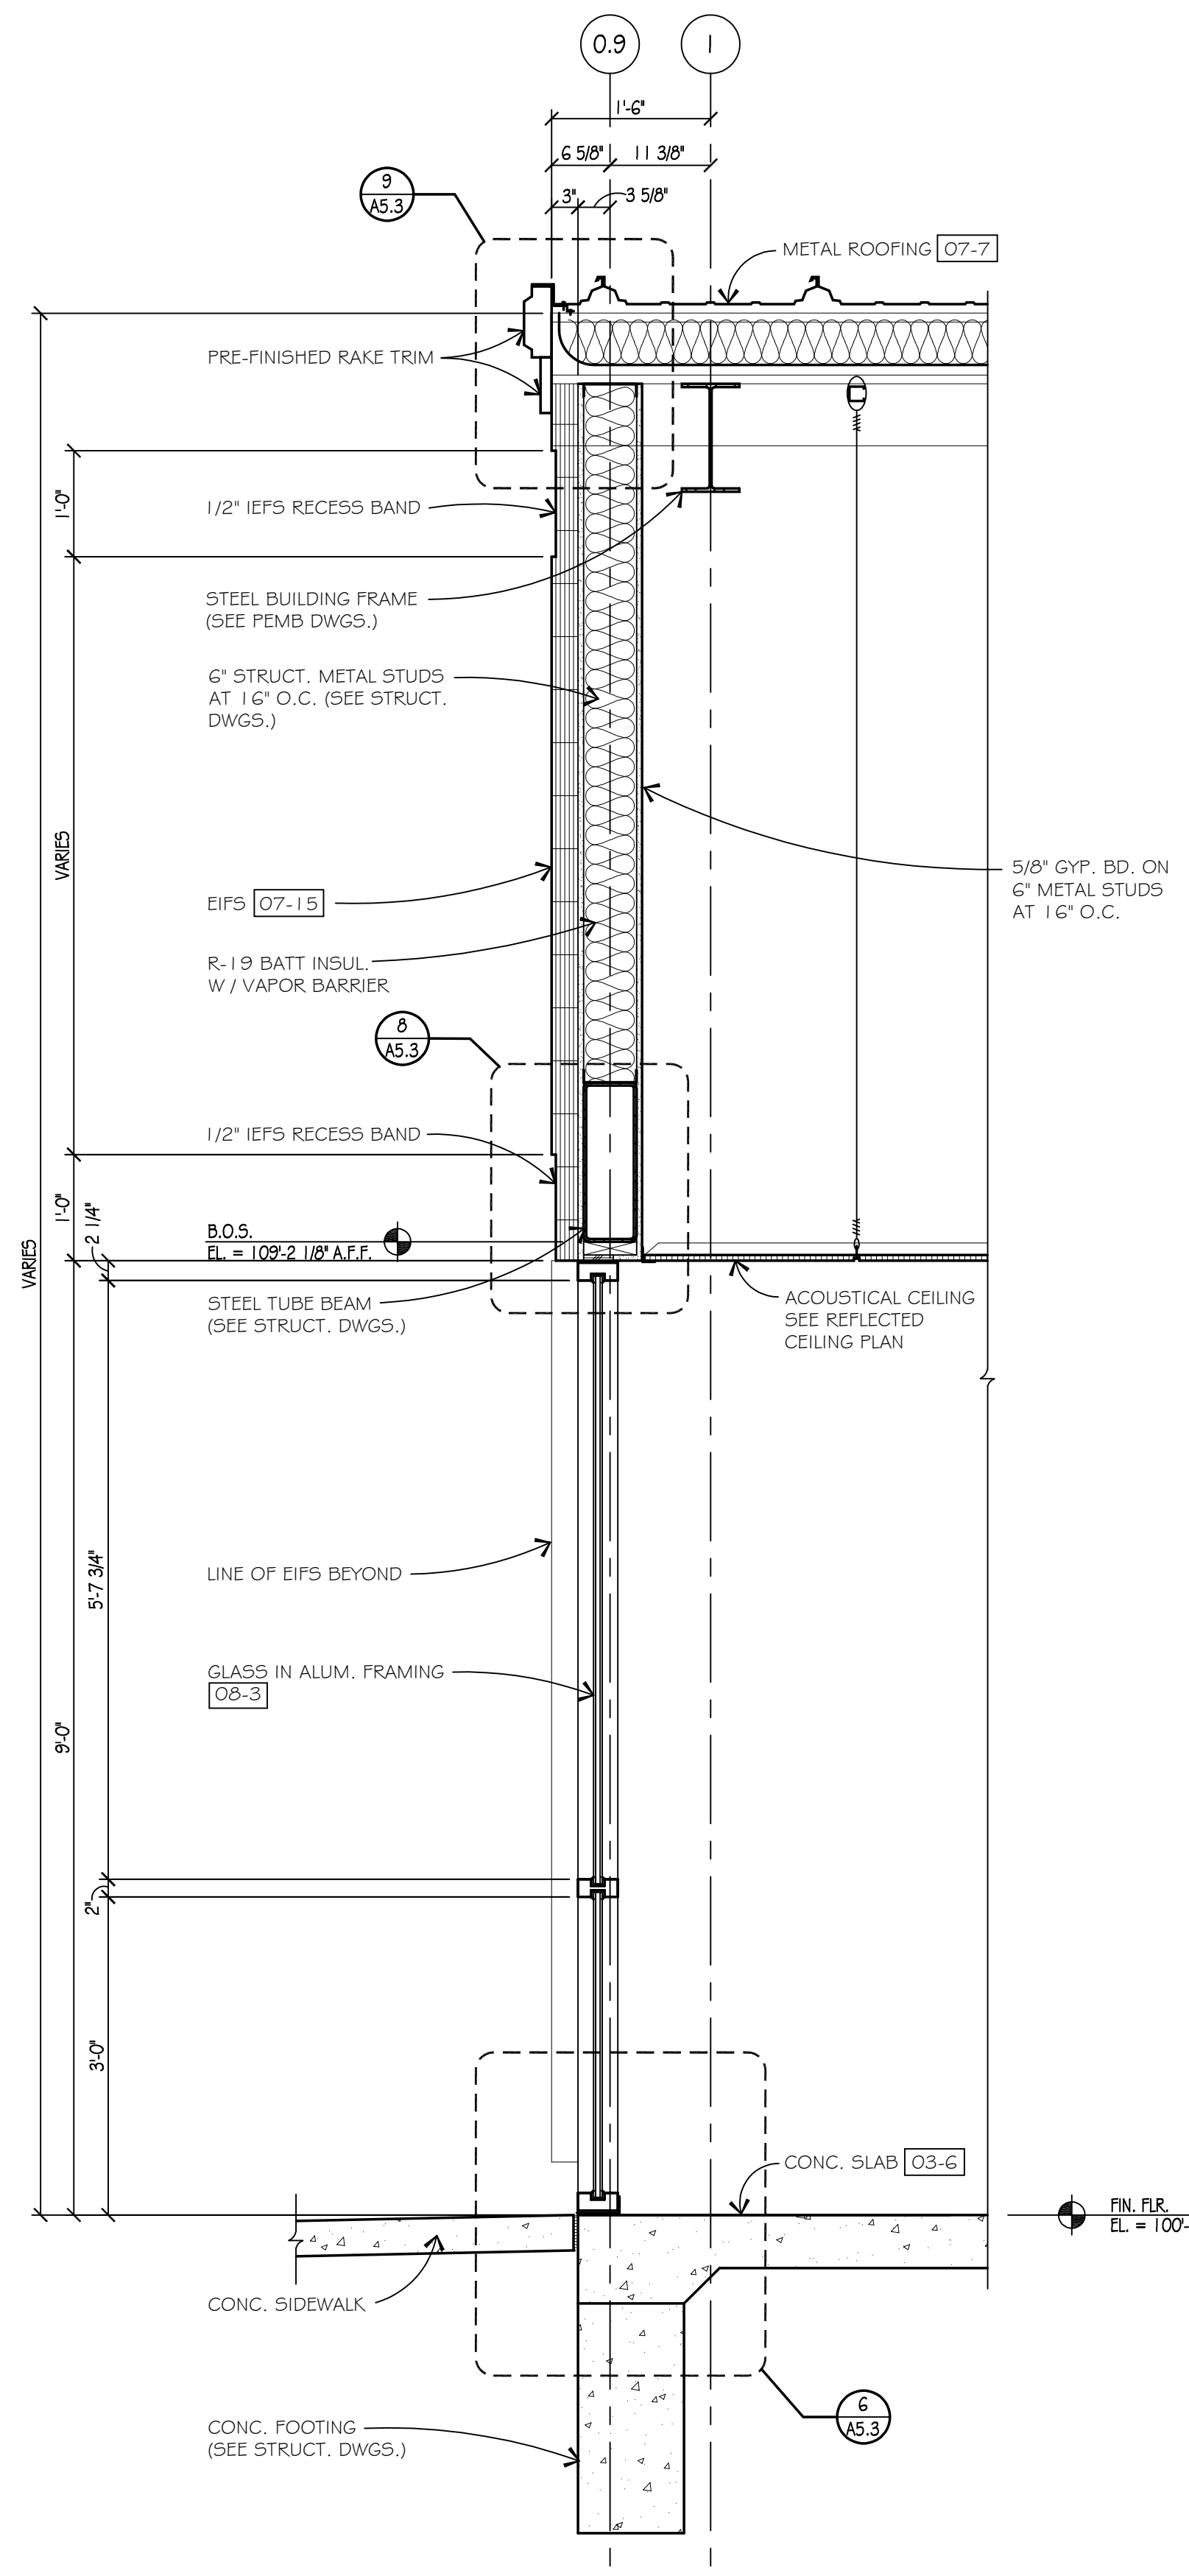


WALL SECTION  
SCALE: 3/4" = 1'-0"

2  
A3.1, A4.1

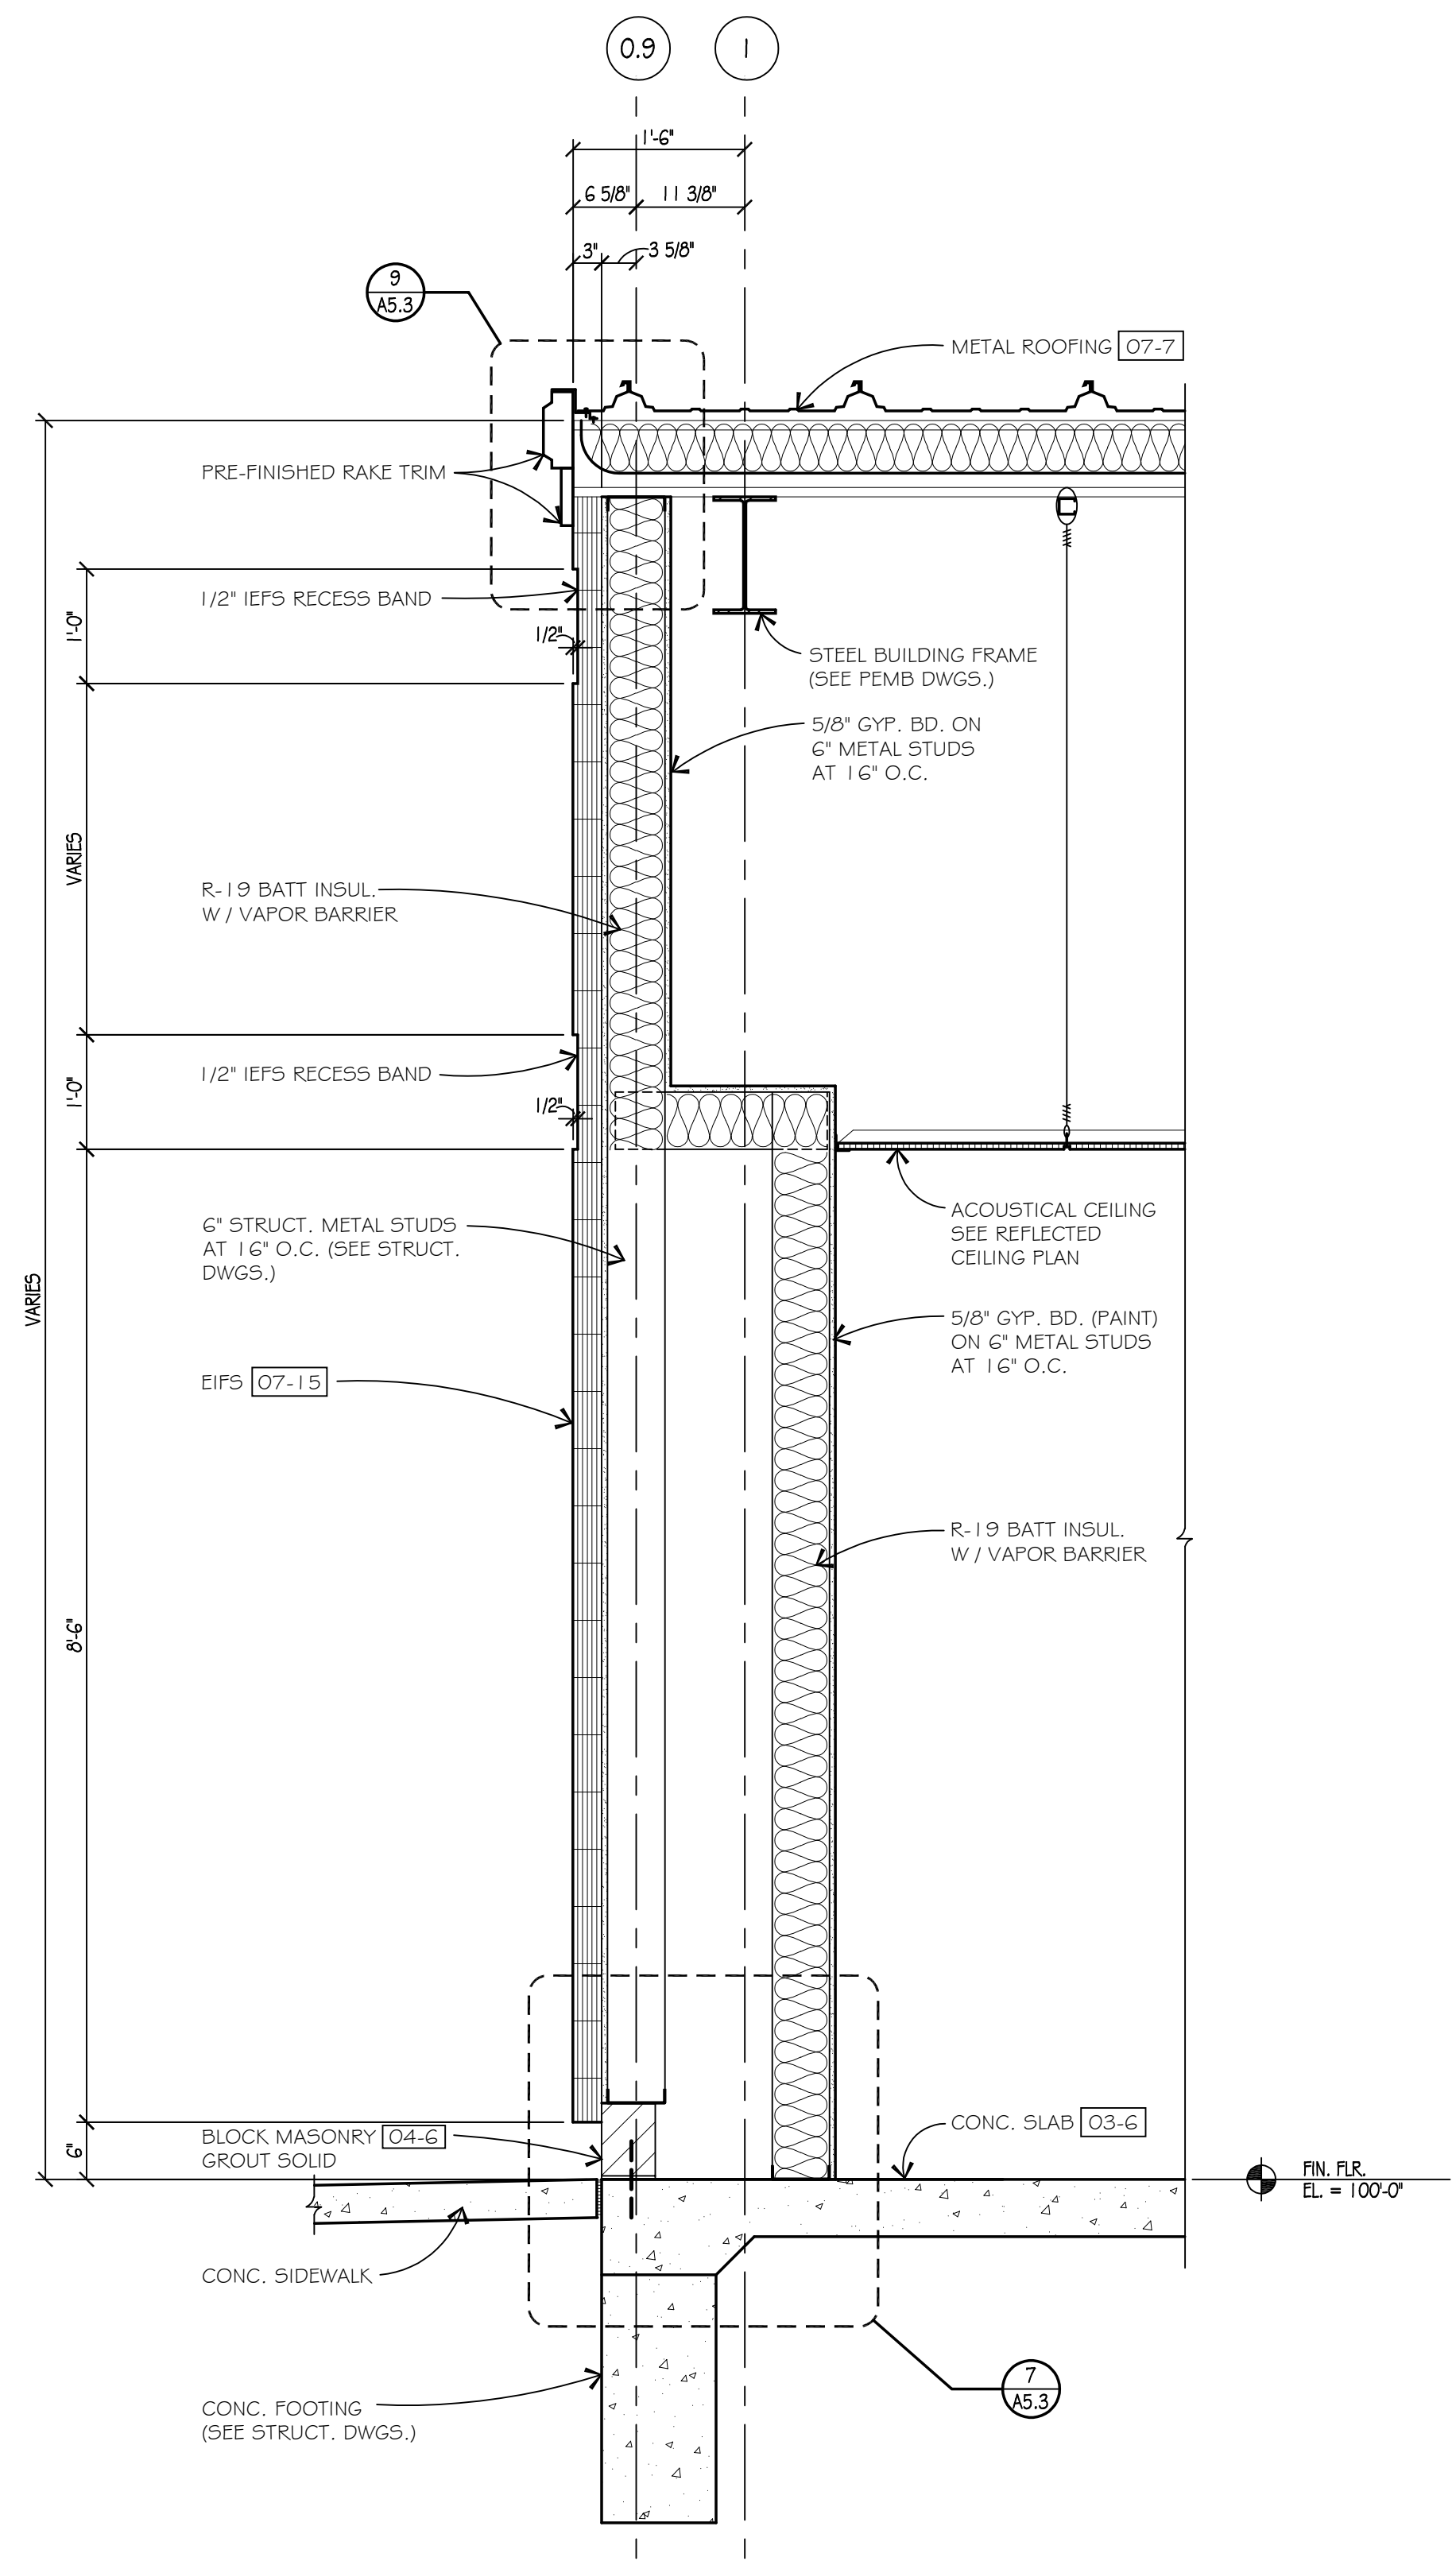

WALL SECTION  
SCALE: 3/4" = 1'-0"

1  
A4.1

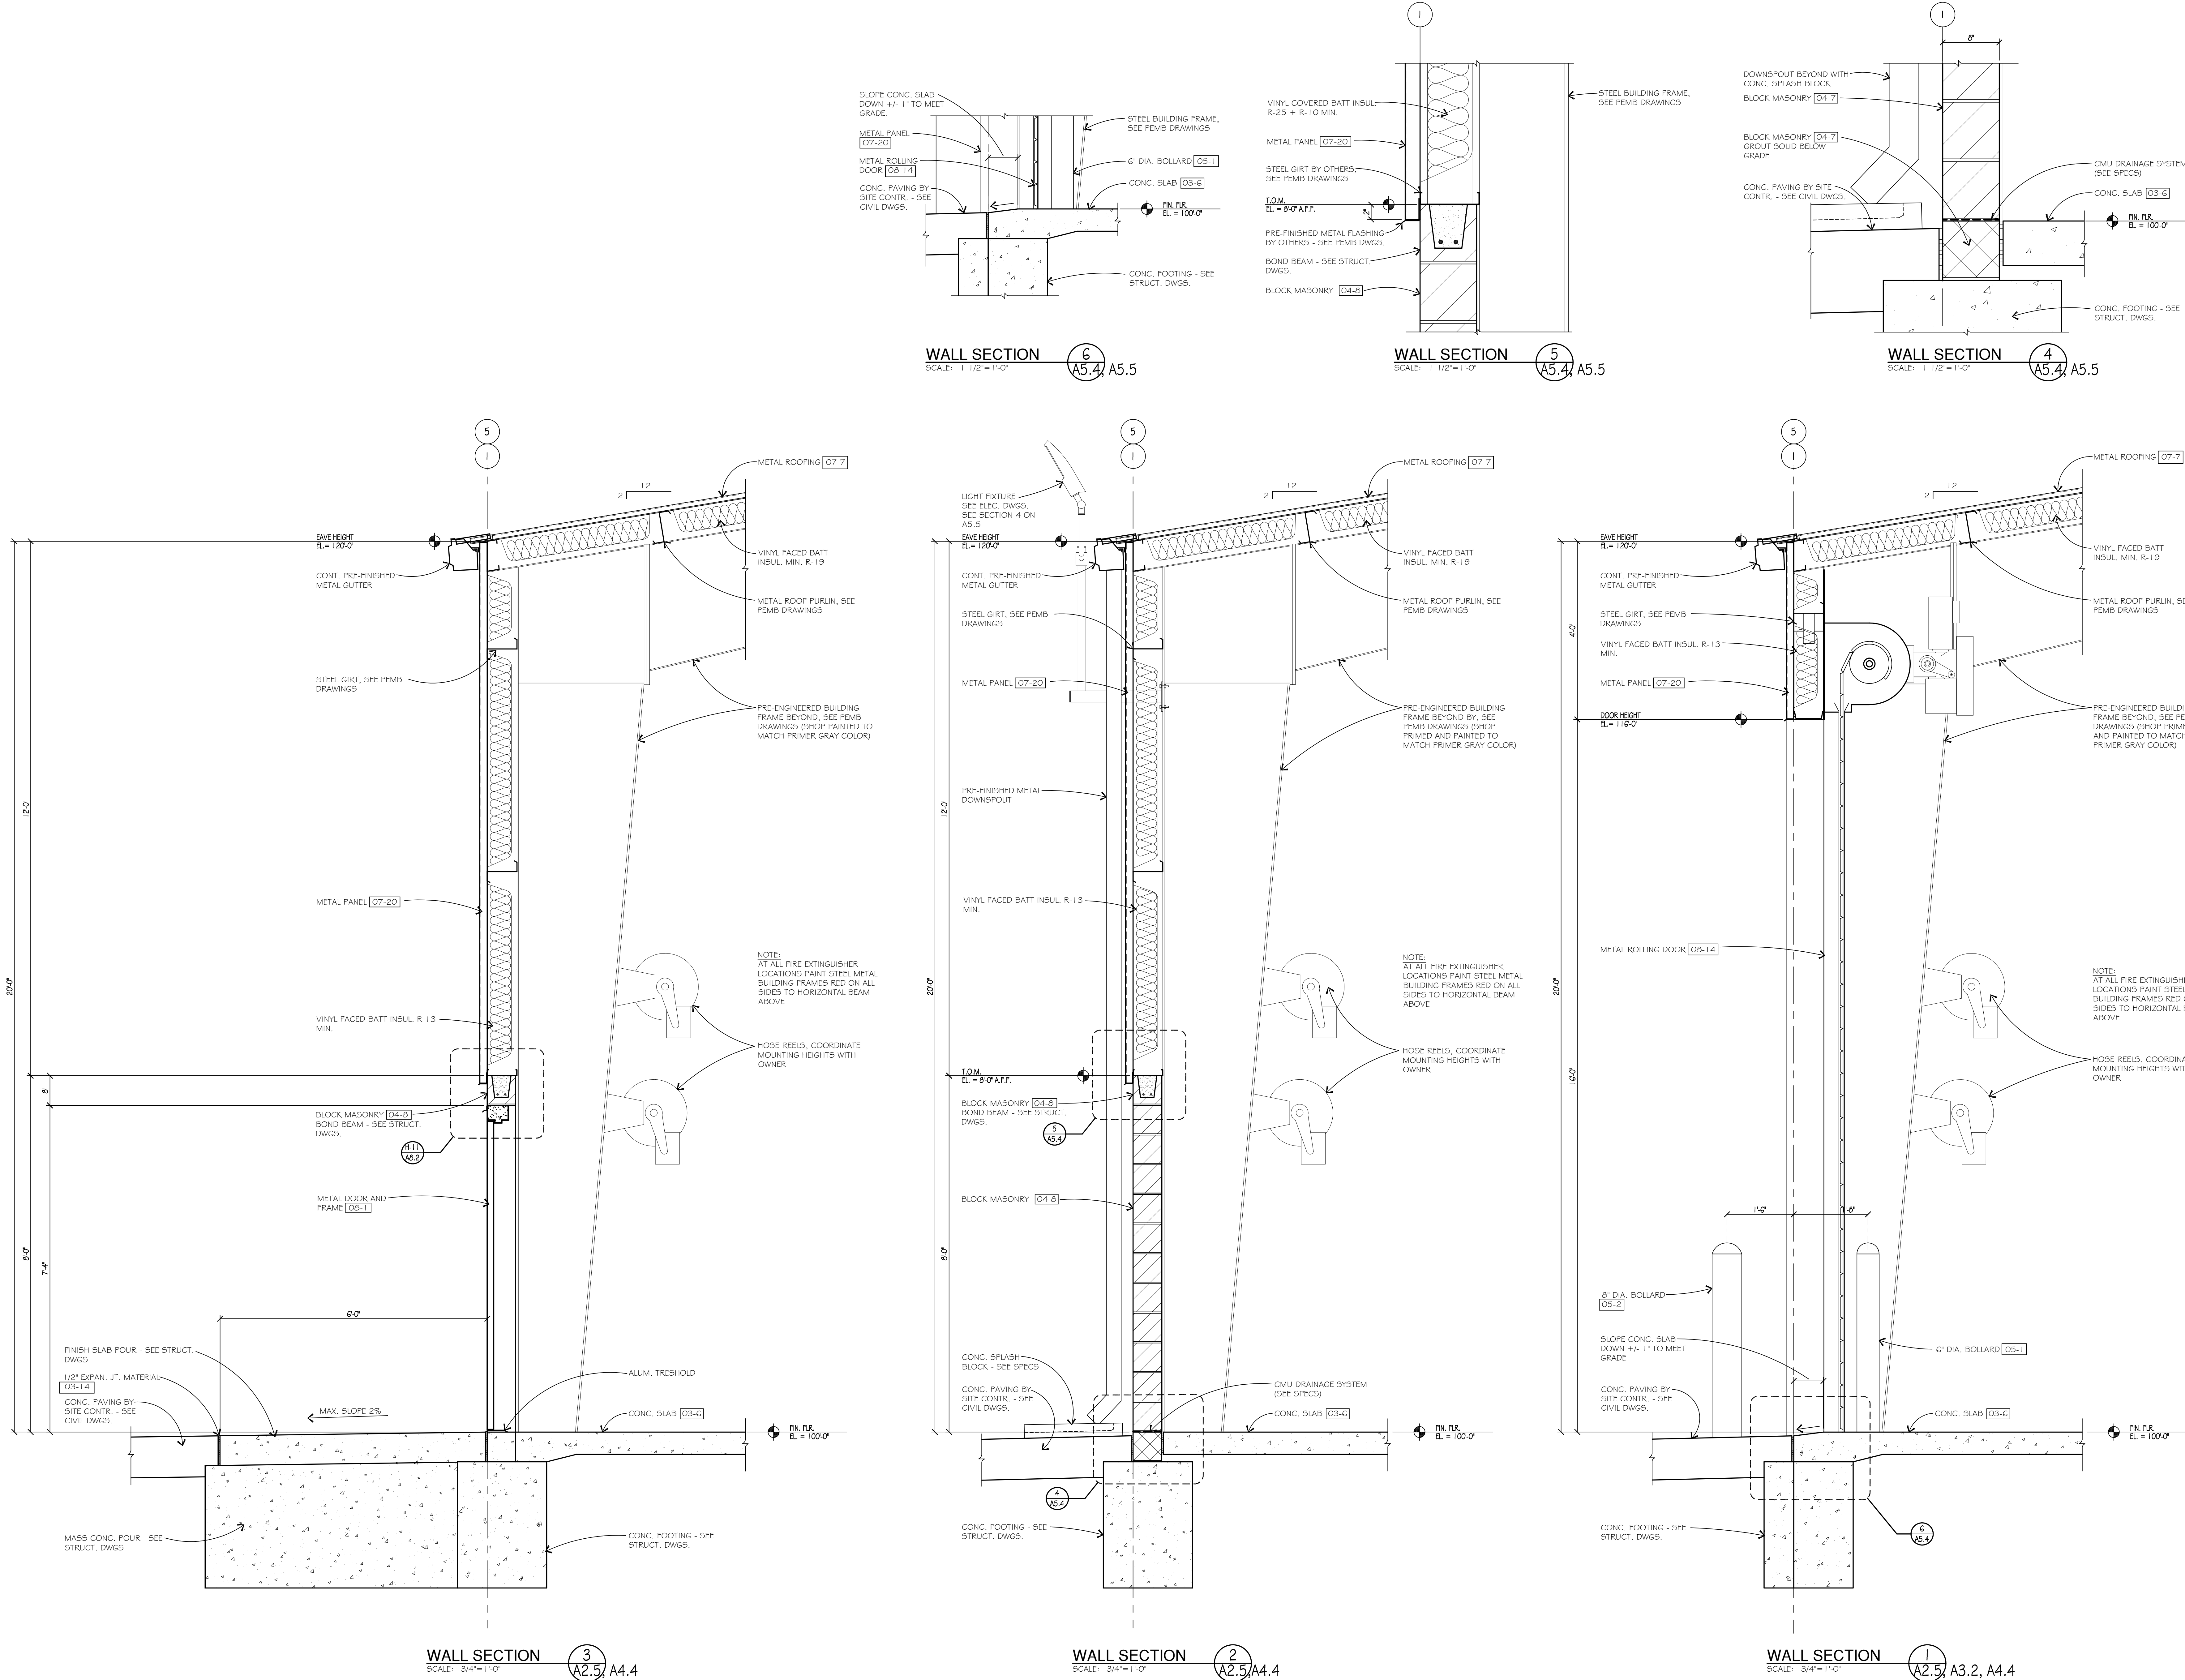

Woh Yee Associates  
Architects & Planners  
1000 GRANDVIEW AVENUE, SUITE 200  
NORTHBURG, INDIANA 46053  
PHONE 248.489.9160

PROJECT  
**R + L CARRIERS**  
EDMUNDSVILLE, INDIANA

Date Issued  
Bids & Permit Oct. 8, 2021






Job Number  
**5147**


SHEET TITLE  
**MAINTENANCE  
BUILDING 300  
WALL  
SECTIONS**

Sheet Number  
**A5.4**


Do not scale drawings - Use figured dimensions CAD DWG S14754.DWG



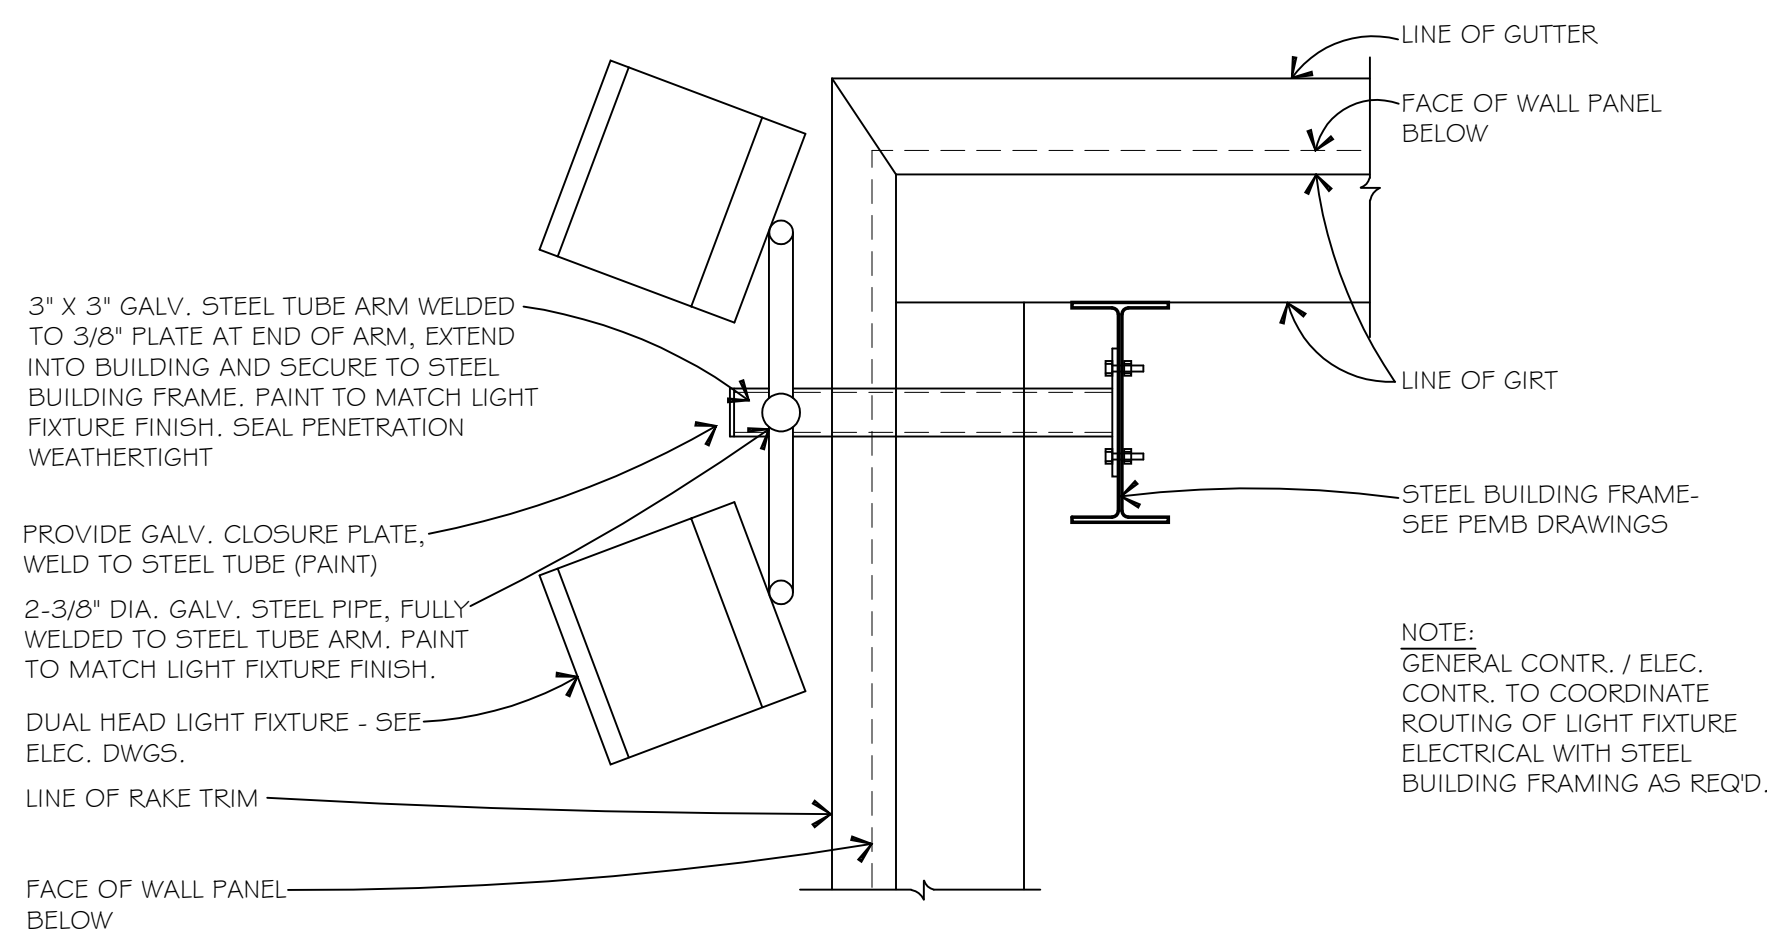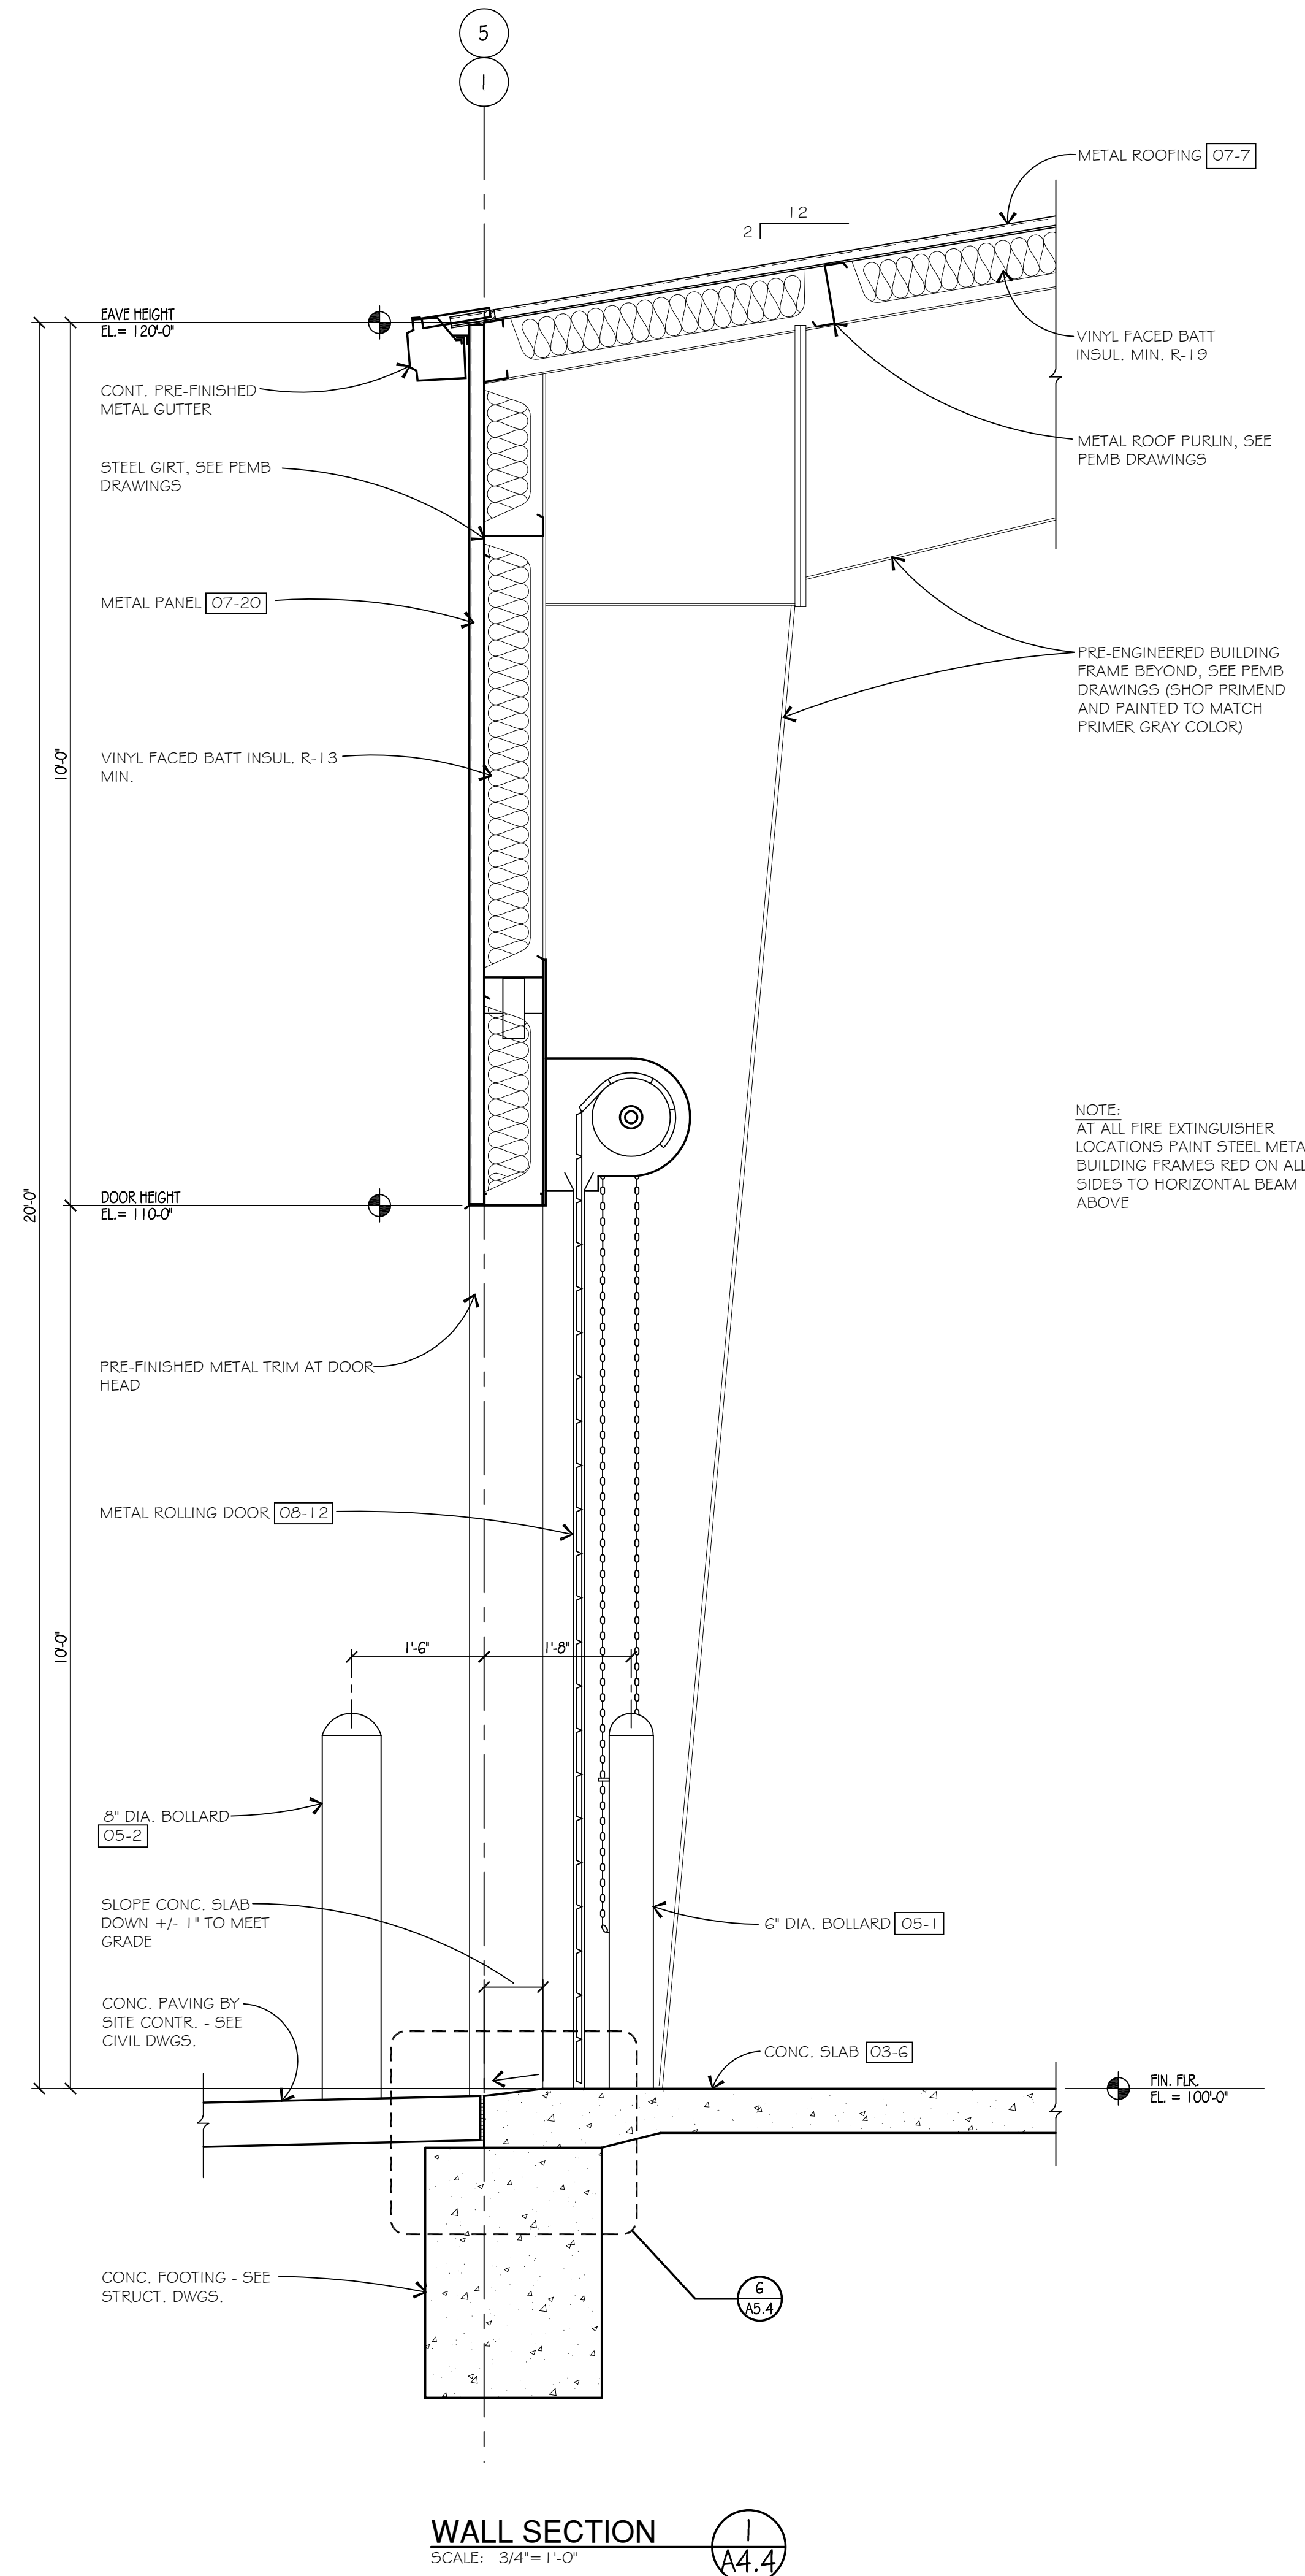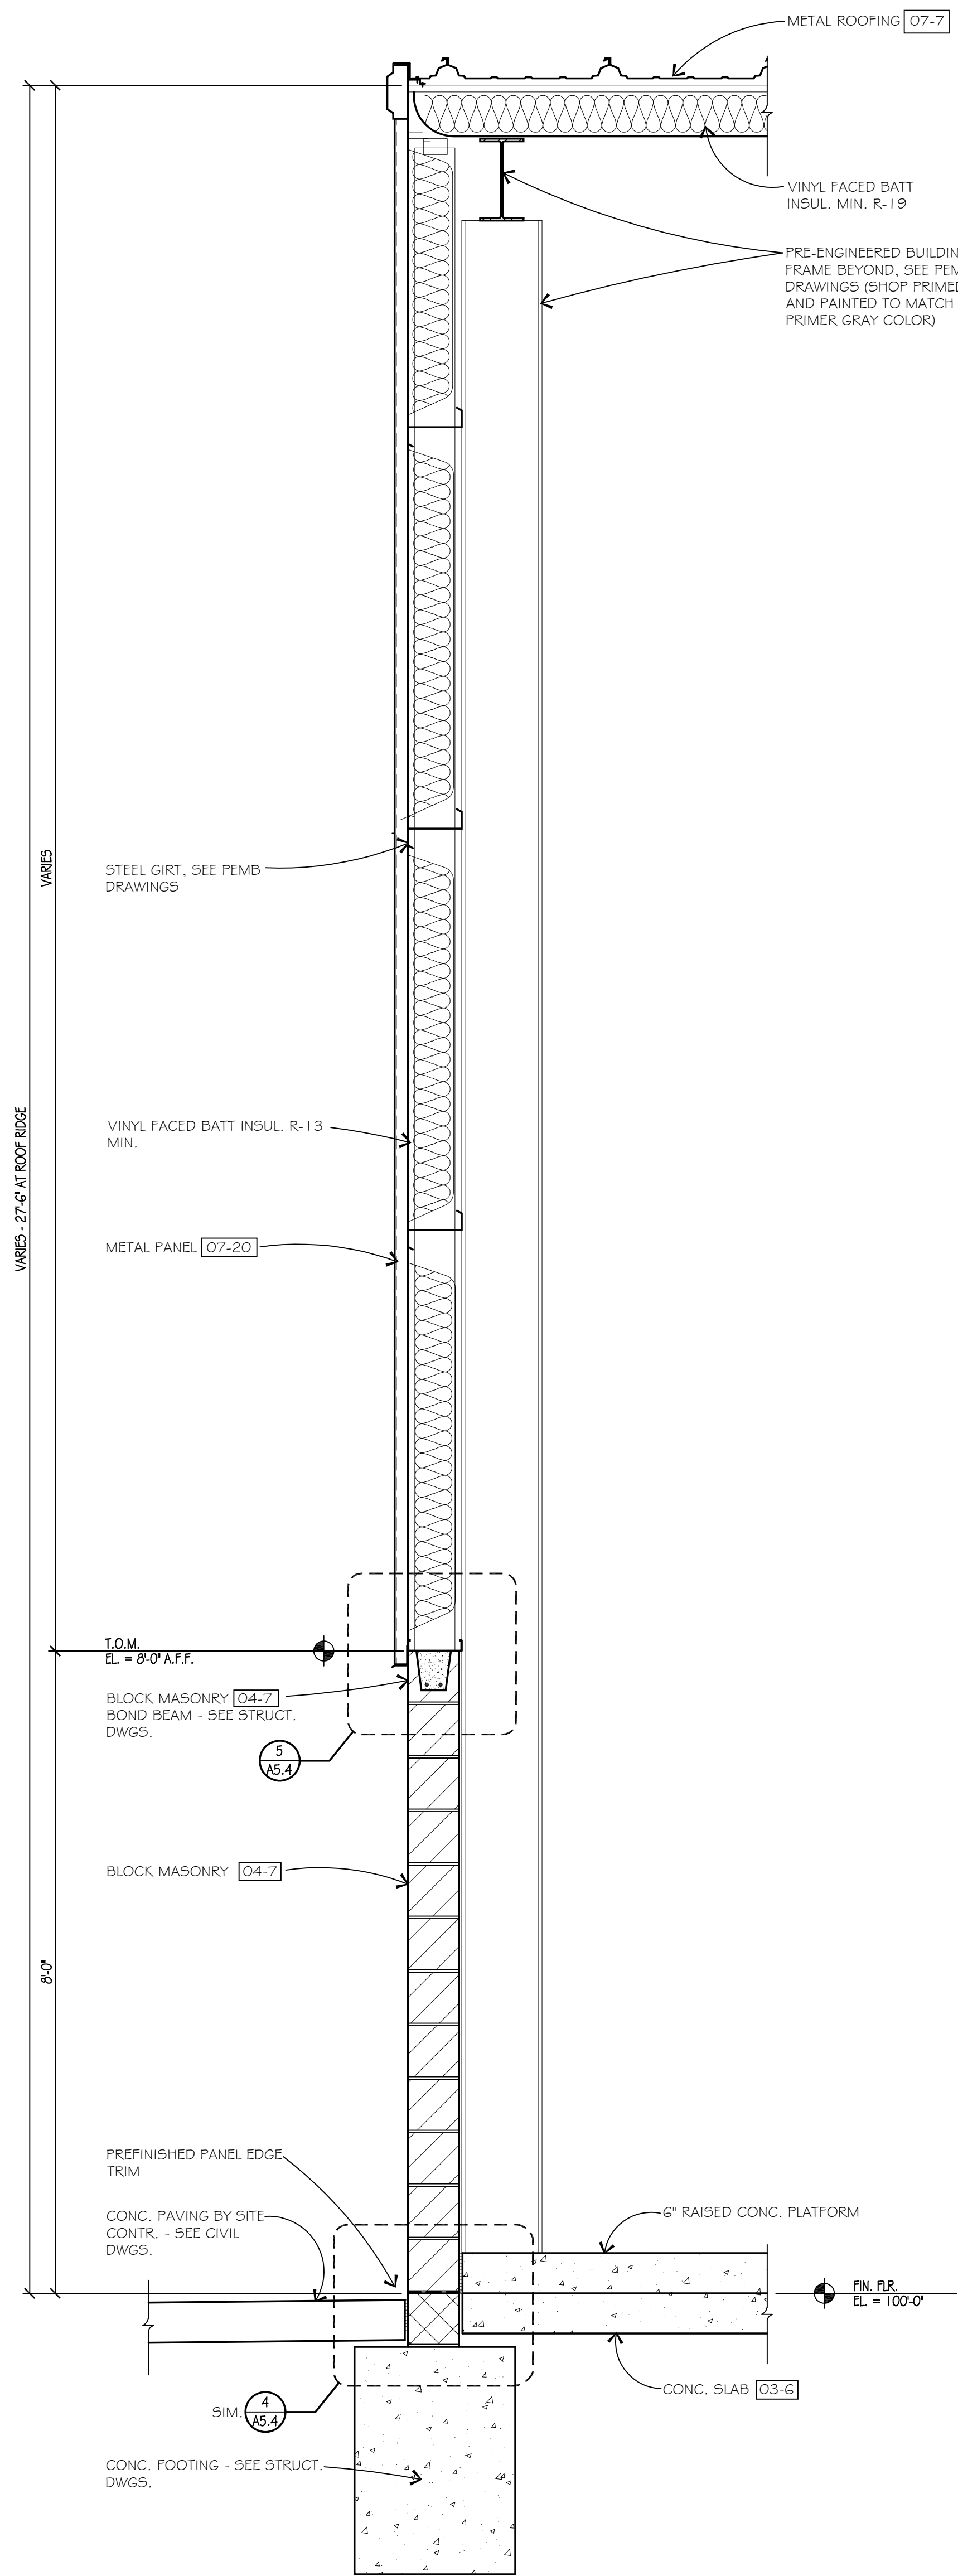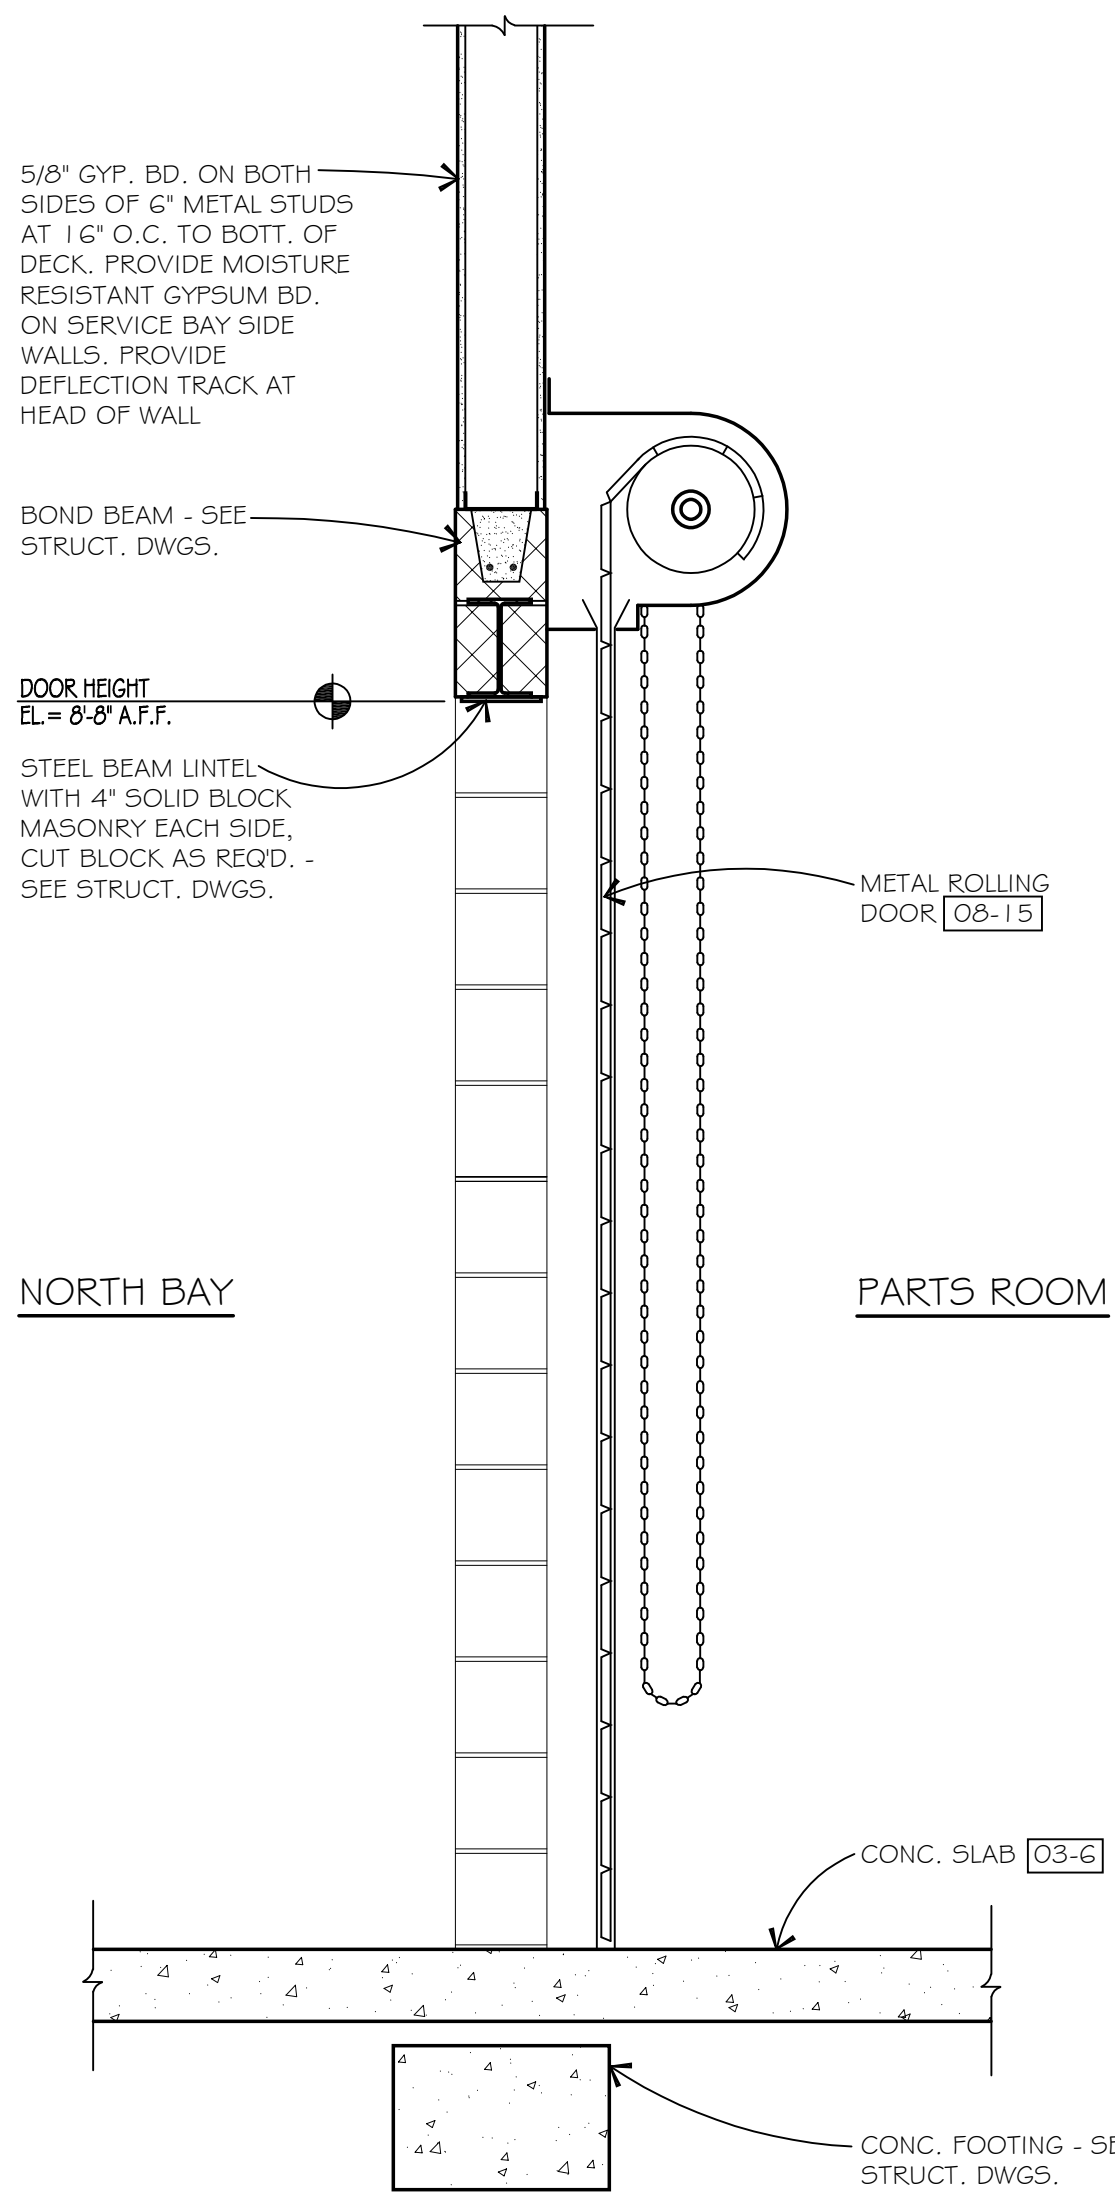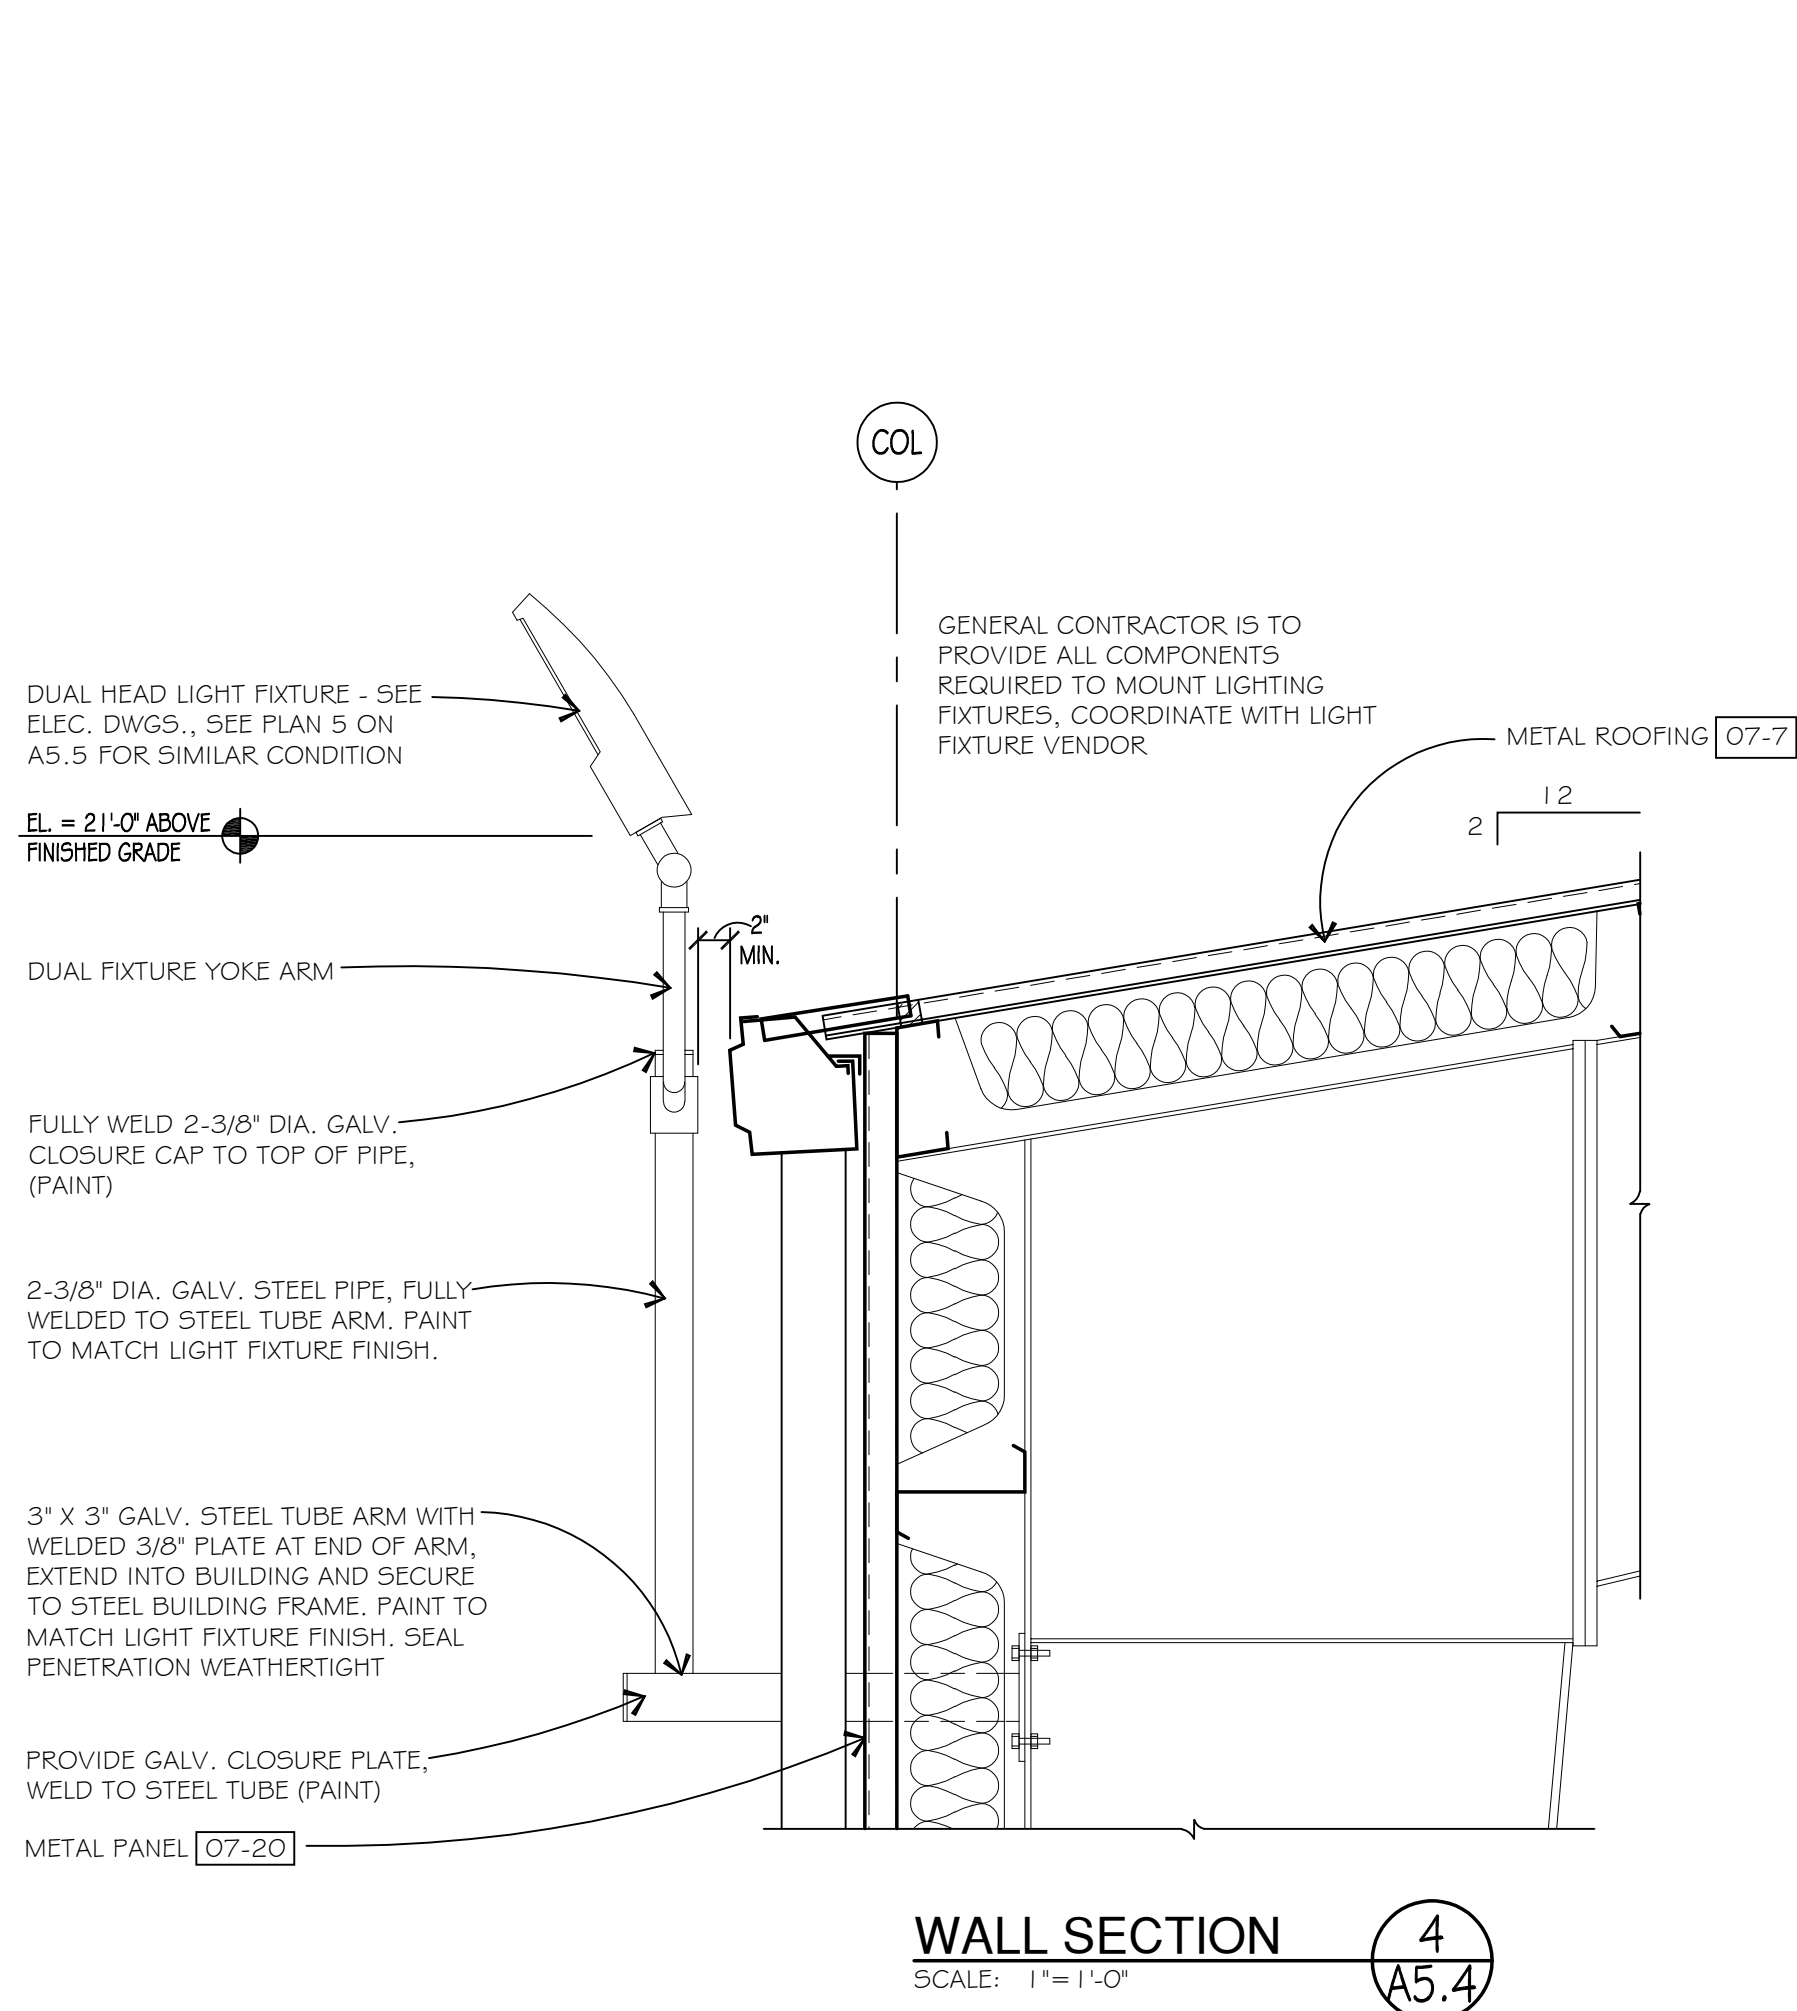


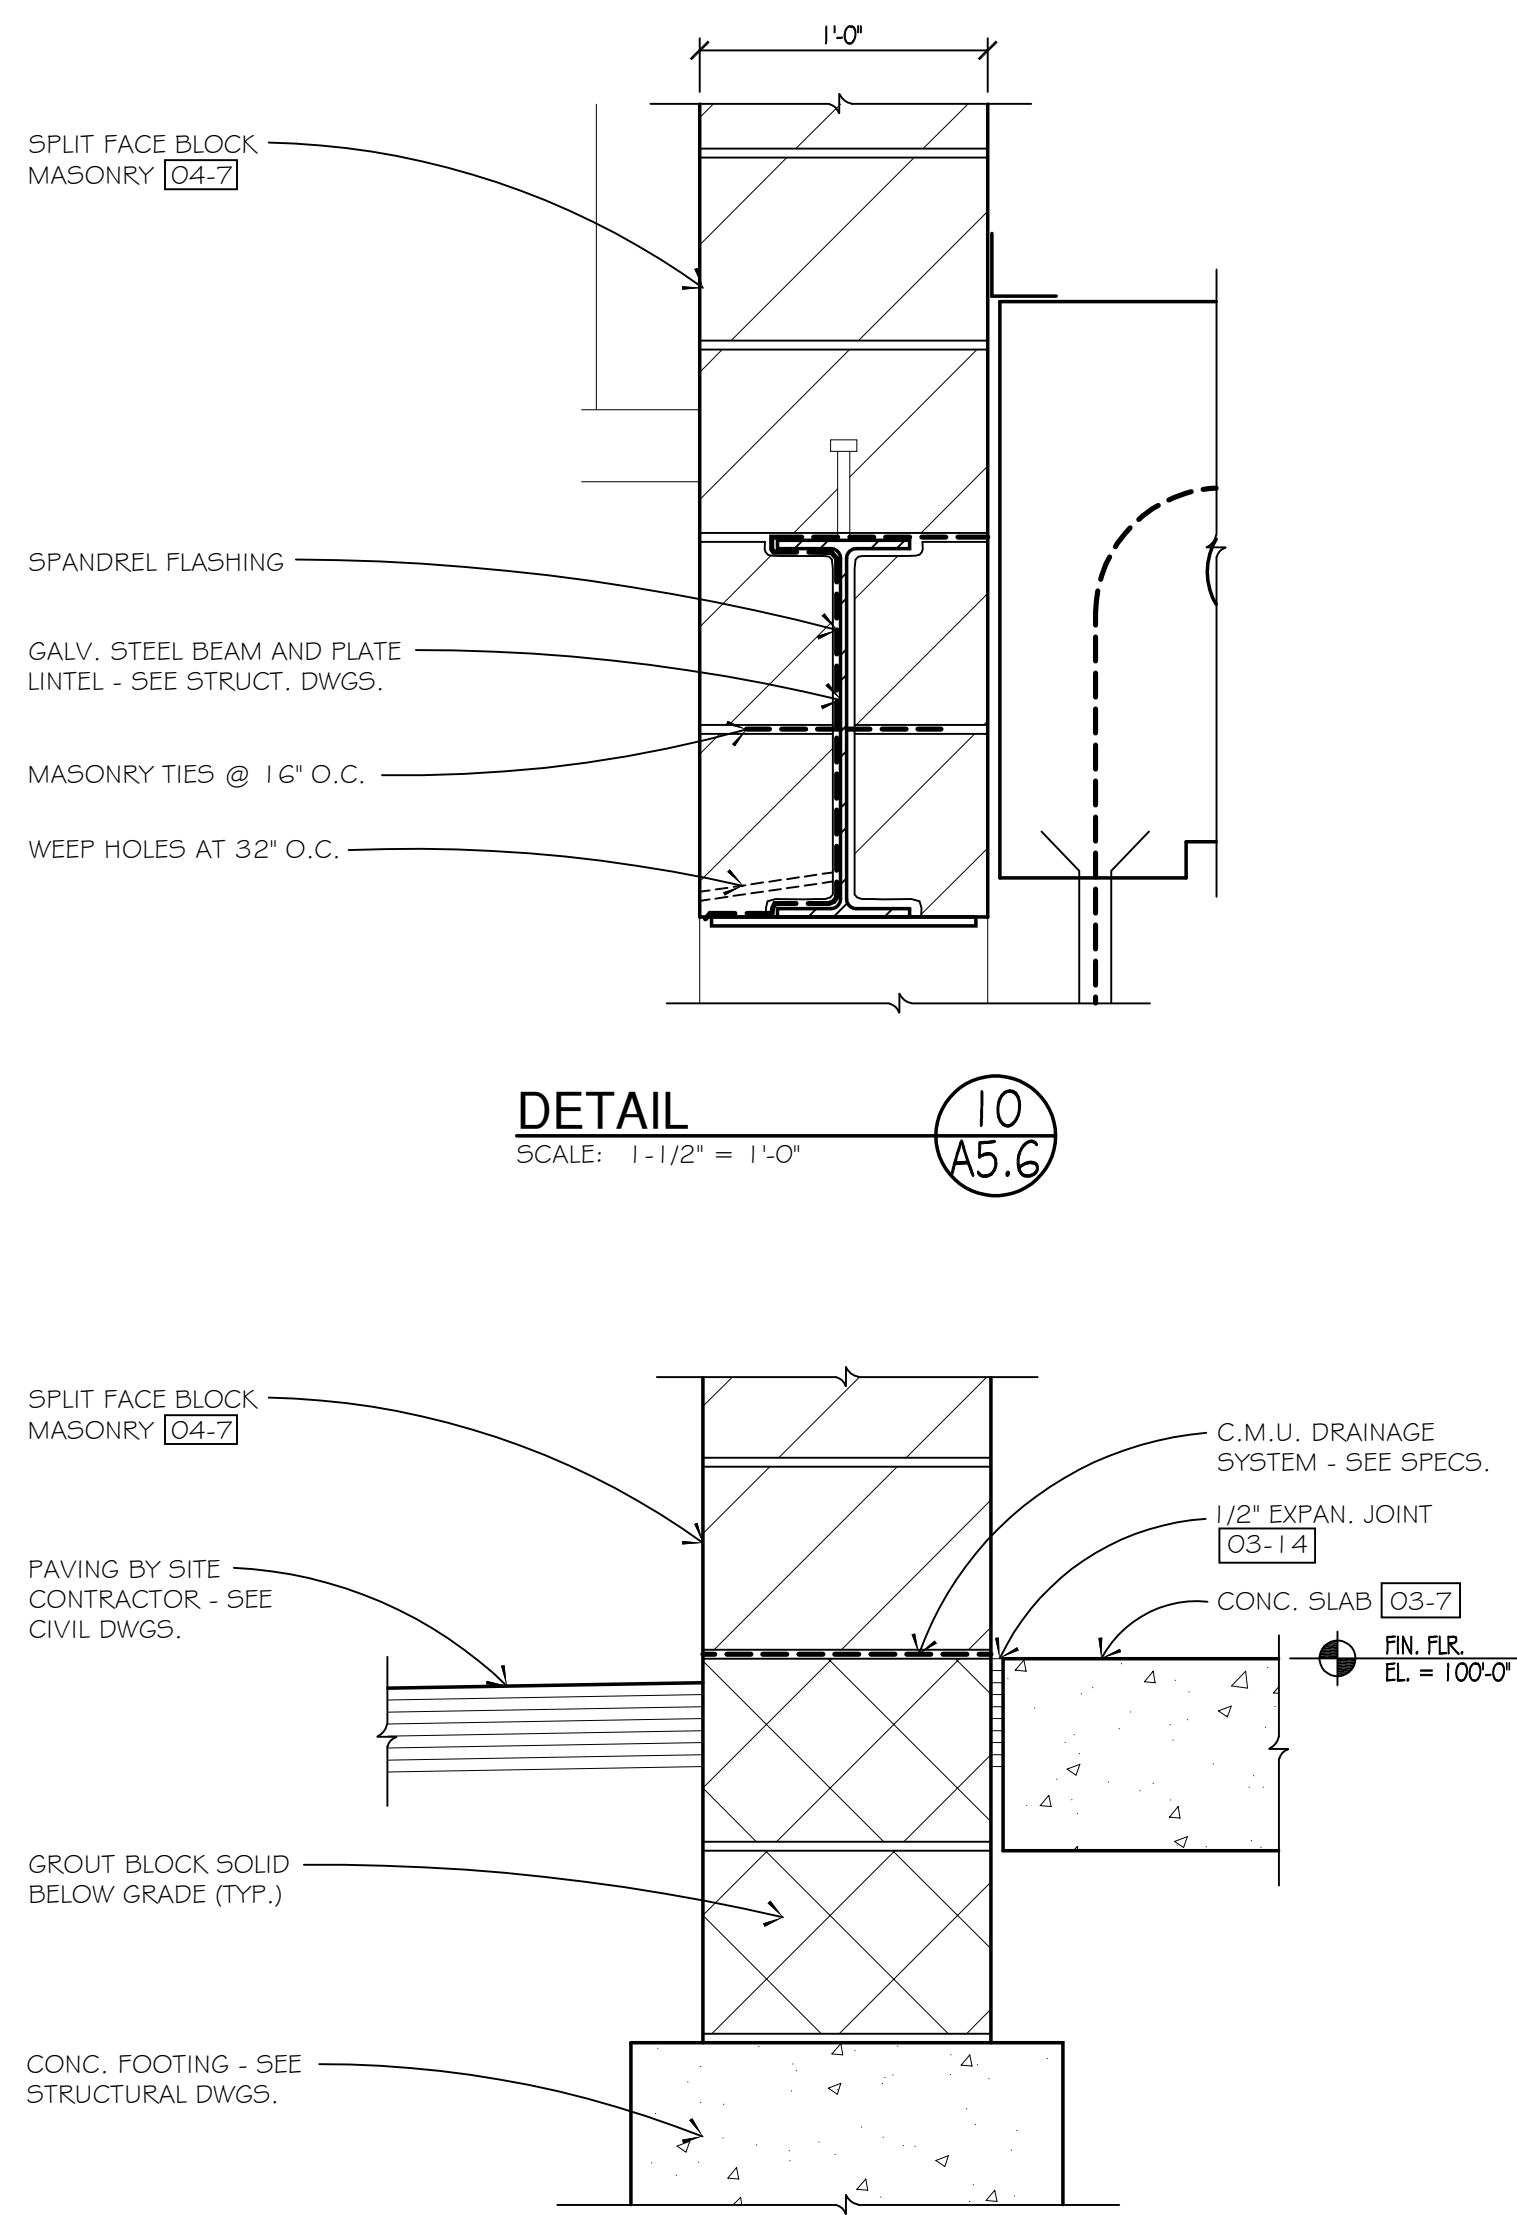


DETAIL 10  
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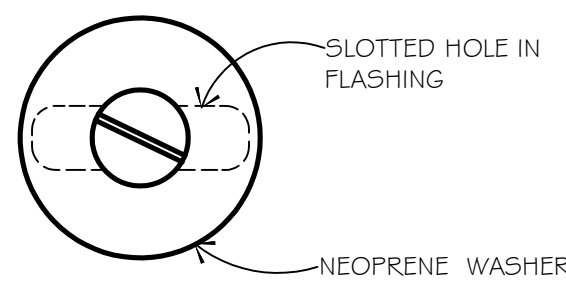
DETAIL 9  
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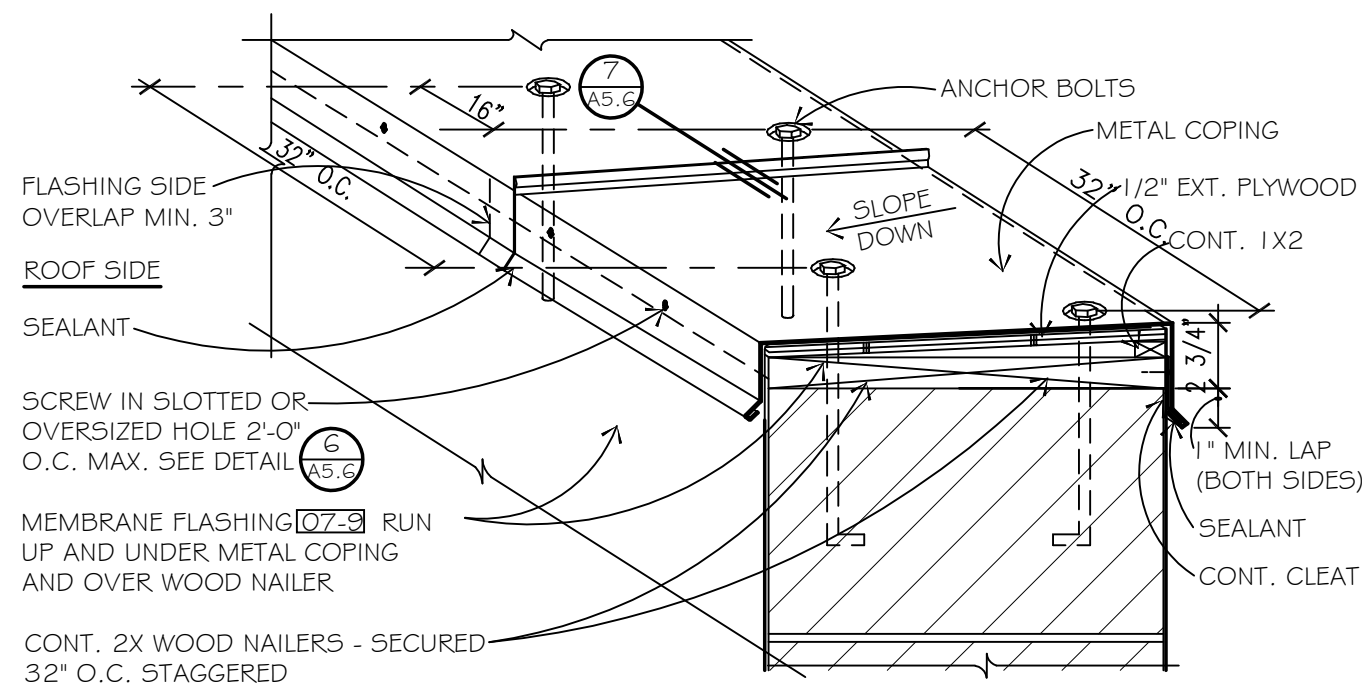
DETAIL 8  
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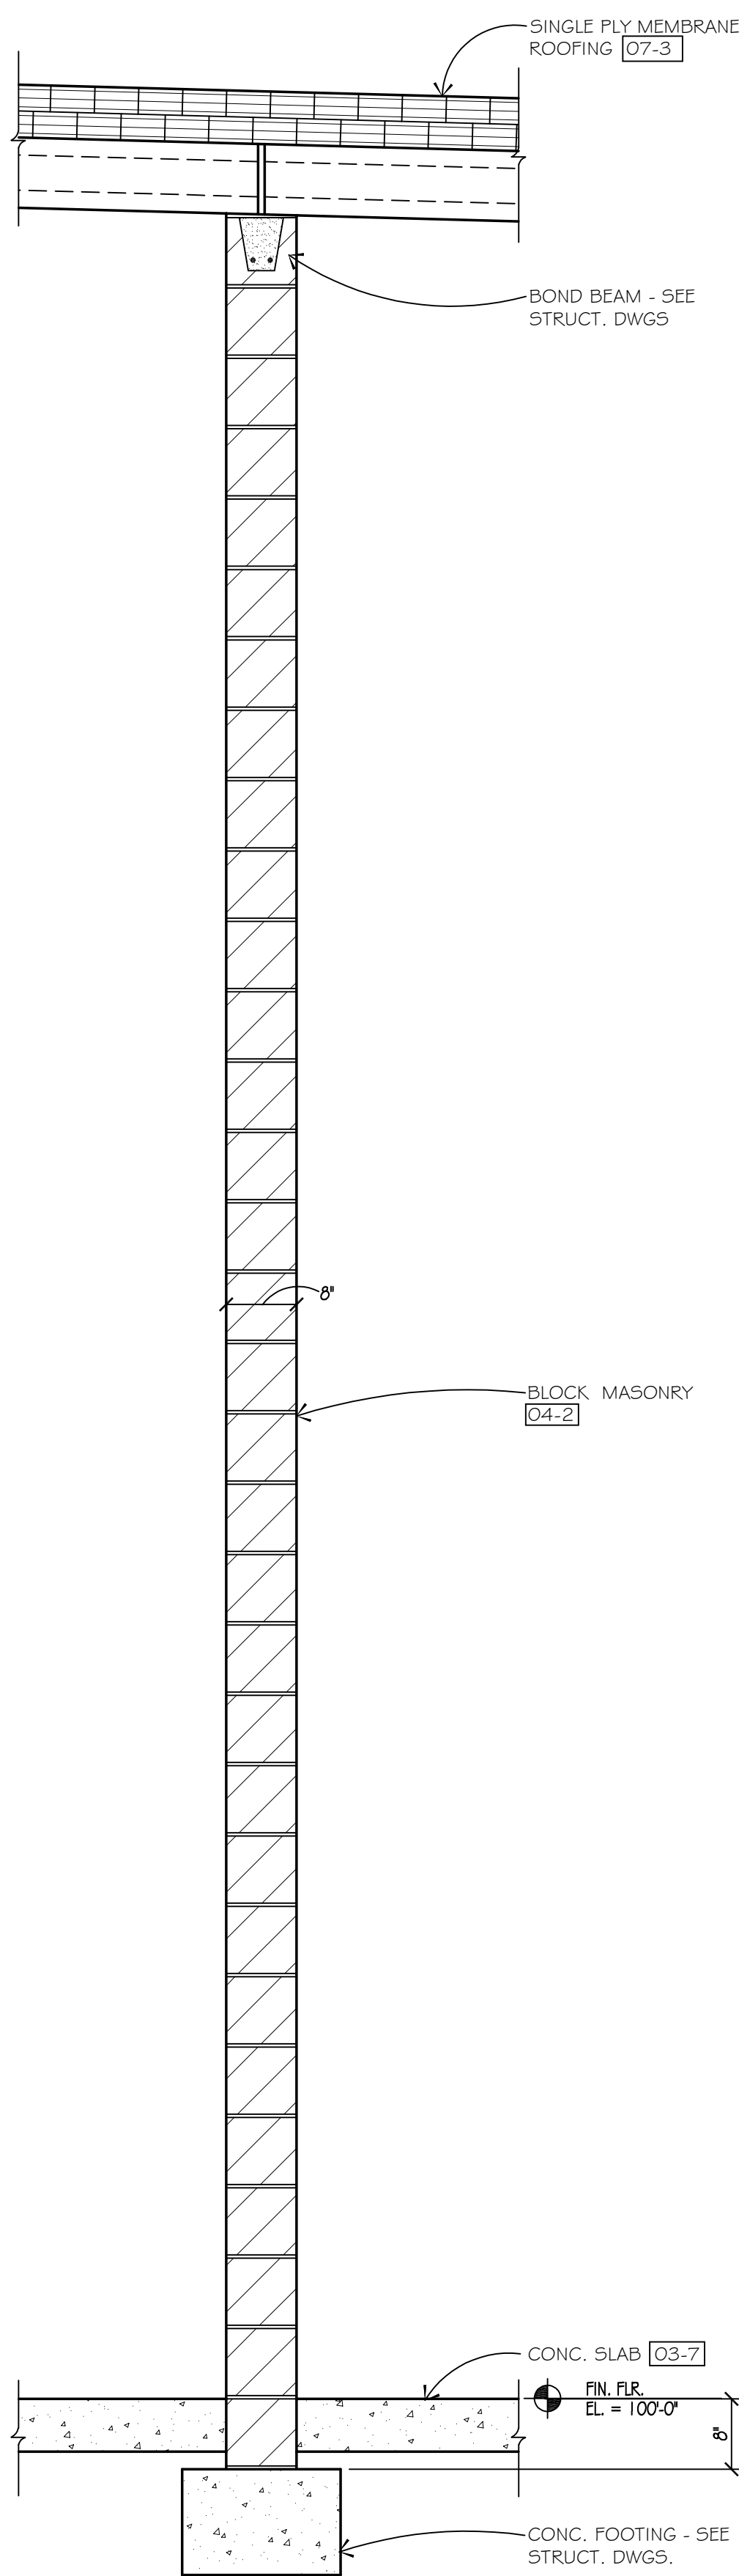
DETAIL 7  
SCALE: FULL

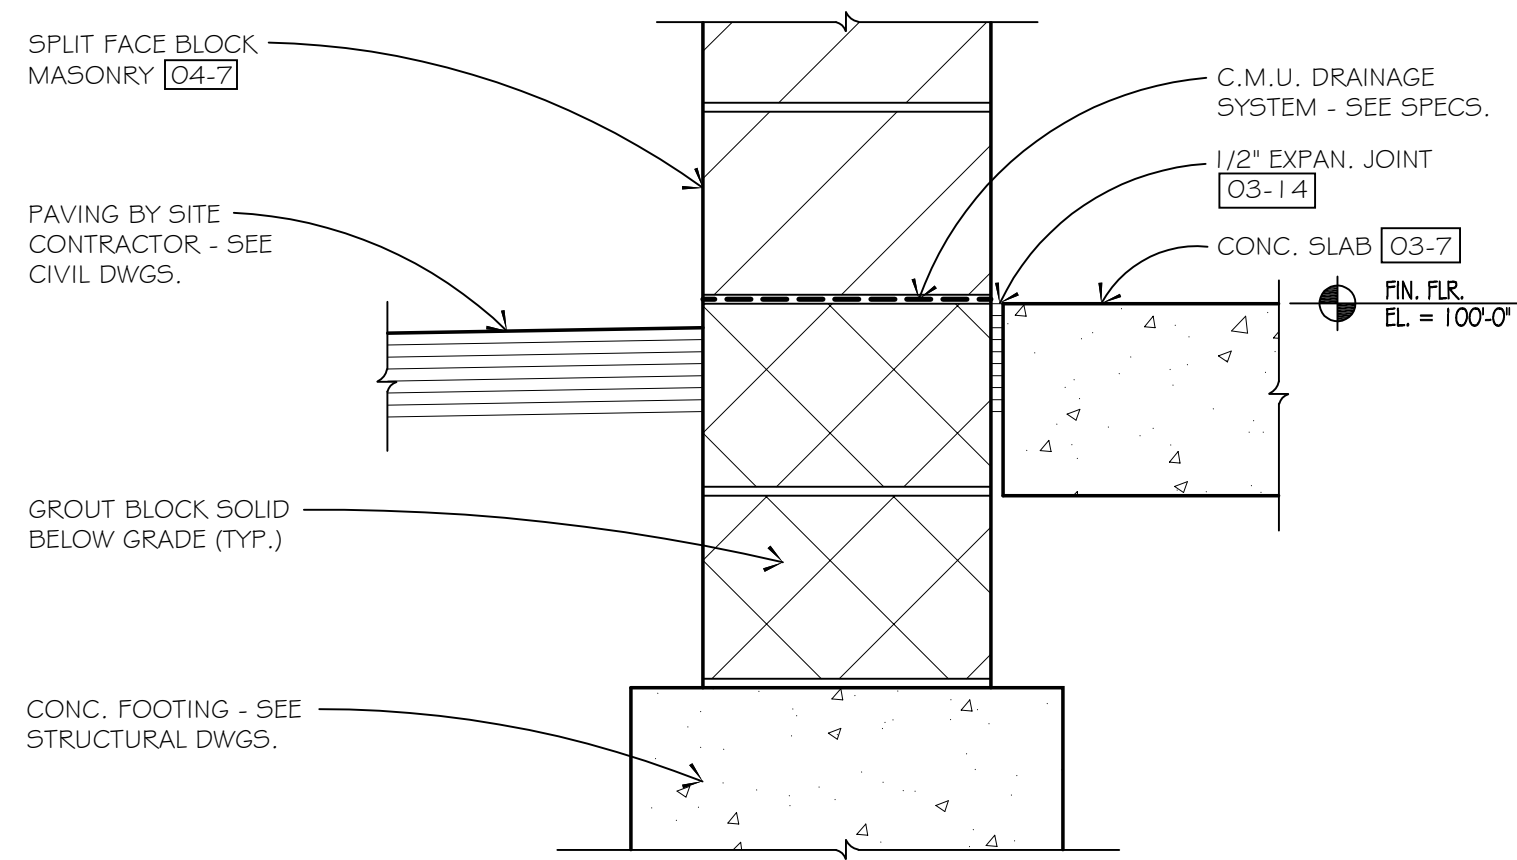


DETAIL 6  
SCALE: FULL

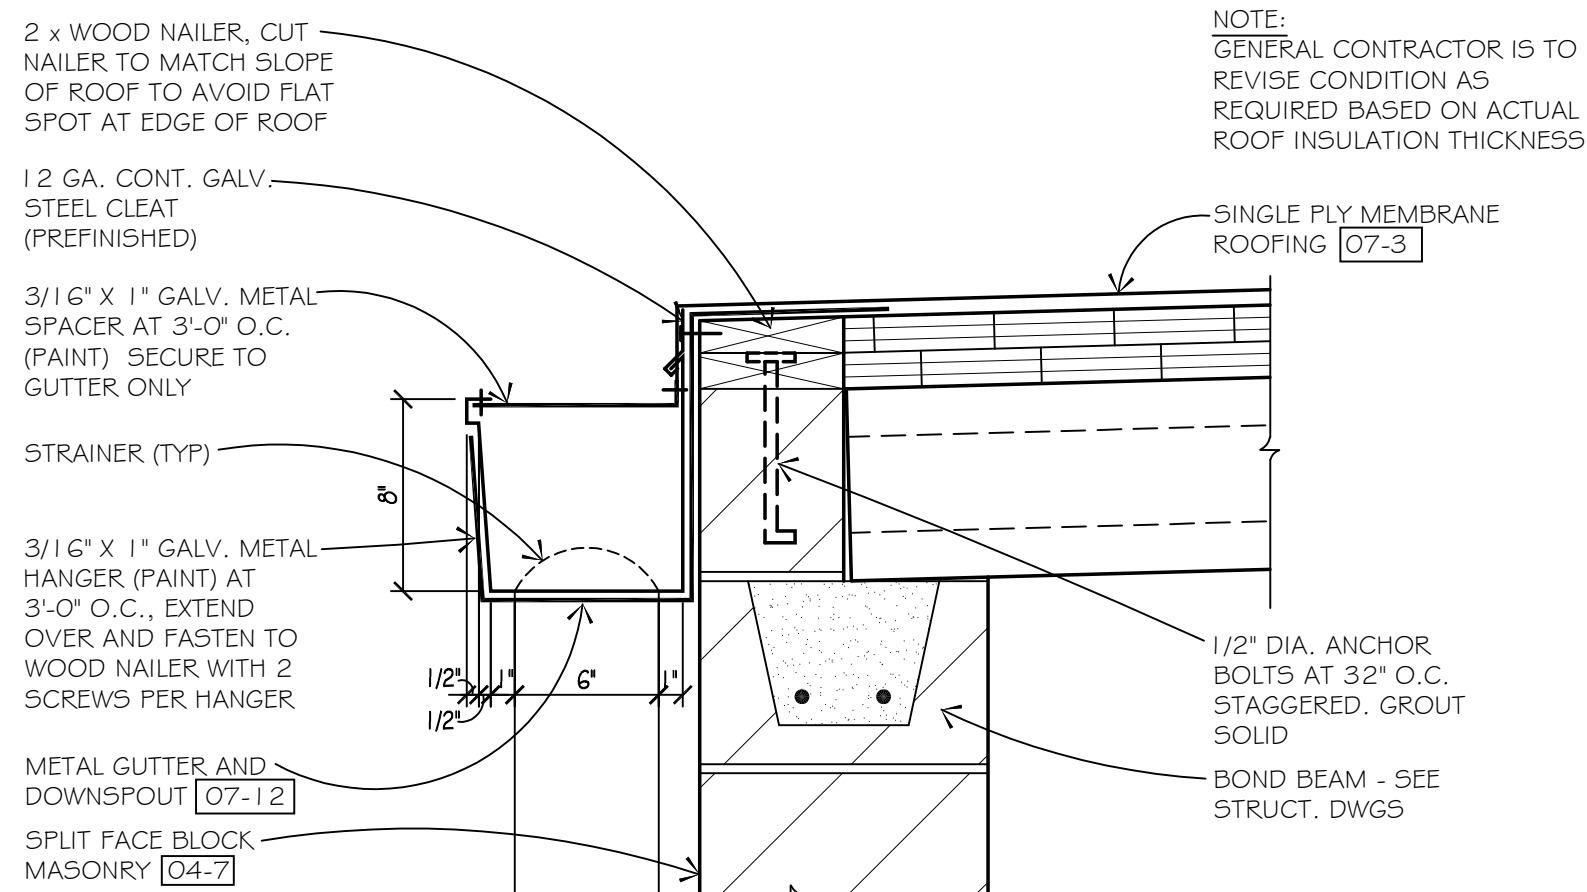


WALL SECTION 5  
SCALE: 1 1/2\"/>

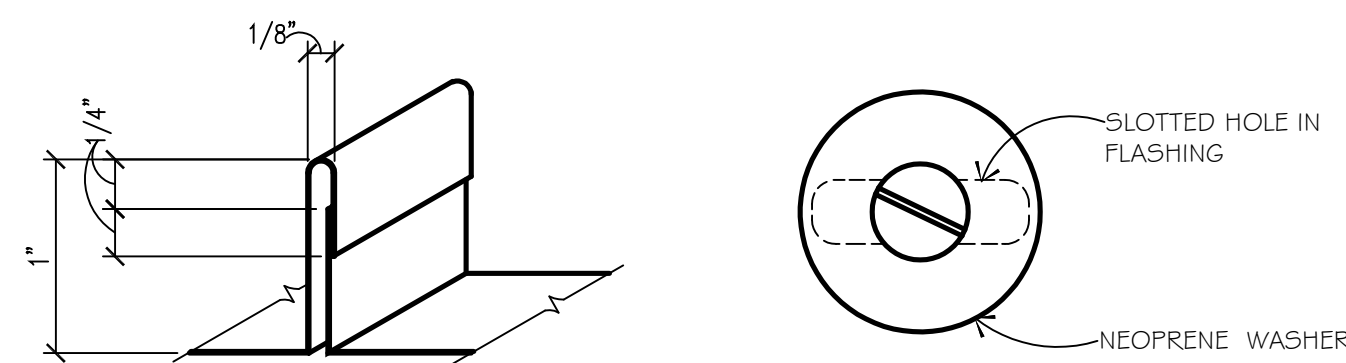


WALL SECTION 4  
SCALE: 3/4\"/>

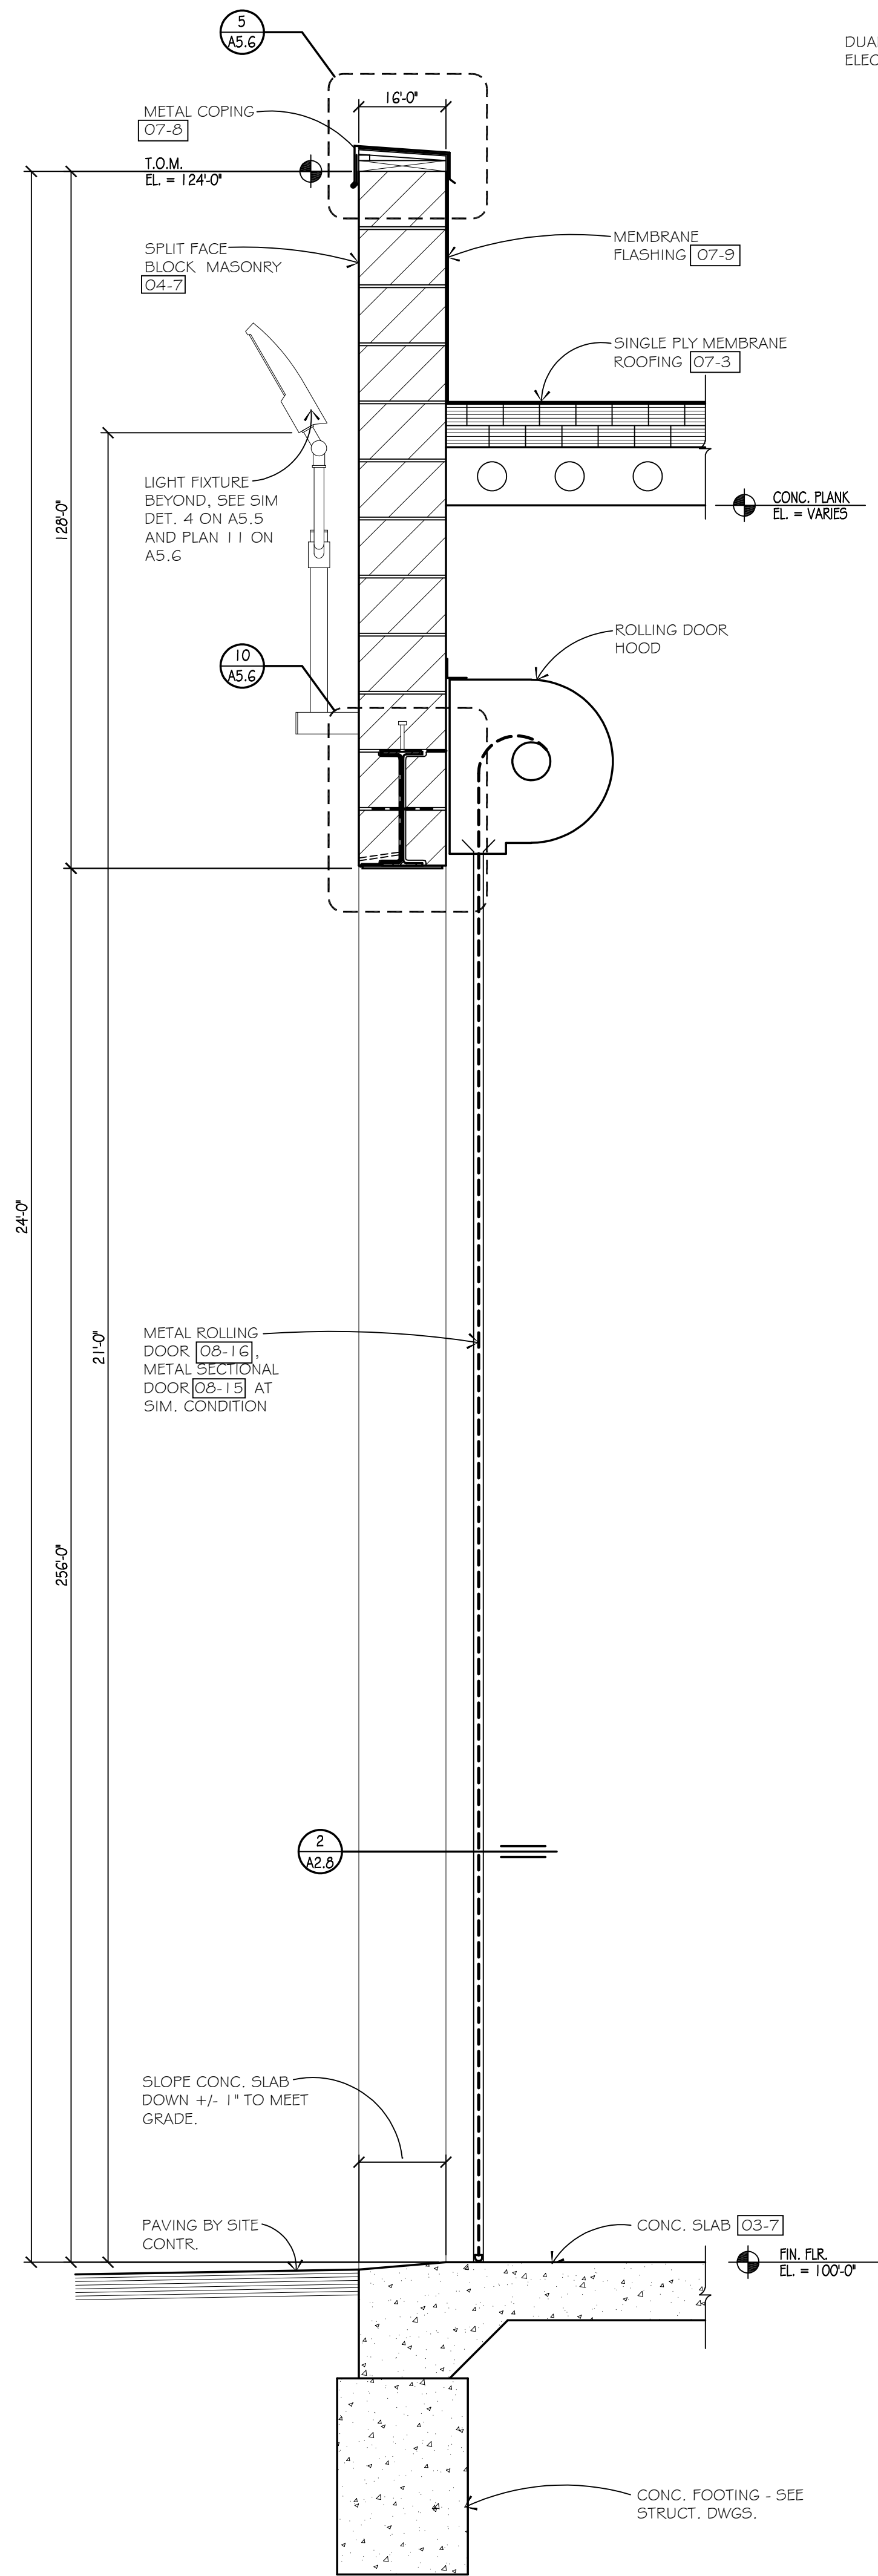

WALL SECTION 3  
SCALE: 3/4\"/>








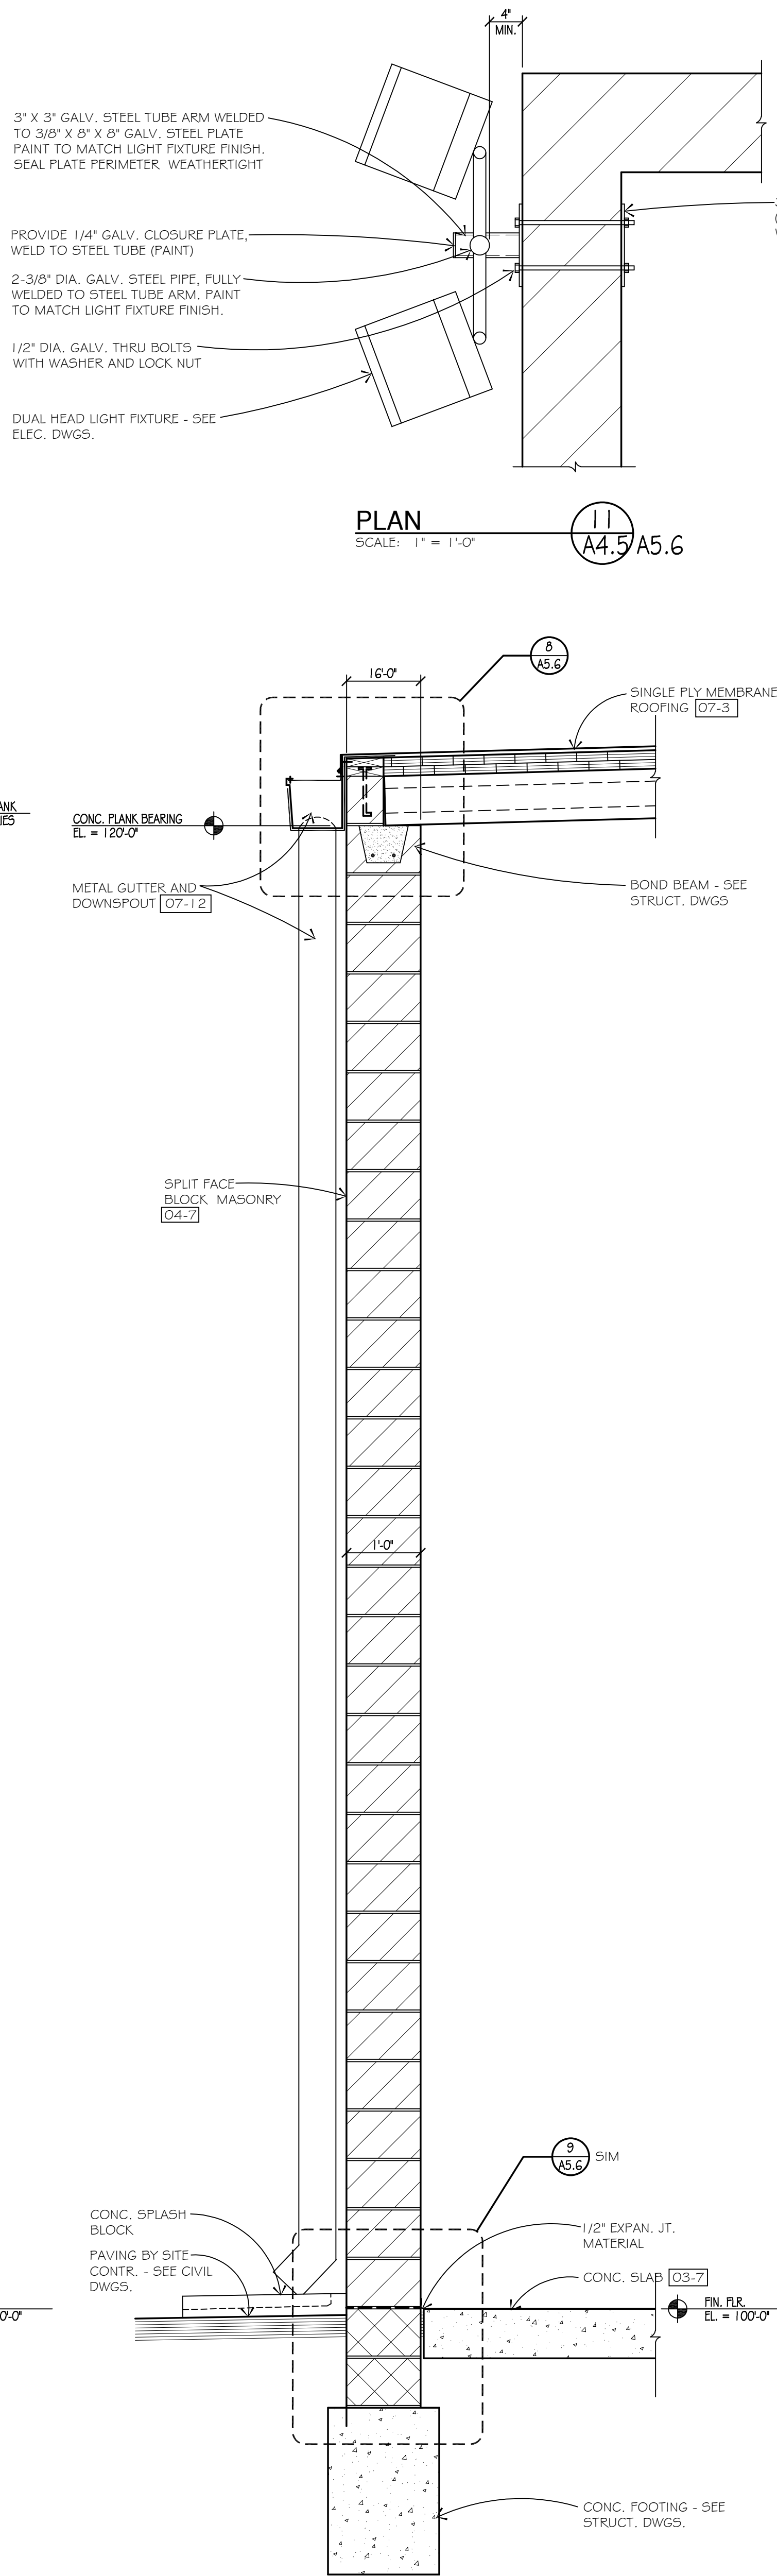


WALL SECTION 2  
SCALE: 3/4\"/>

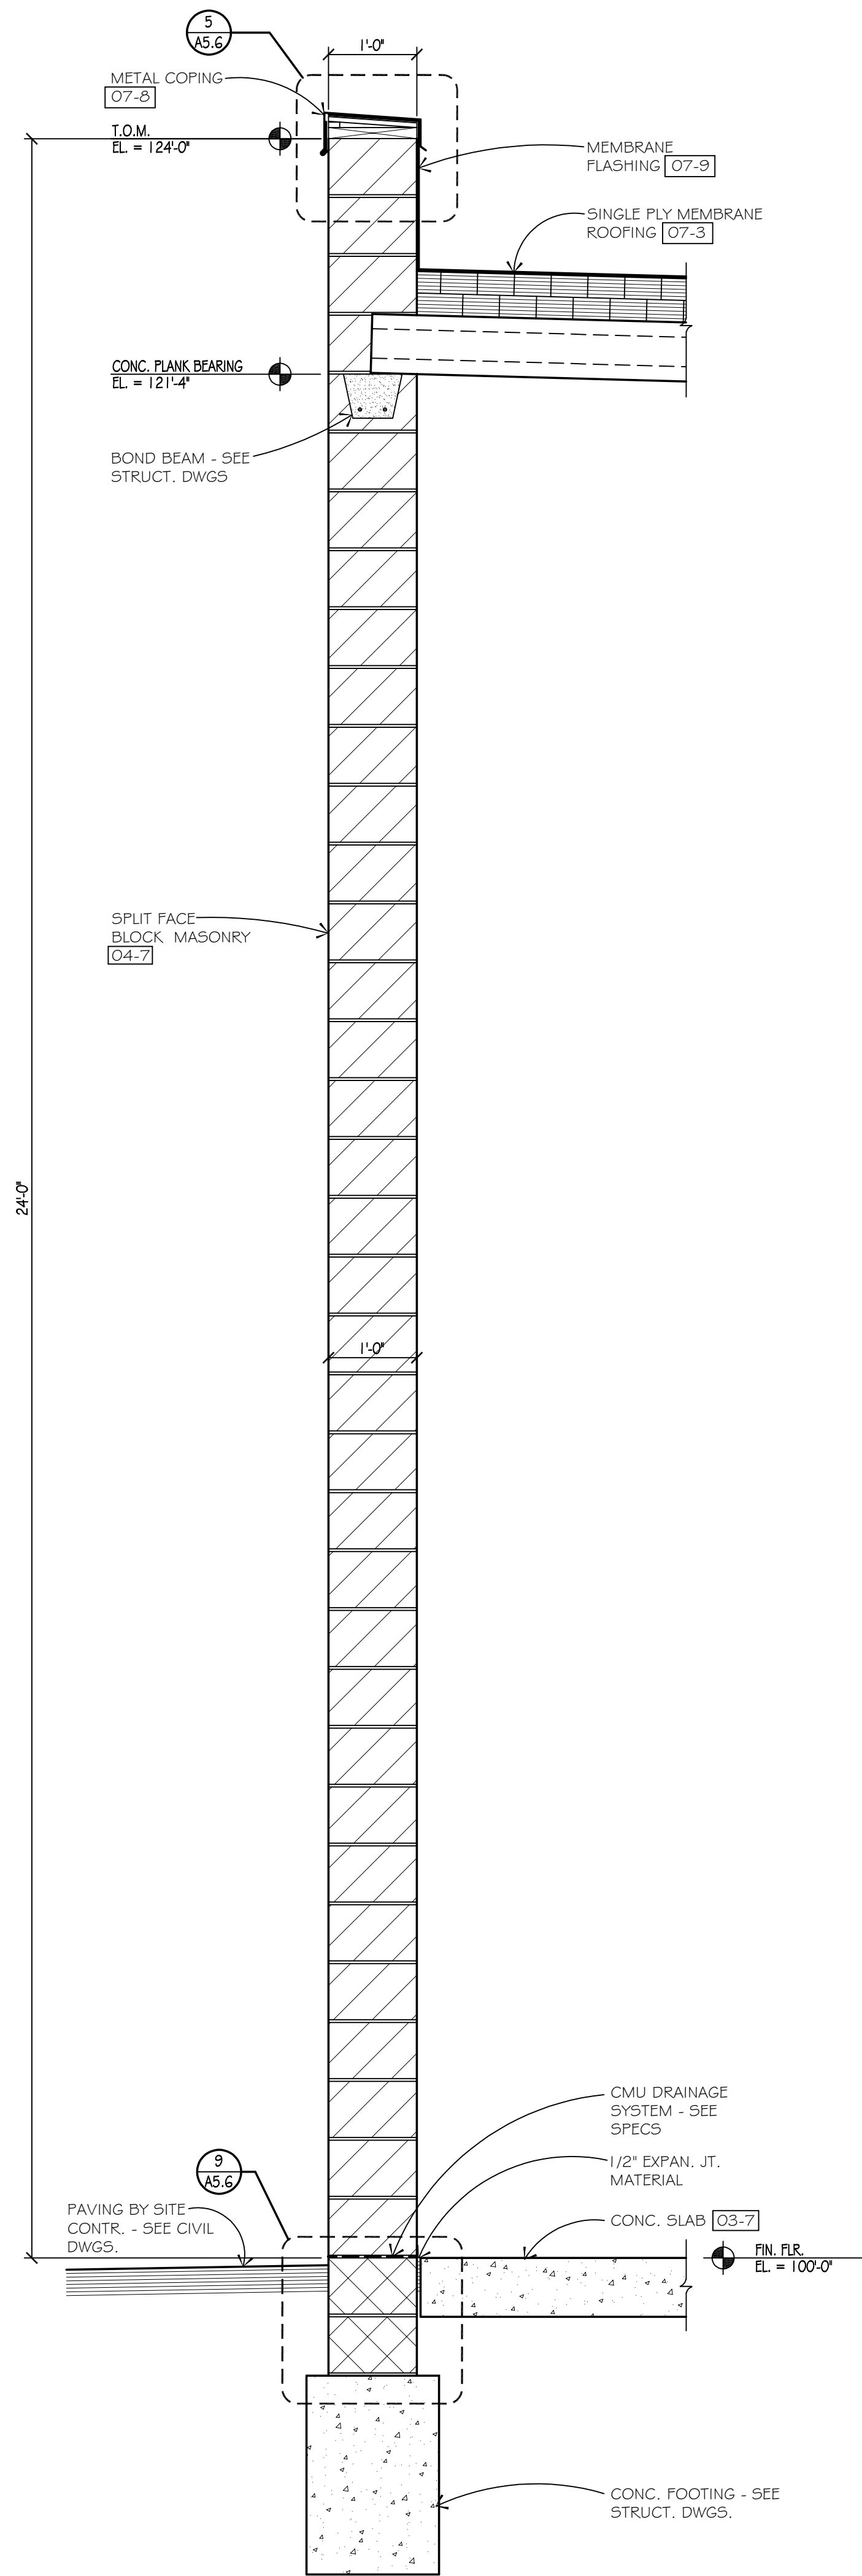

WALL SECTION 1  
SCALE: 3/4\"/>




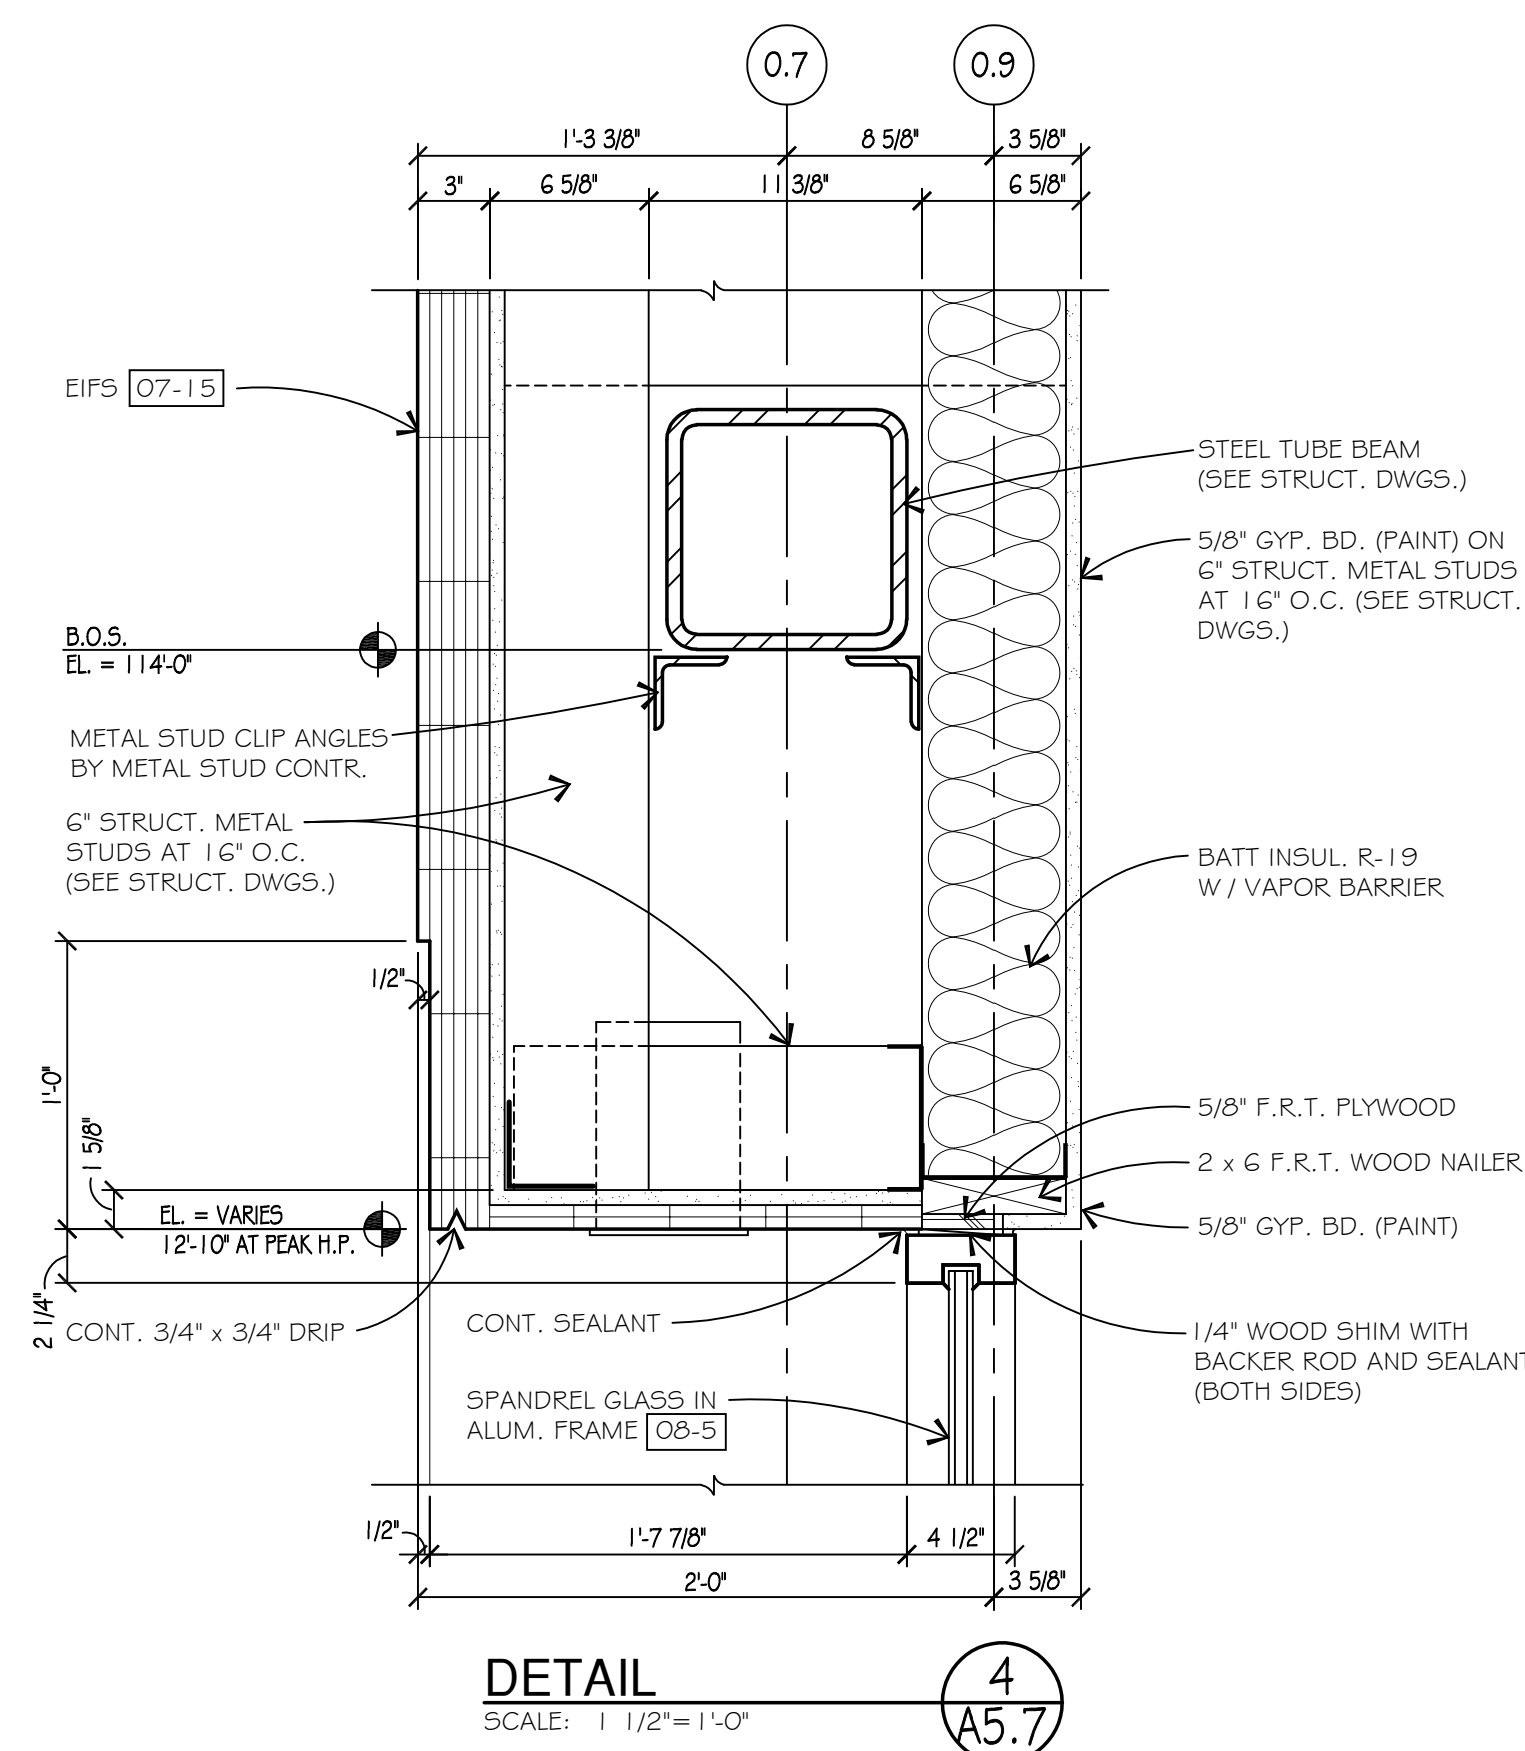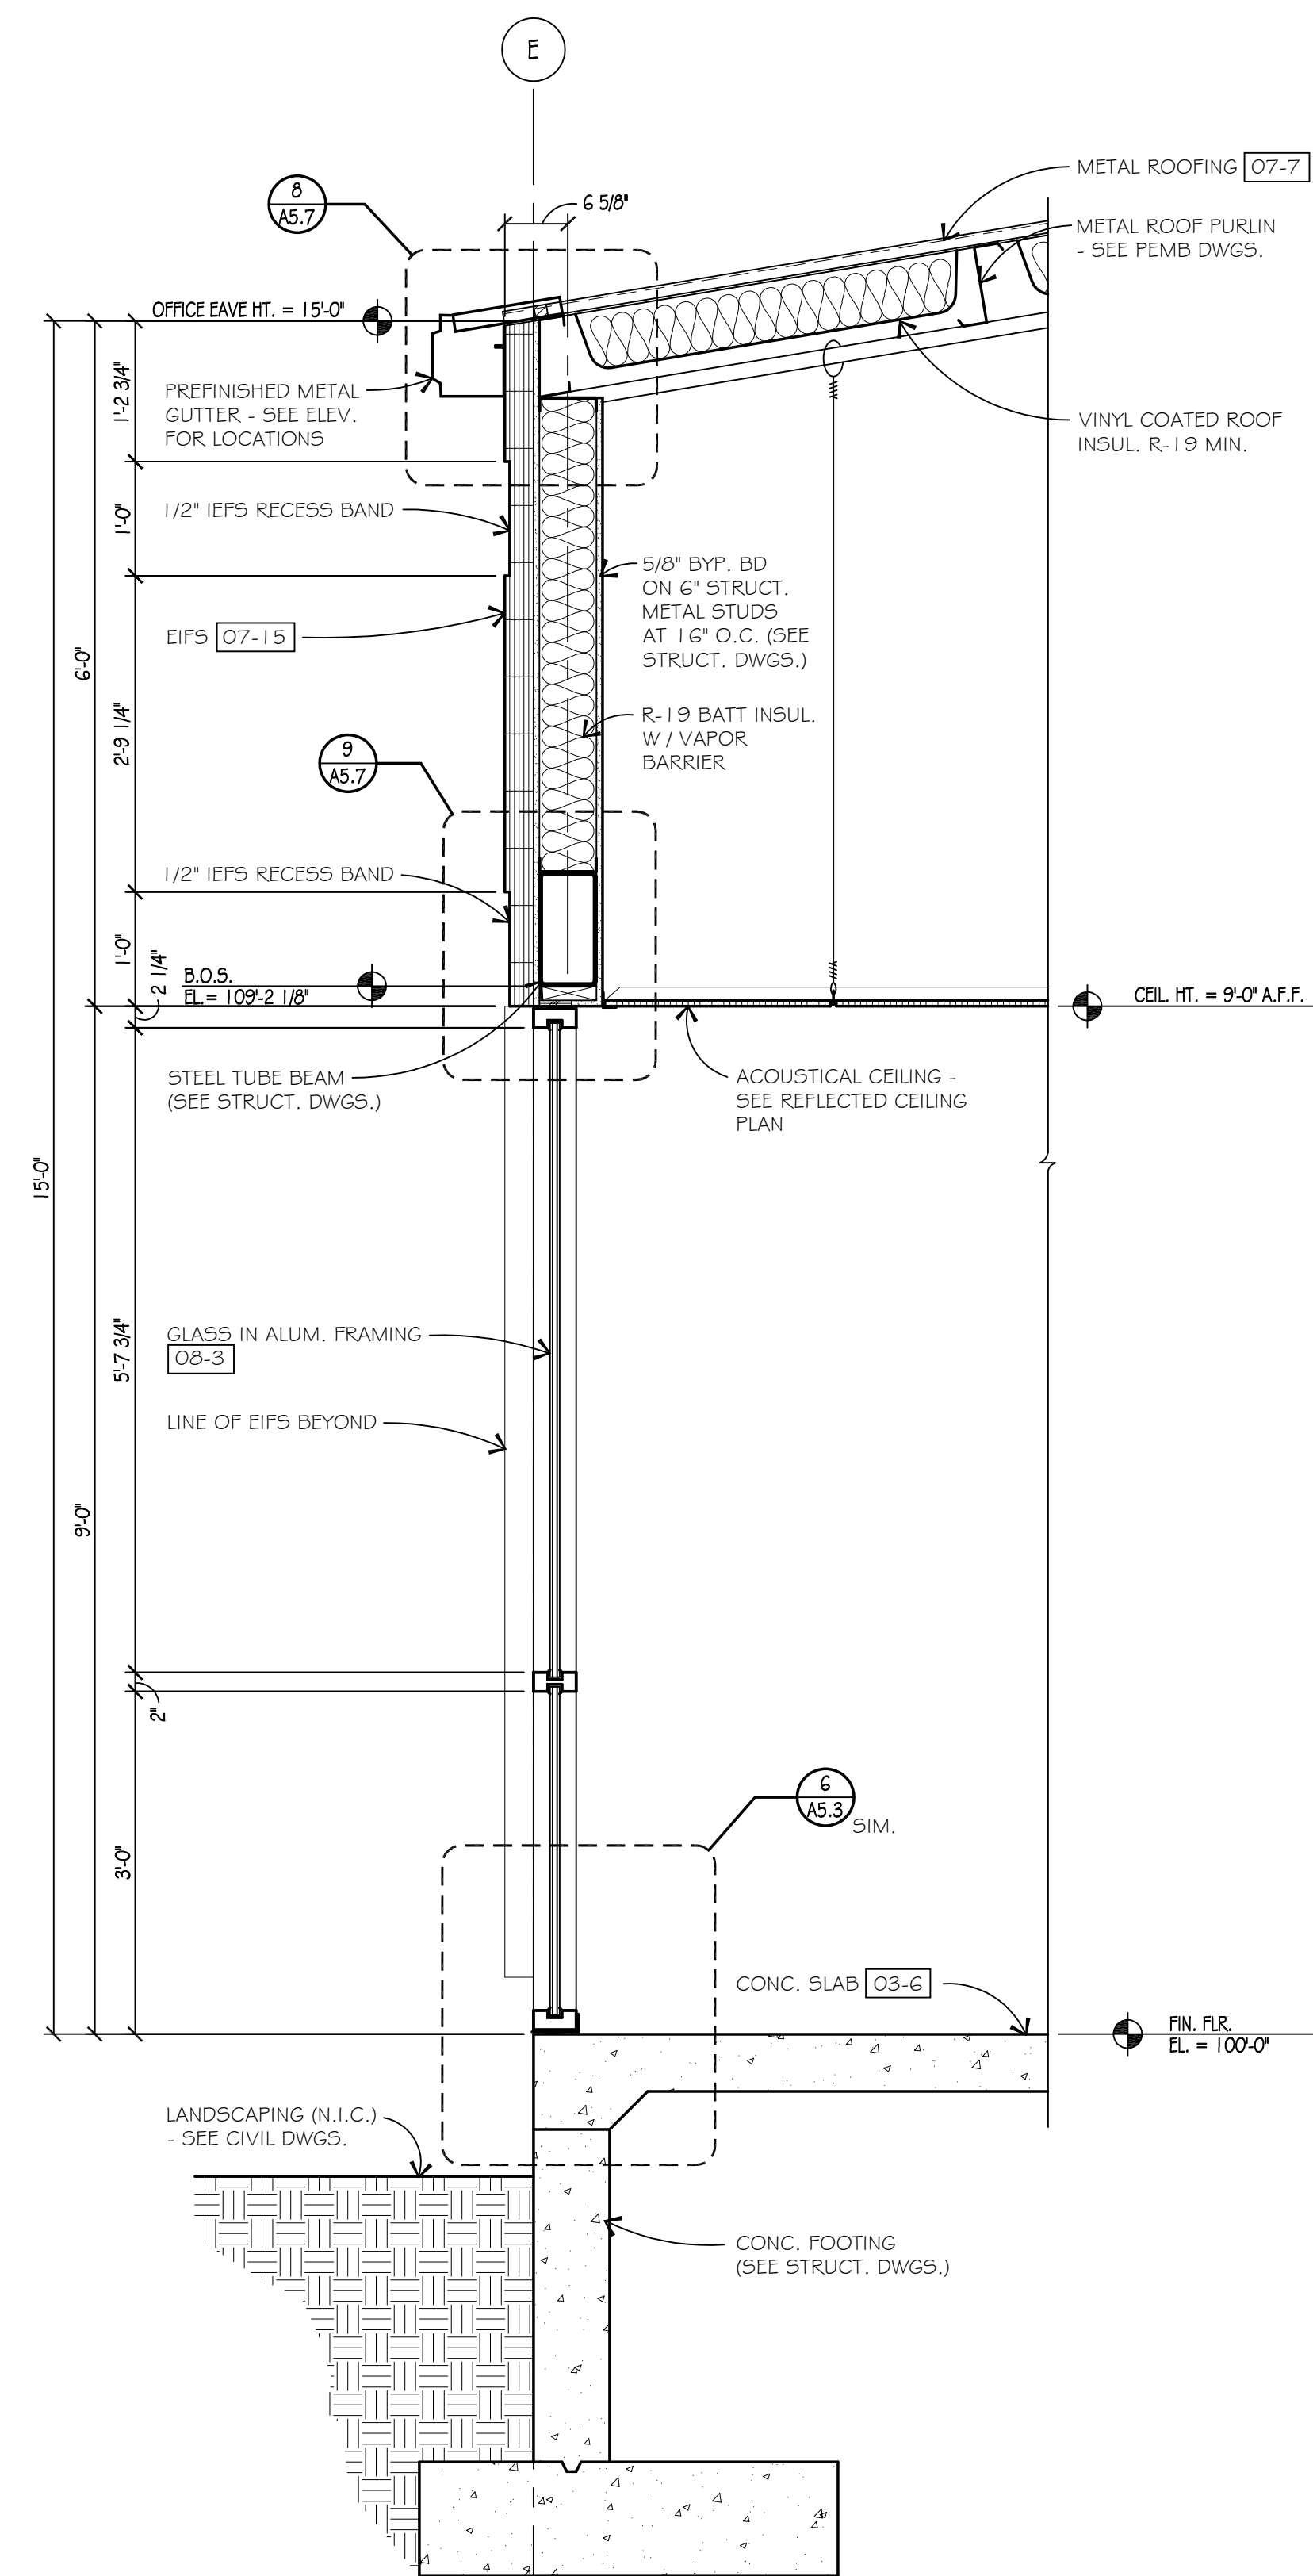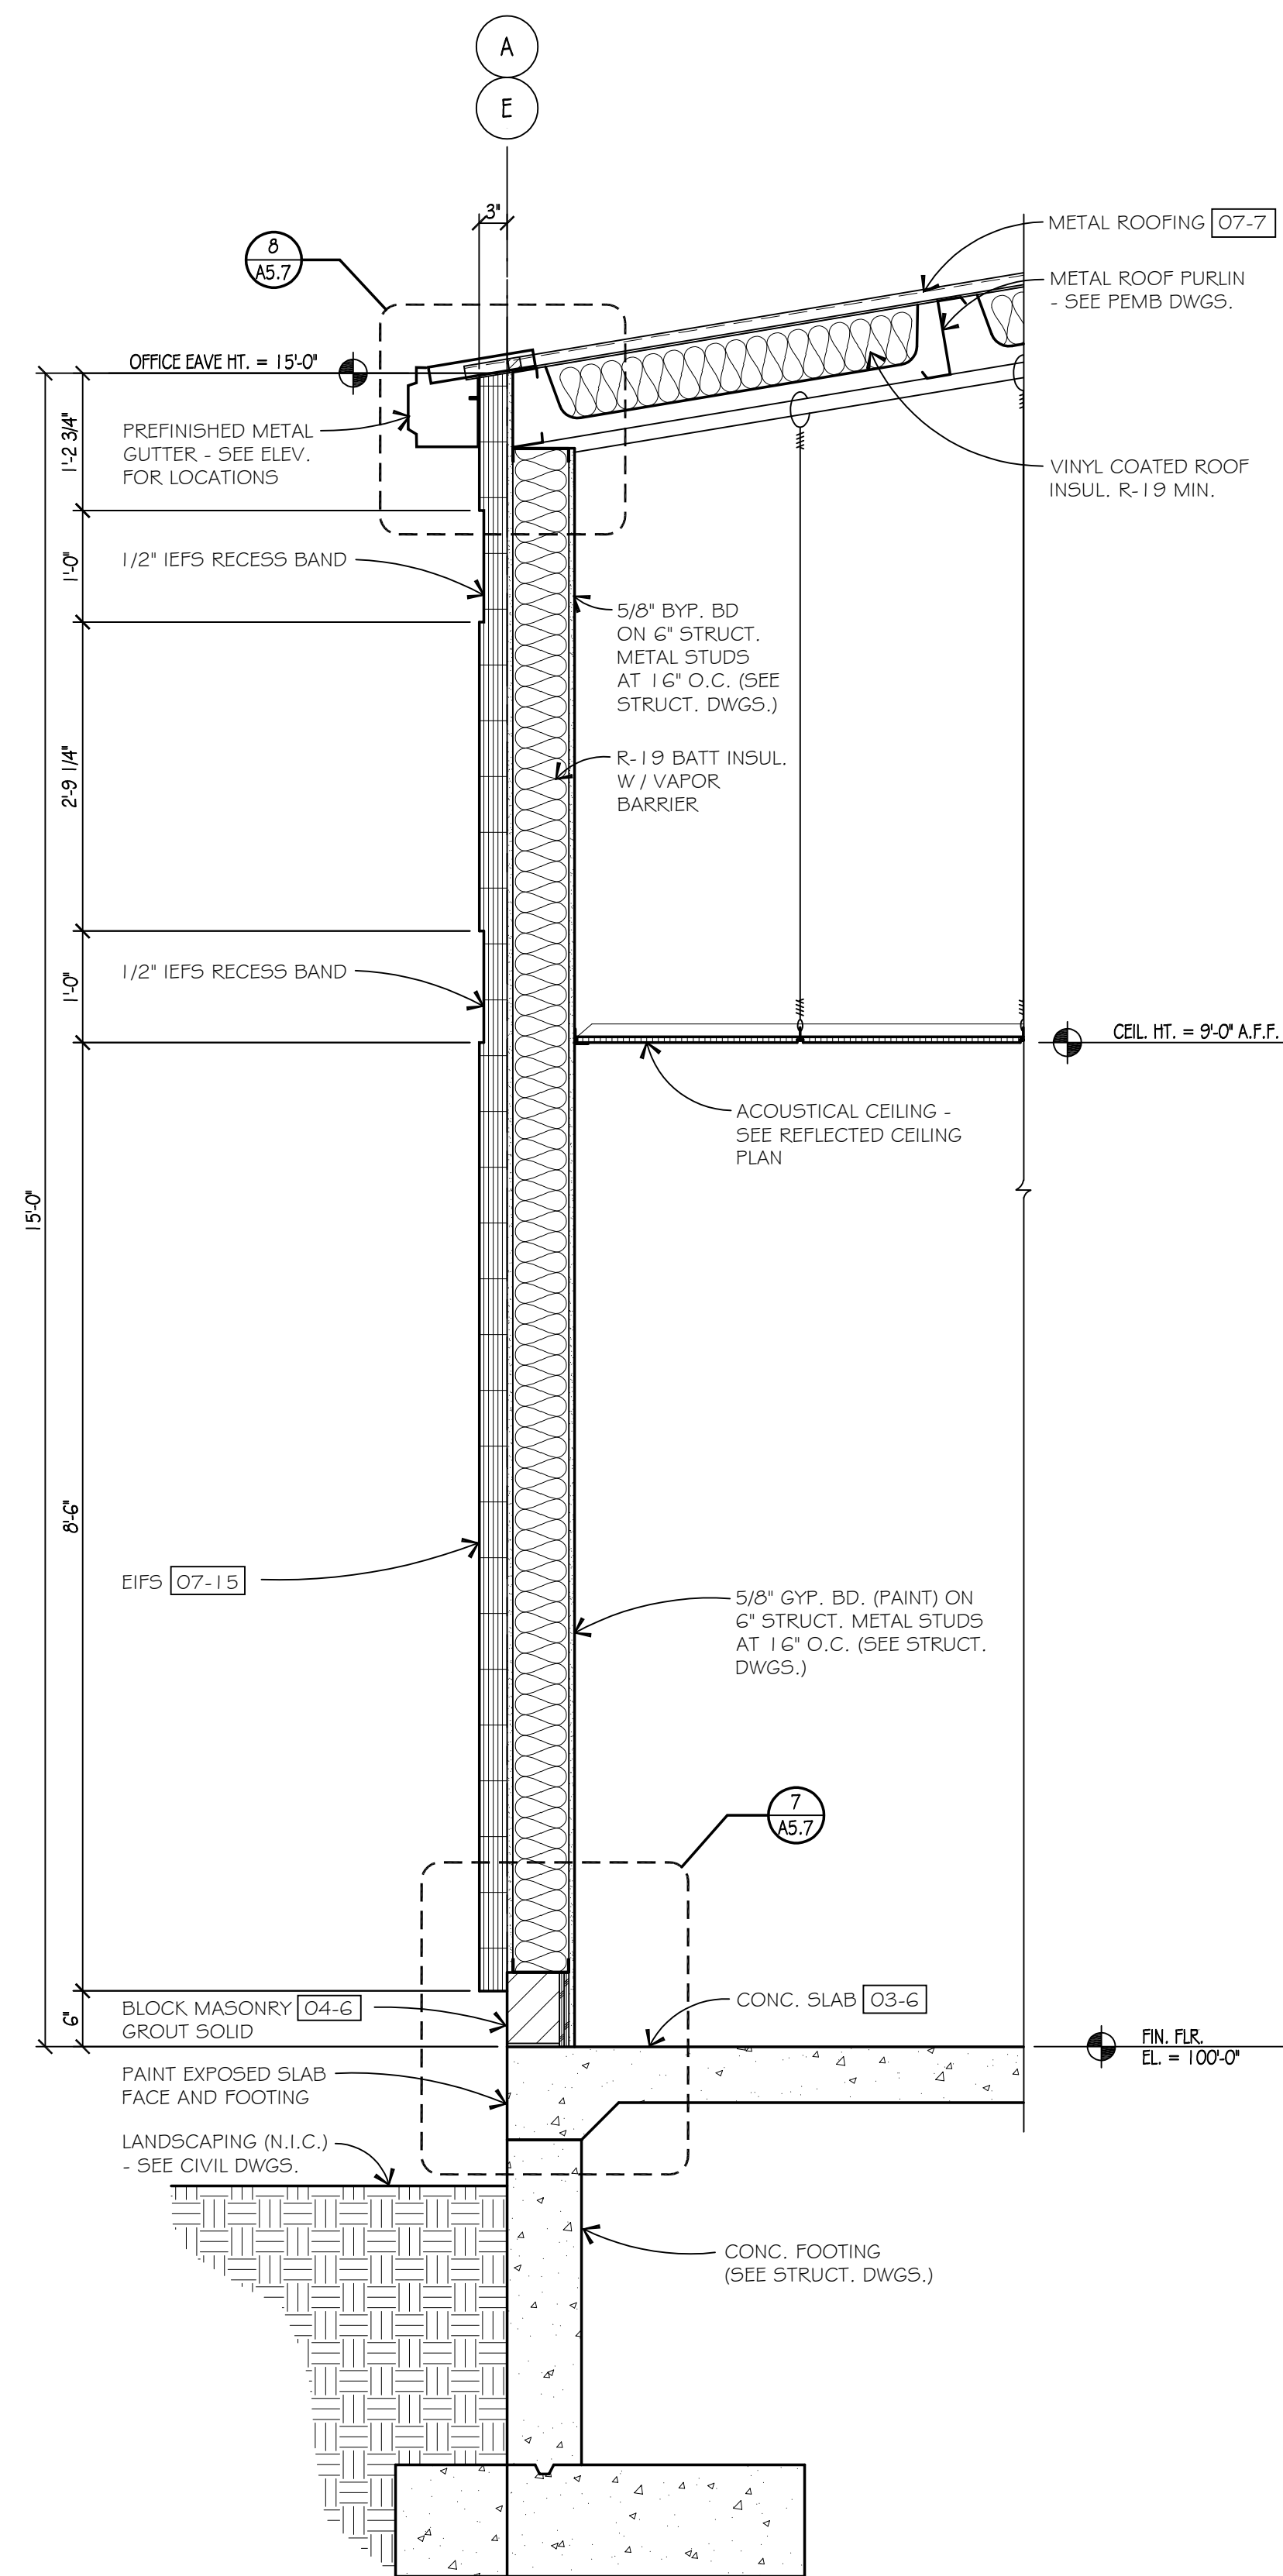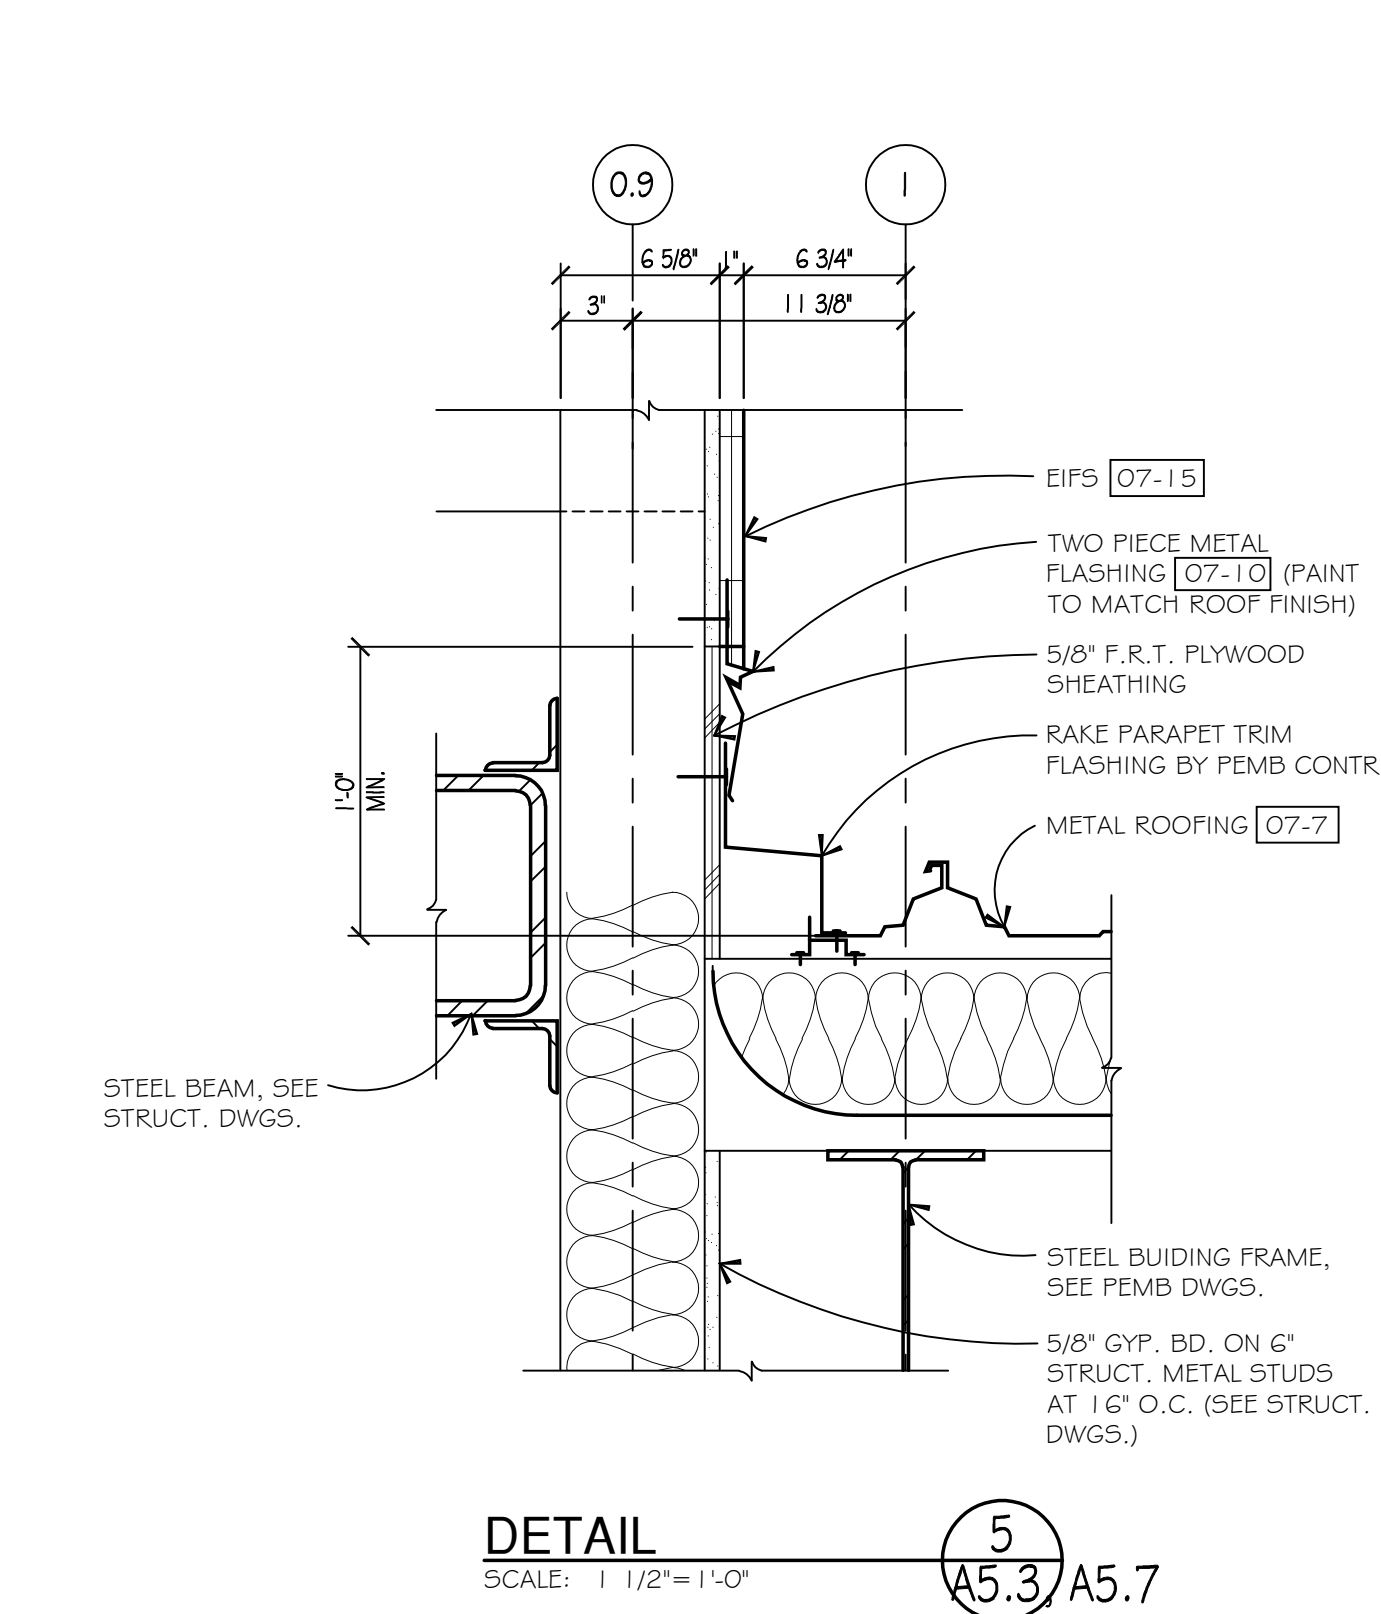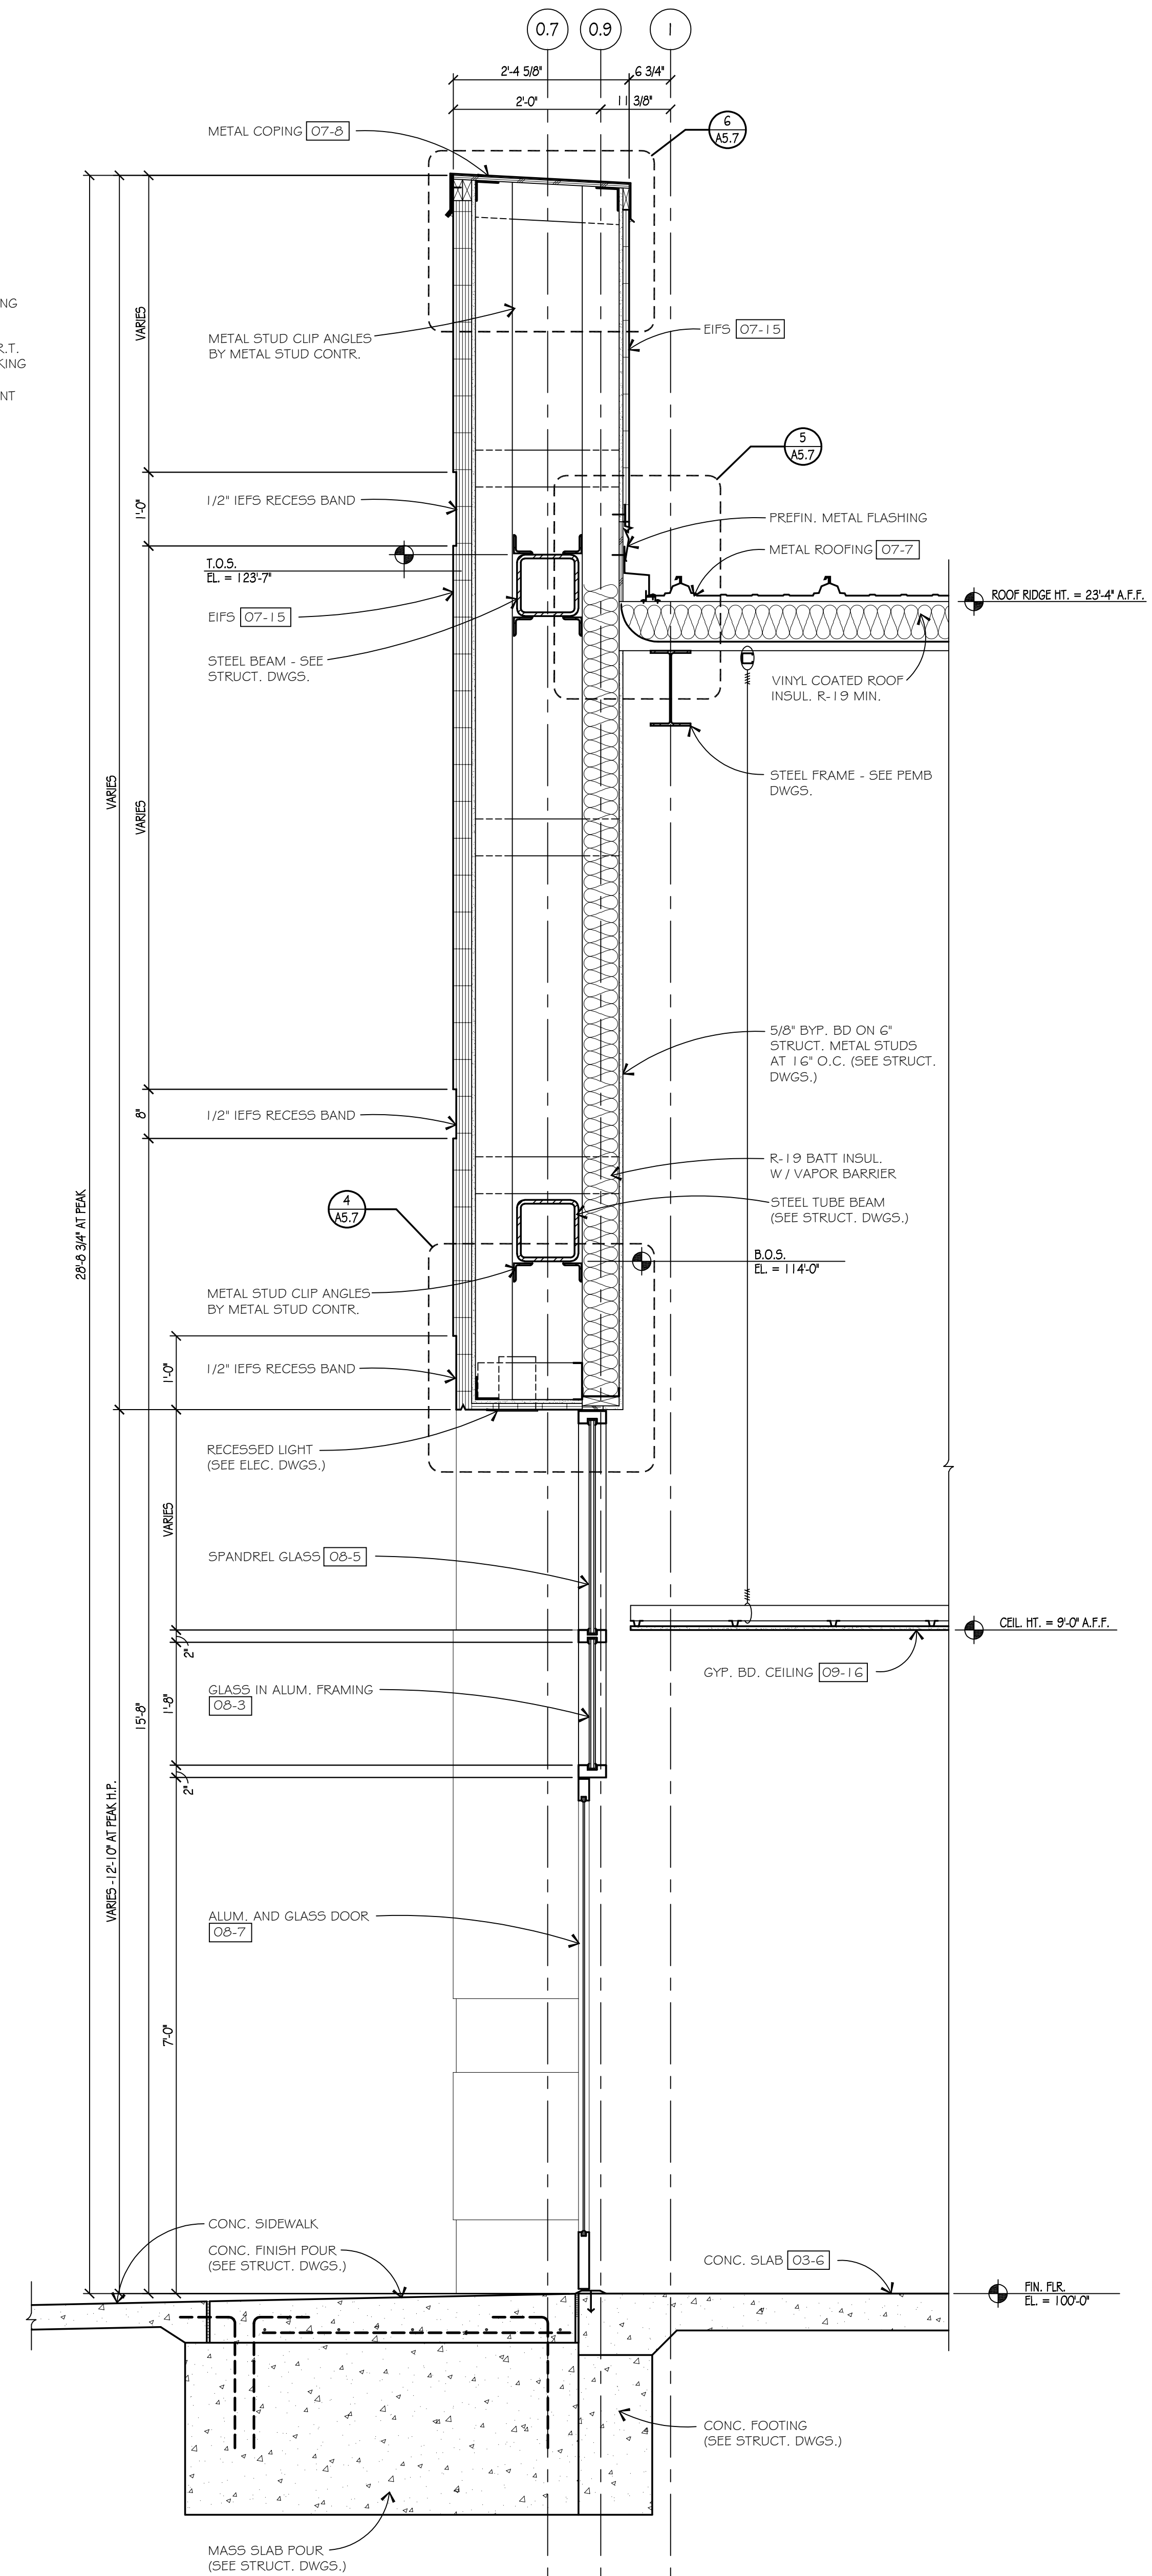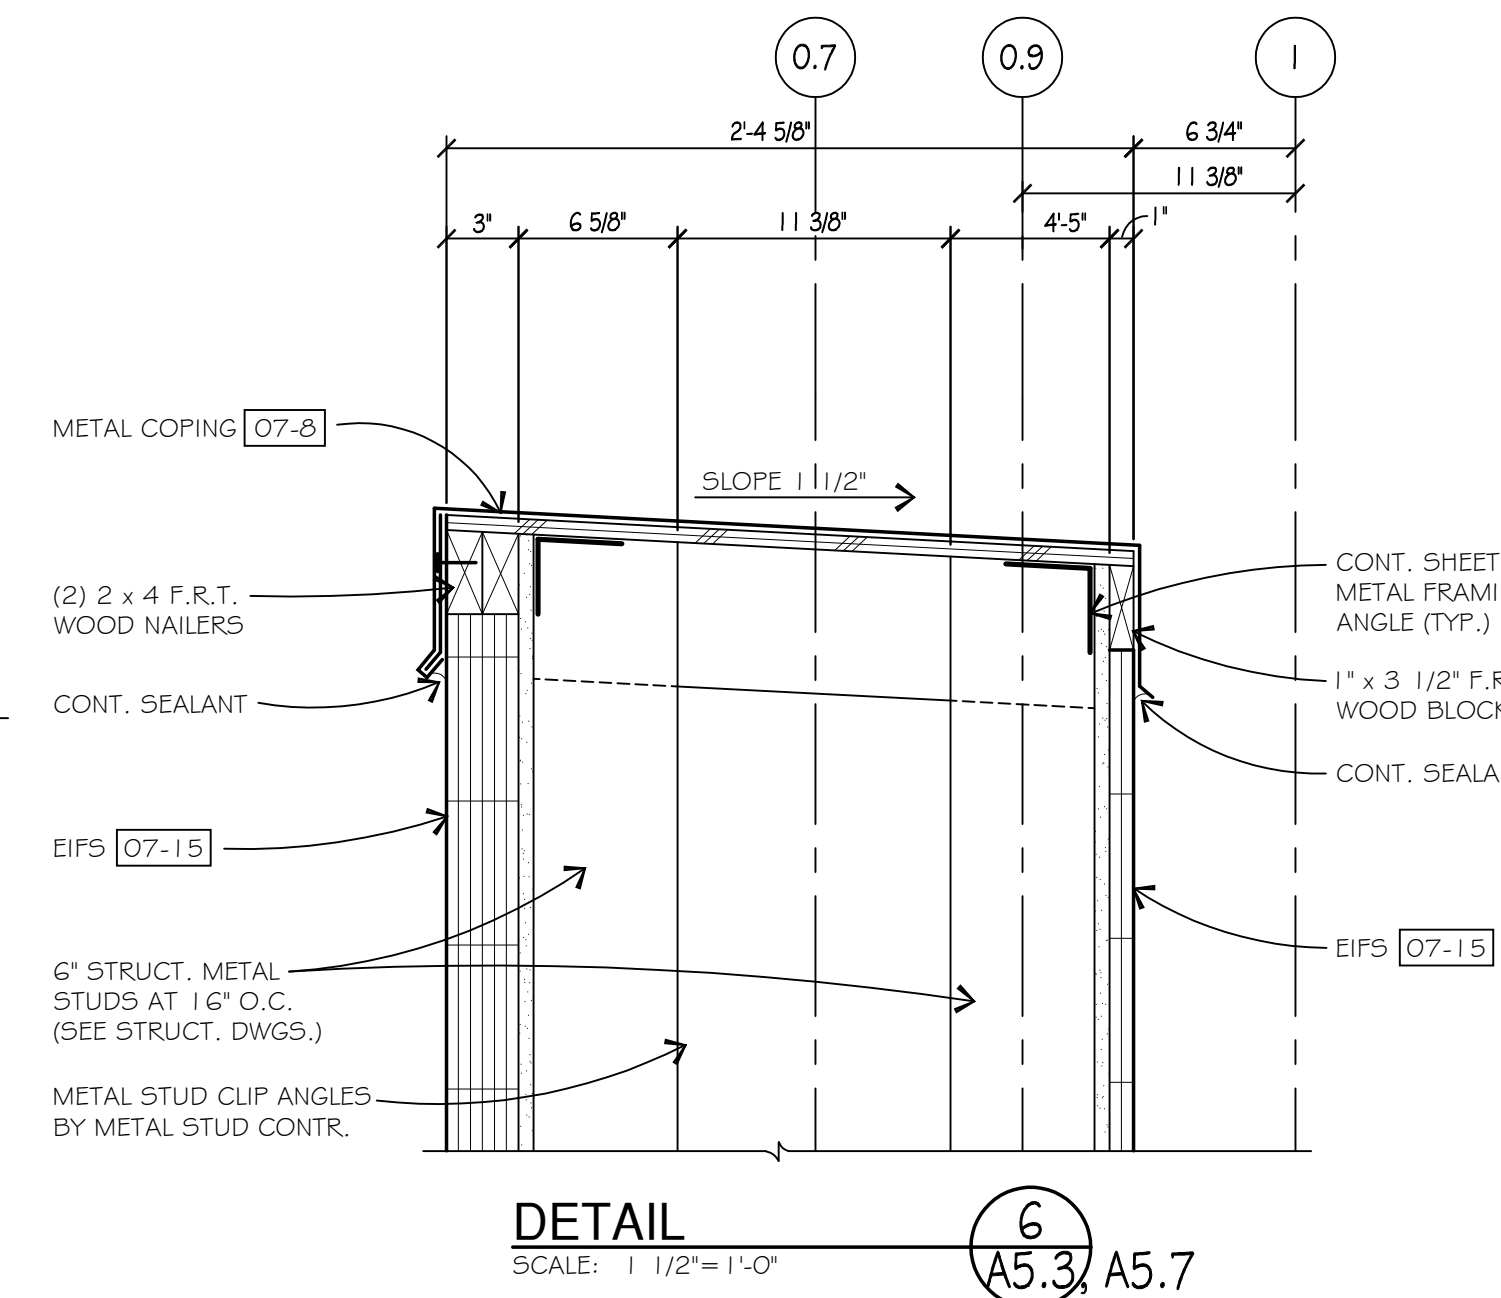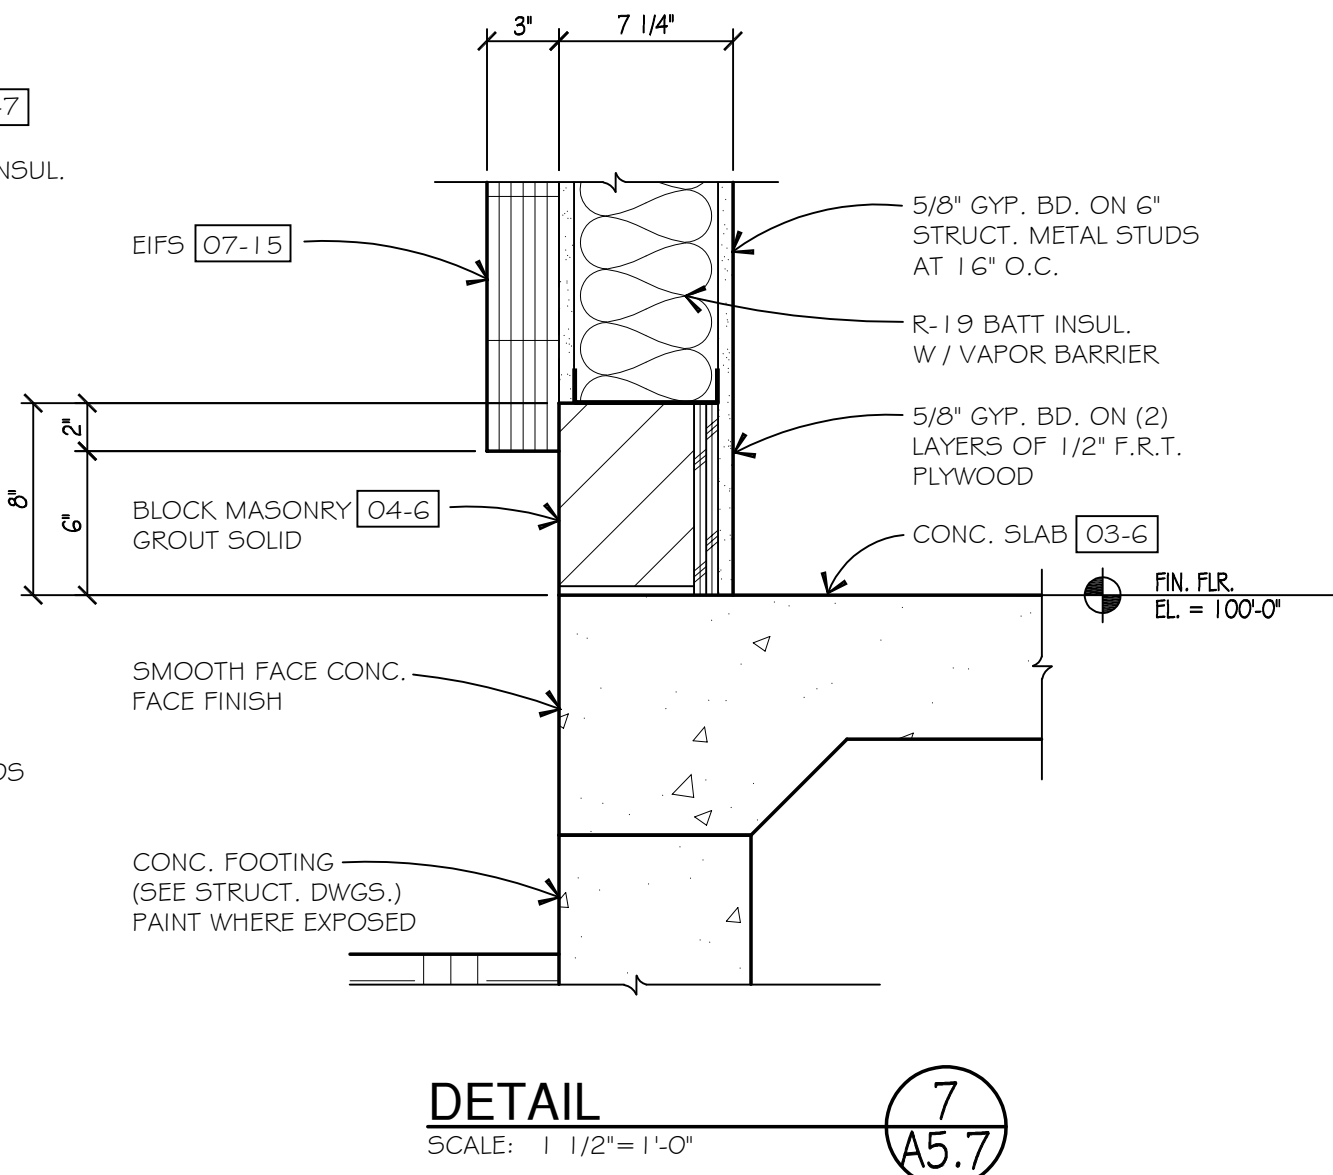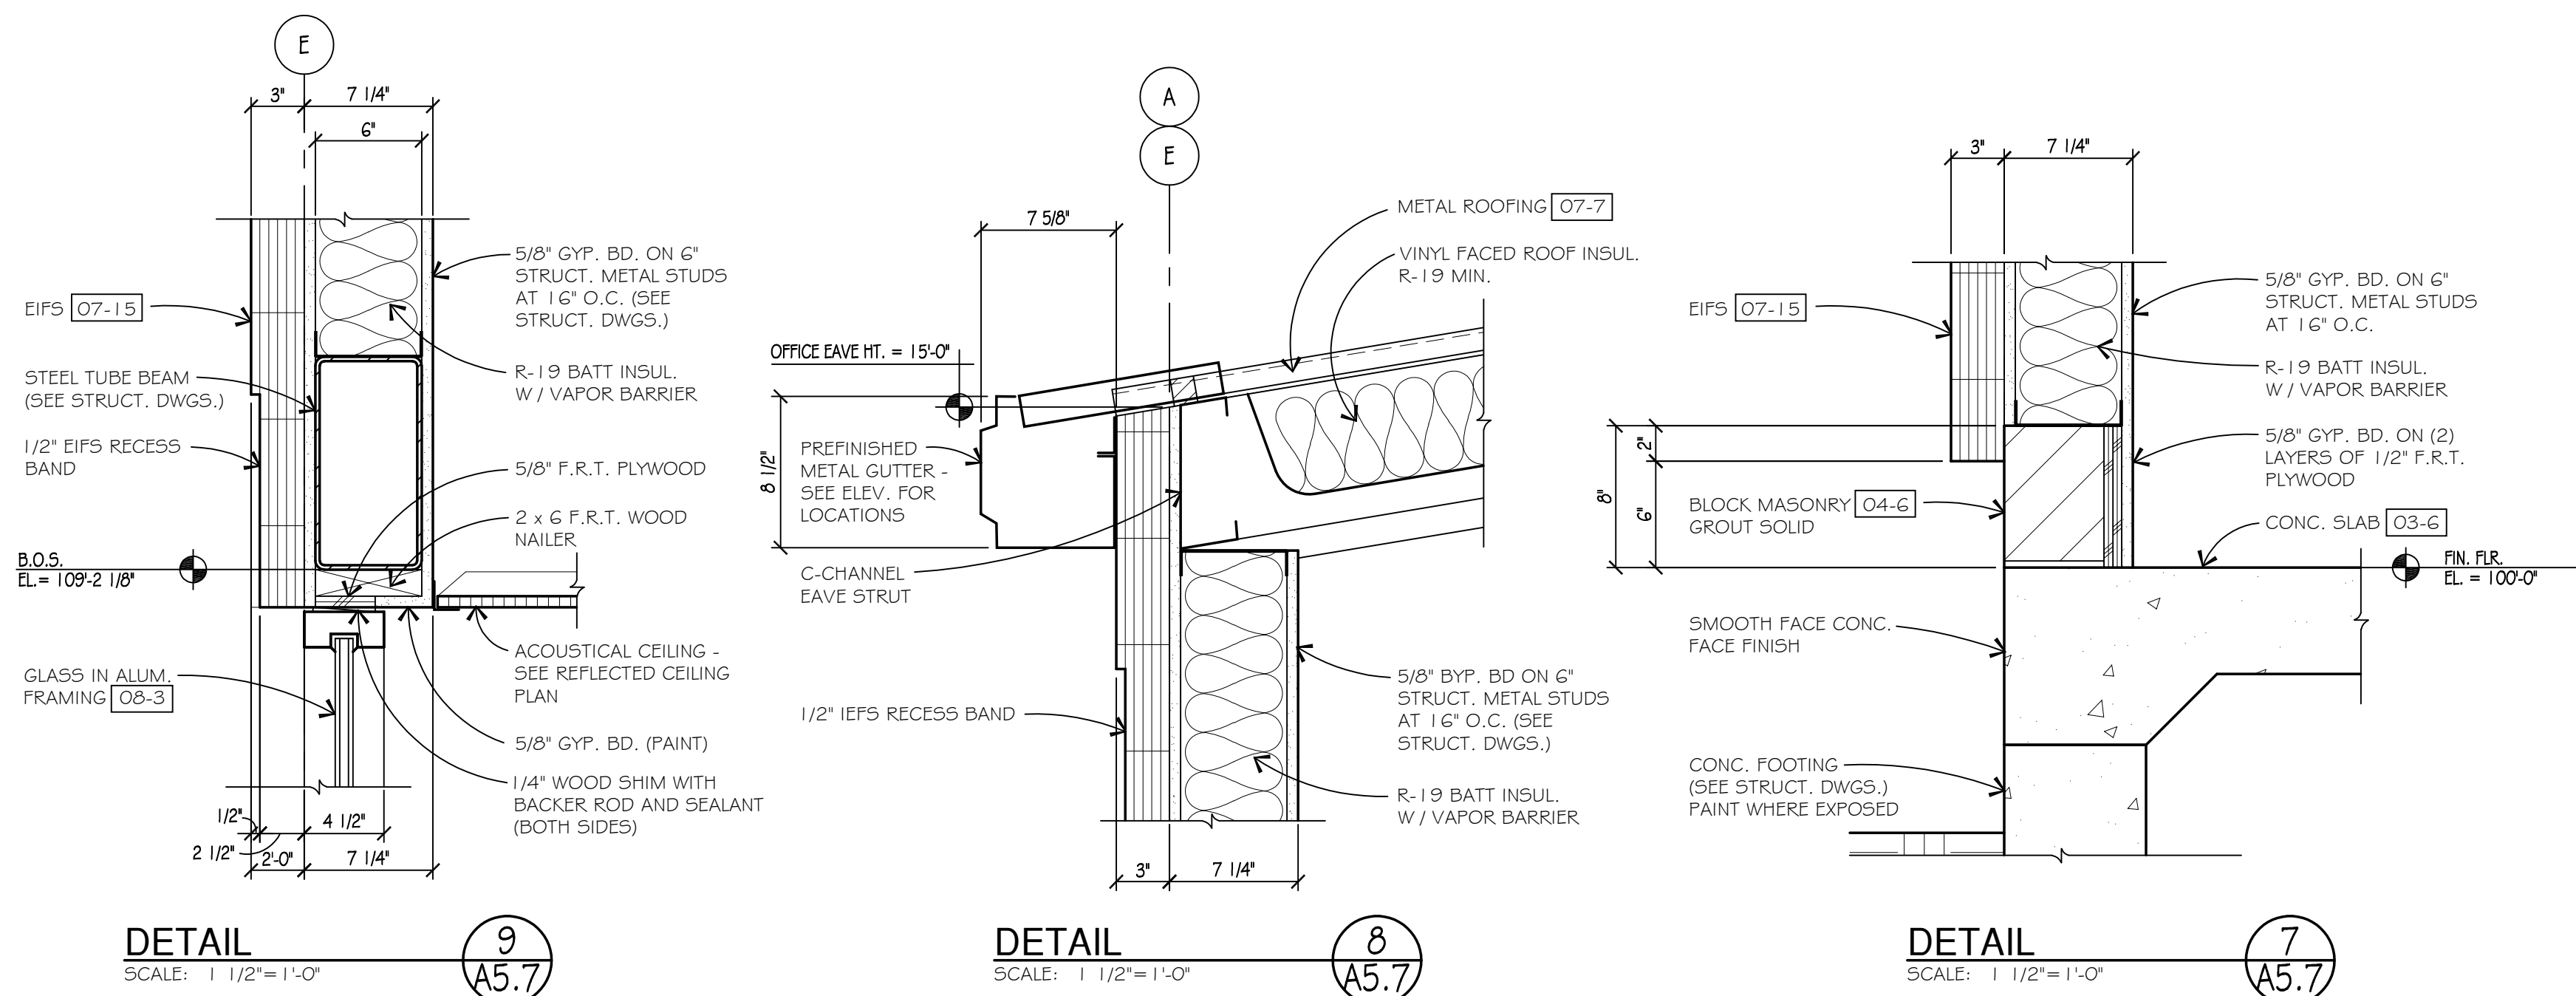


WALL SECTION 3  
SCALE: 3/4"=1'-0"  
A3.1, A4.1, A4.3

WALL SECTION 2  
SCALE: 3/4"=1'-0"  
A3.1, A4.1

WALL SECTION 1  
SCALE: 3/4"=1'-0"  
A3.1, A4.1

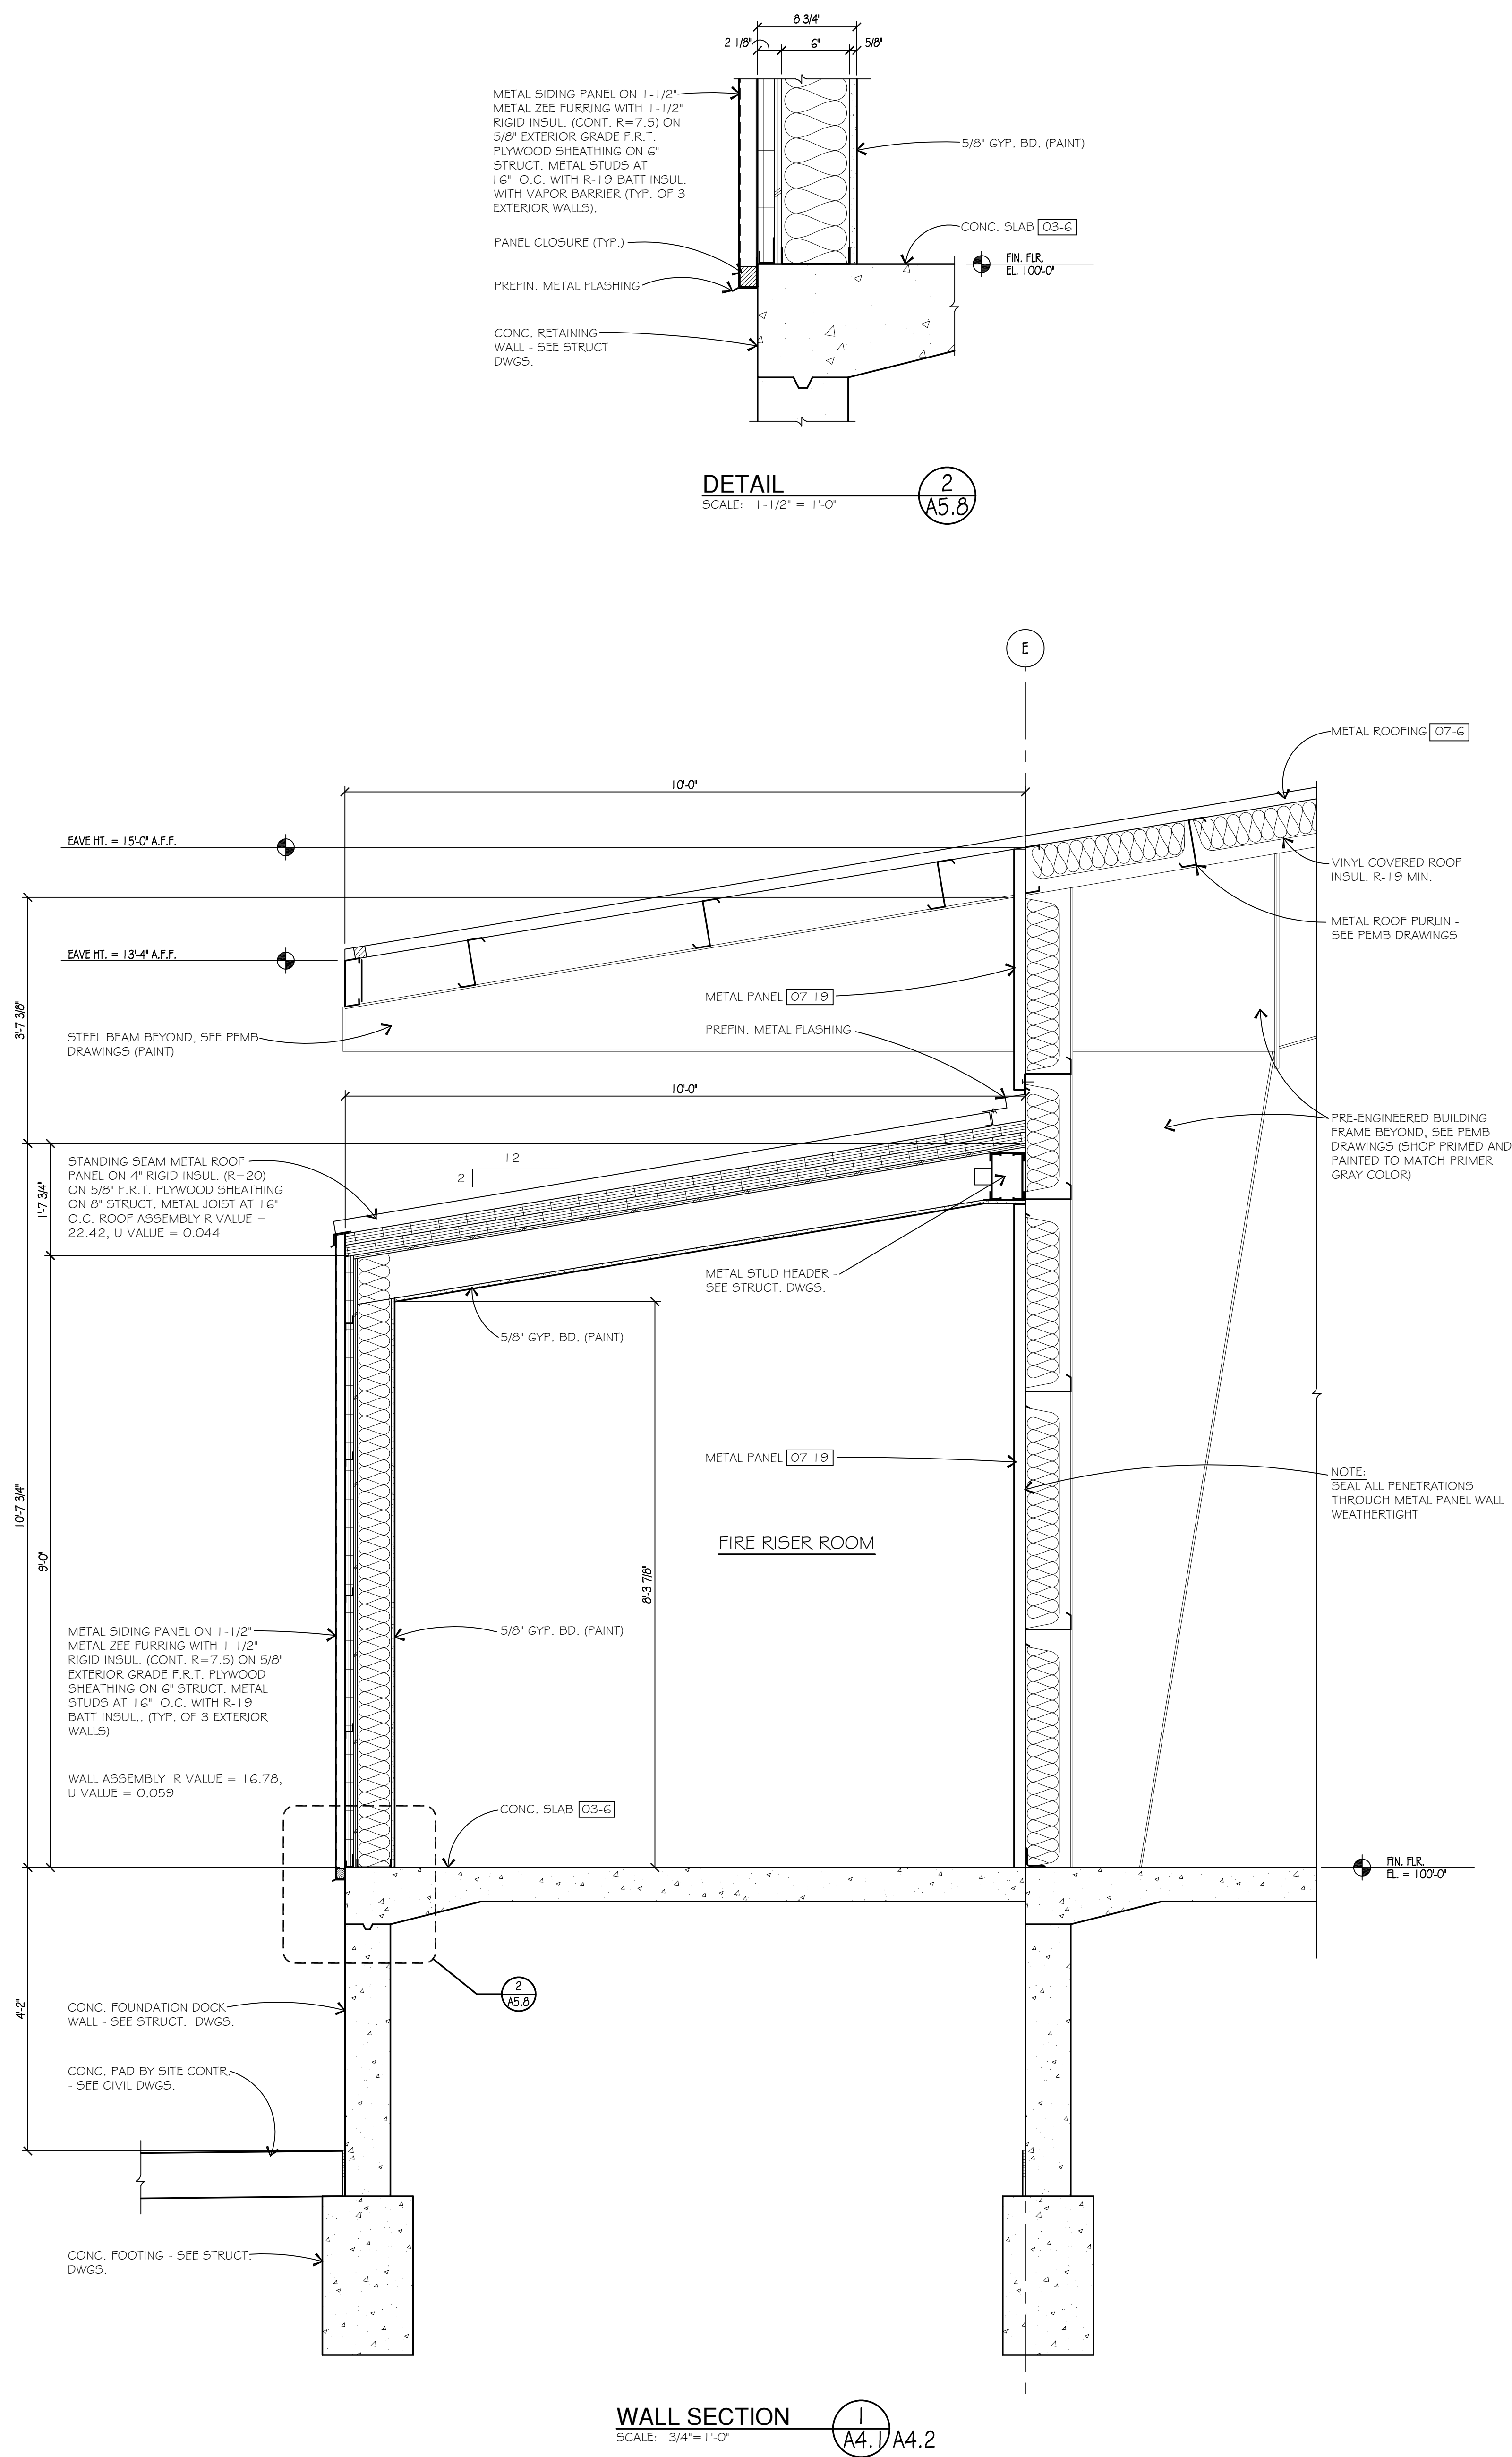




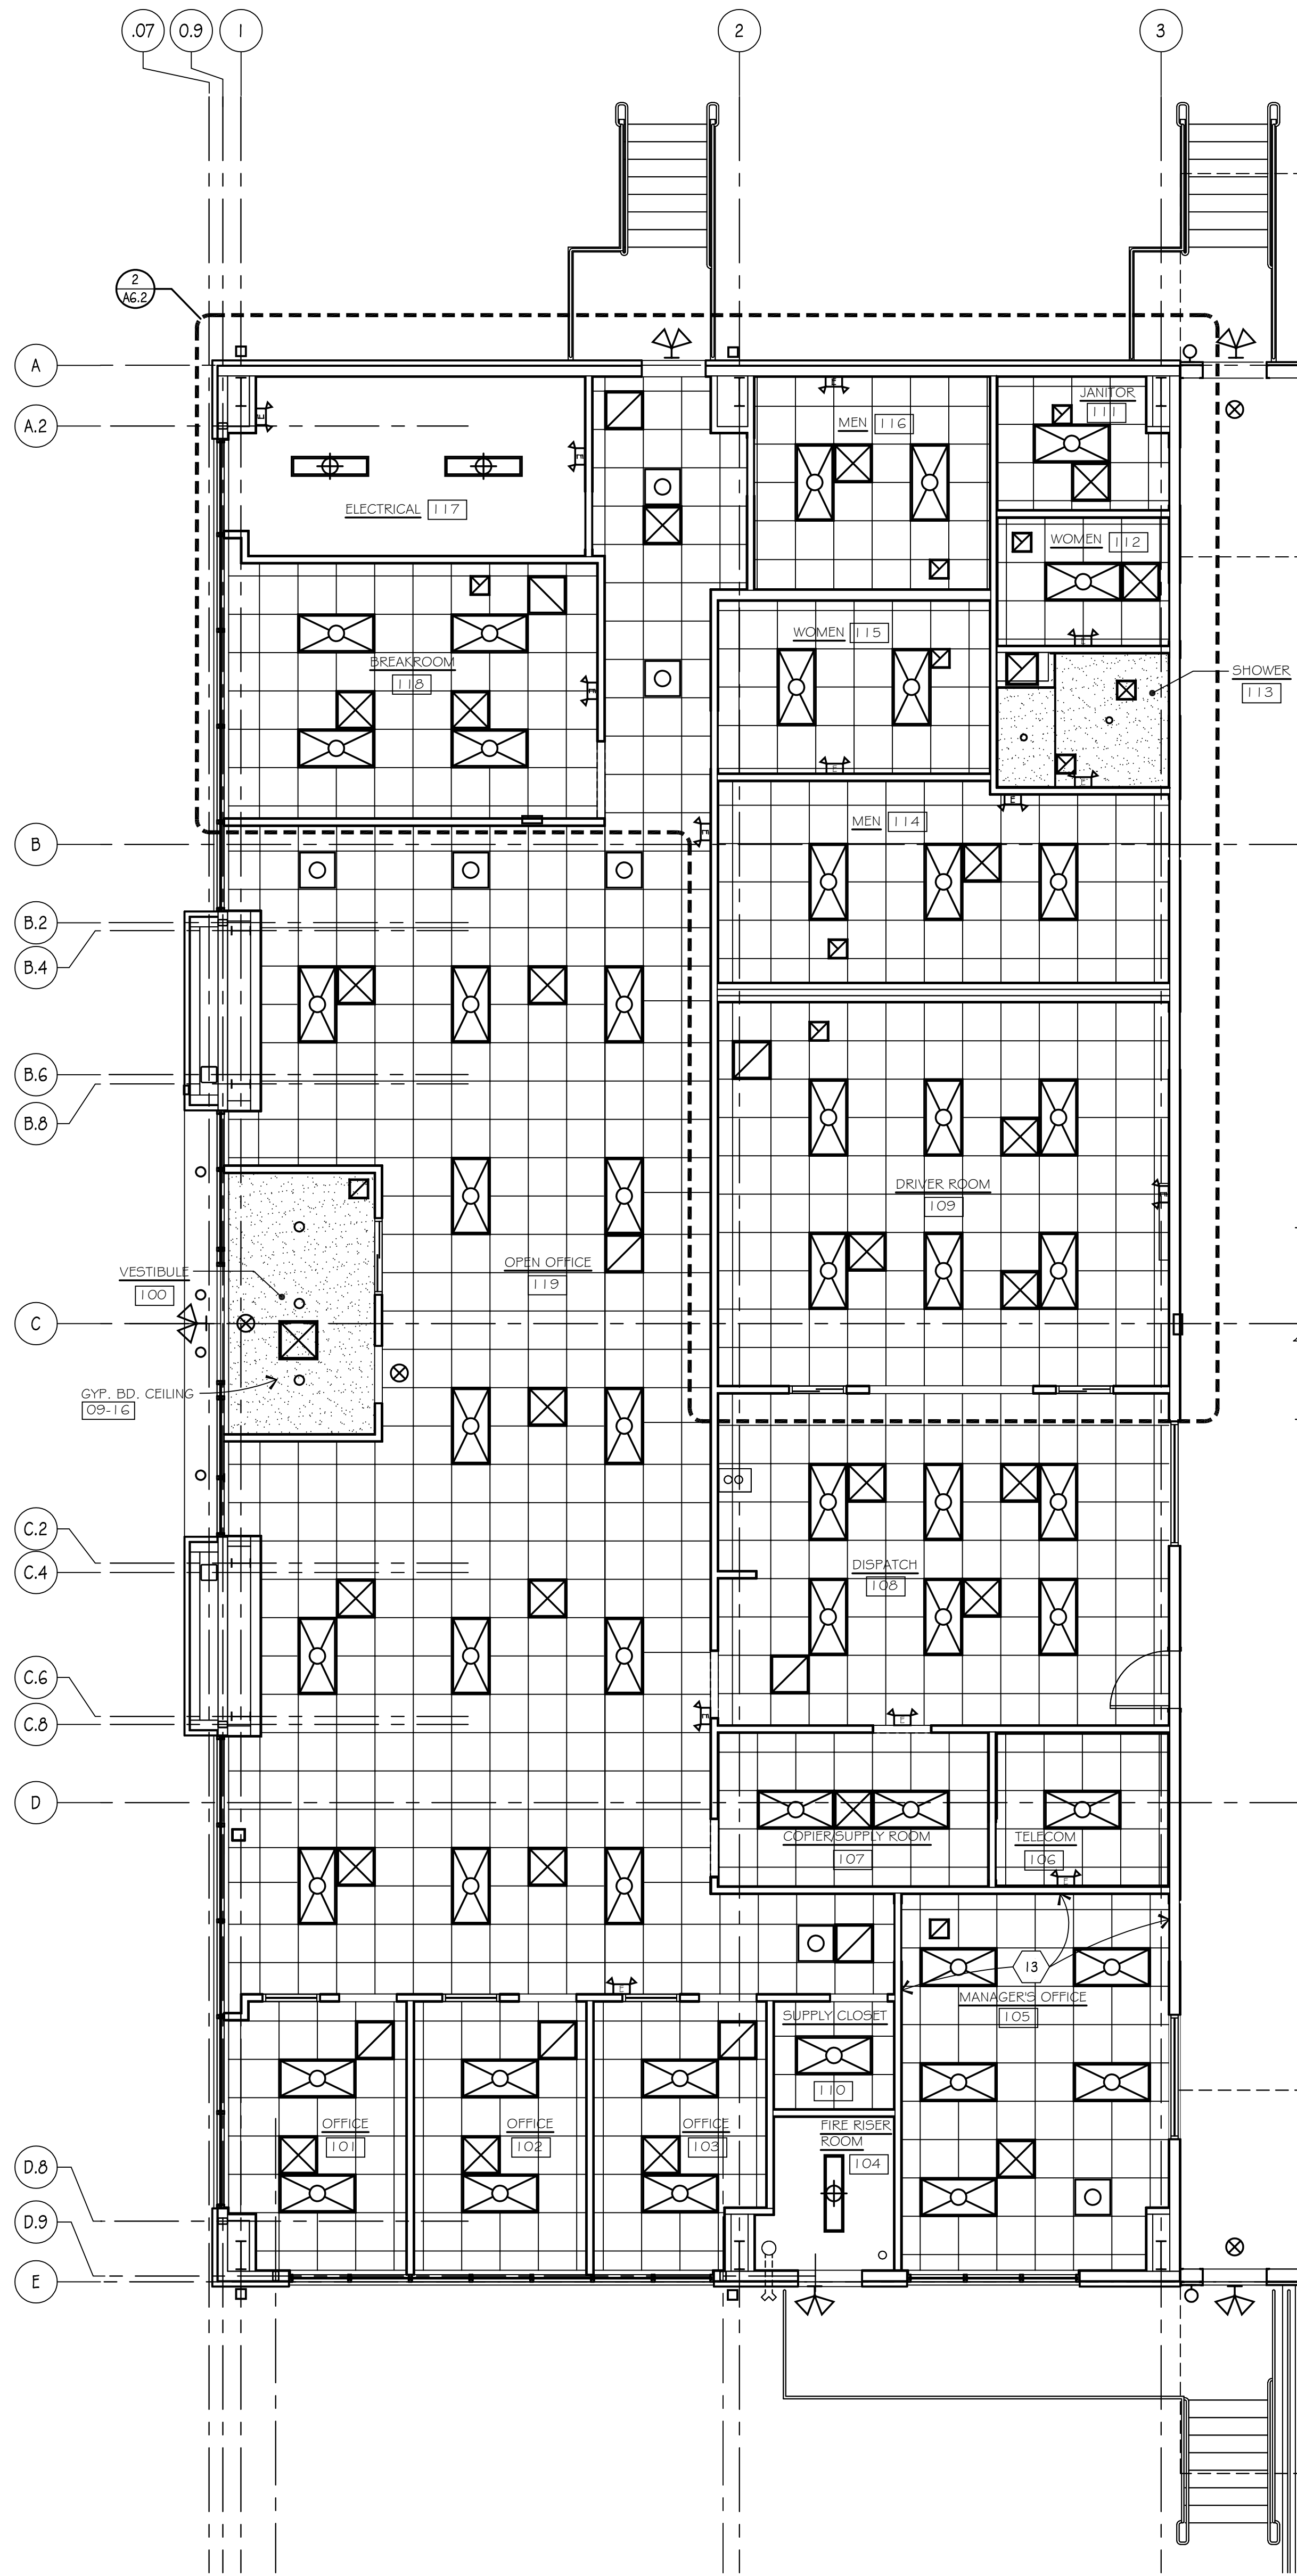


NOTES:  
1. CENTER CEILING GRID FRONT TO BACK AND SIDE TO SIDE.  
2. COORDINATE NIGHT LIGHT AND EMERGENCY LIGHTS WITH ELECTRICAL DRAWINGS.  
3. COORDINATE HVAC DIFFUSERS AND RETURNS WITH MECHANICAL DRAWINGS.  
4. CEILING TILE AS SELECTED BY OWNER & GENERAL CONTRACTOR.  
5. USE MOISTURE RESISTANT ACOUSTICAL CEILING TILE IN TOILET ROOMS.  
6. ACOUSTICAL TILE AND GYPSUM BOARD CEILINGS TO BE AT 9'-0" A.F.F. UNLESS NOTED OTHERWISE.

ENLARGED OFFICE REFLECTED CEILING PLAN


SCALE: 3/16" = 1'-0"

2  
A6.1

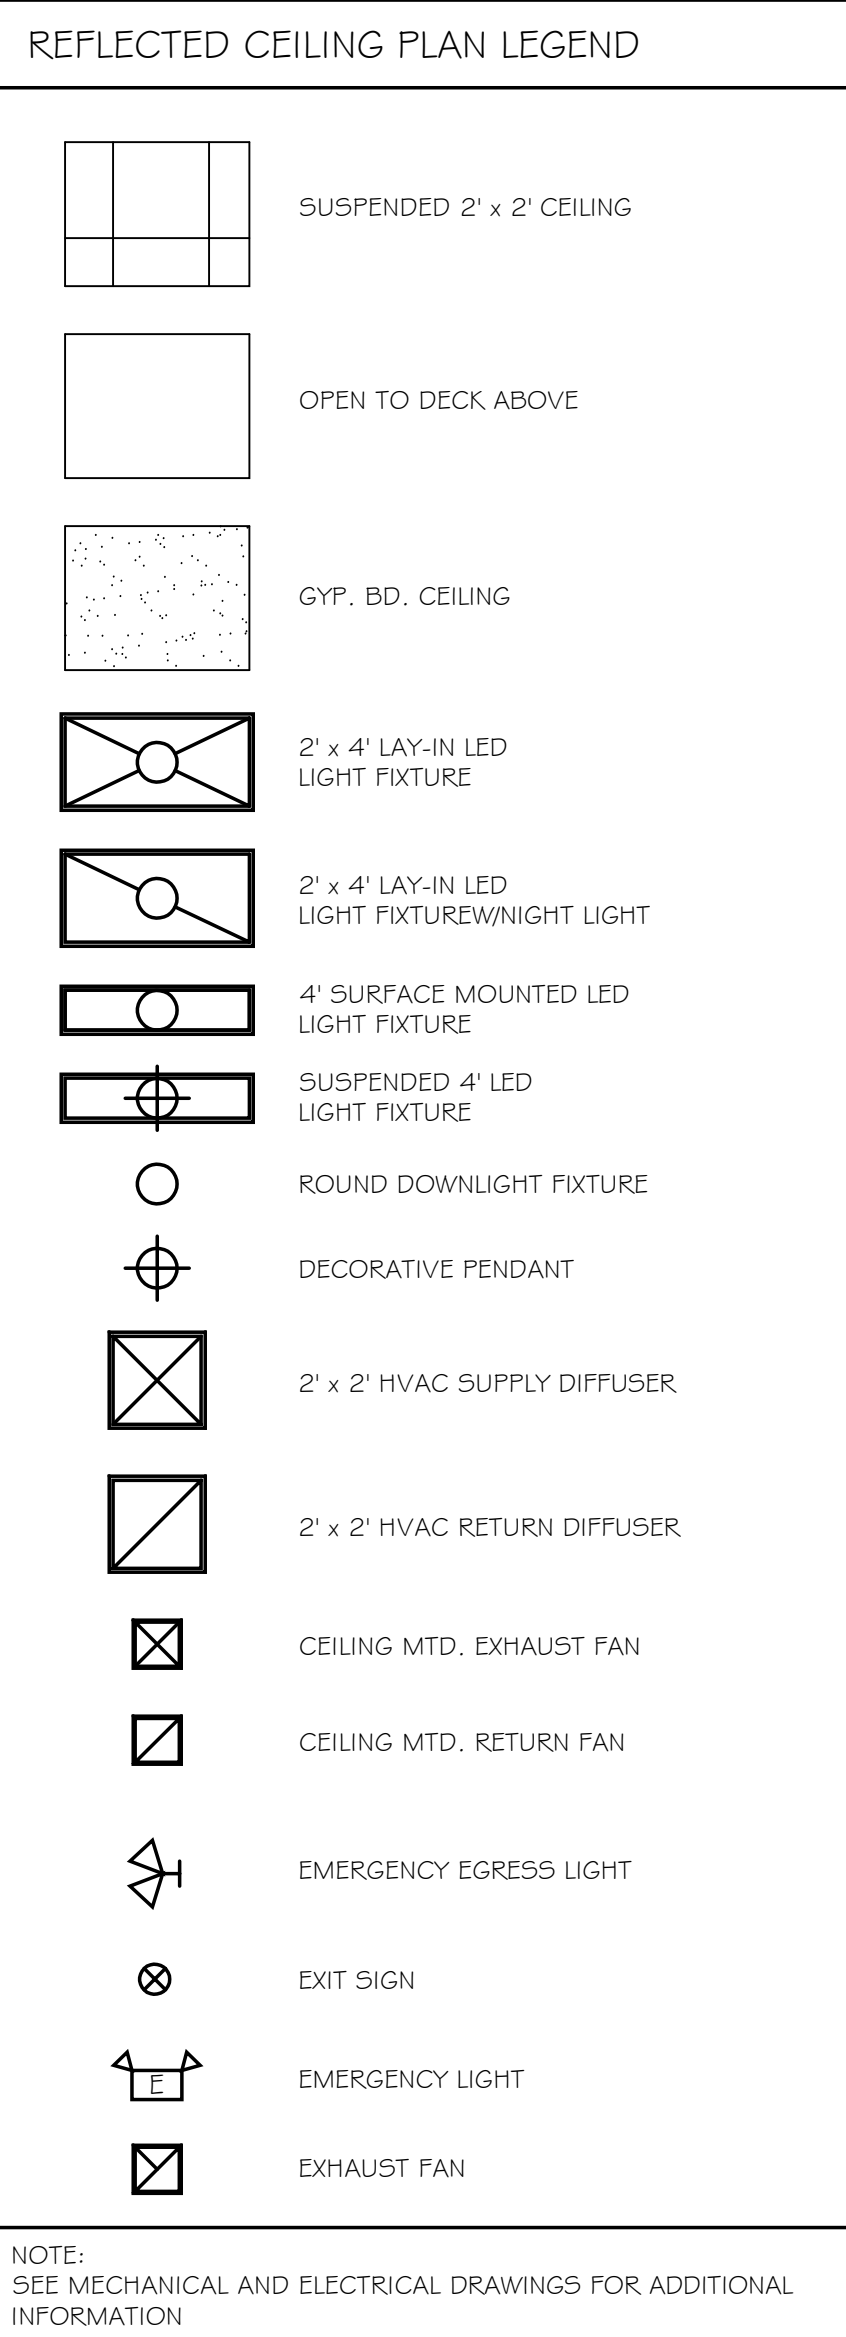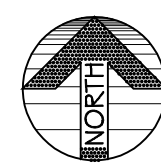

KEY NOTES

- 6" DIA. BOLLARD [05-1] AT 8'-0" O.C. MAX. WITH 6 x 6 STEEL ANGLE AT BASE AND HORIZONTAL STEEL CHANNEL RAIL (PAINT SAFETY YELLOW).
- PROVIDE PAINTED 3/4" F.R.T. PLYWOOD BACK BOARD ON ALL WALLS IN TELECOM TO 8'-0" A.F.F.
- 6" x 1 1/8 GA. METAL STUDS AT 16" O.C. WITH (1) LAYER OF 5/8" TYPE "X" GYPSUM BOARD EACH SIDE, EXTEND TO DECK ON BOTH SIDES. TERMINAL SIDE WALL TO BE MOISTURE RESISTANT HIGH IMPACT GYPSUM BOARD. PROVIDE R-19 BATT INSULATION WITH VAPOR BARRIER ON OFFICE (WARM) SIDE.
- PNEUMATIC SYSTEM TO BE PIPED FROM ENTRY GATE ISLAND UP THROUGH FLOOR IN FIRE RISER ROOM AND ROUTED TO DISPATCH ROOM. GENERAL CONTRACTOR TO COORDINATE INSTALLATION OF FIRE RISER, DOMESTIC WATER AND PNEUMATIC TUBE SYSTEM IN FIRE RISER ROOM.
- 48" x 48" SLIDING WINDOW PROVIDED BY OWNER INSTALLED BY GENERAL CONTRACTOR.
- PASS THRU WINDOW.
- MAIL BOX SLOTS.
- HALF-WALL - 6" METAL STUDS AT 16" O.C. (ANCHOR TO FLOOR) WITH 5/8" GYPSUM BOARD TO UNDERSIDE OF COUNTER. PROVIDE (2) LAYERS OF 3/4" PLYWOOD FOR COUNTERTOP WITH PLASTIC LAMINATE FINISH. TOP OF COUNTER AT 4'-0" A.F.F.
- CONDENSING UNIT (TYP) - SEE MECHANICAL DRAWINGS.
- TRANSFORMER SUSPENDED FROM STRUCTURE - SEE ELECTRICAL DRAWINGS.
- TV PROVIDED BY OWNER INSTALLED BY GENERAL CONTRACTOR. VERIFY HEIGHT AND LOCATION WITH OWNER.
- PROVIDE 7 1/4" x 8" GYPSUM BOARD AND METAL STUD BOX-OUT FOR DATA CONDUIT FEED AT END OF HALF HIGH "T" WALL TO 6" ABOVE CEILING.
- PROVIDE SOUND BATT INSULATION ABOVE CEILING AT PERIMETER OF MANAGER'S OFFICE AND ADJACENT ROOMS. SEE DETAIL 8 ON SHEET A6.3

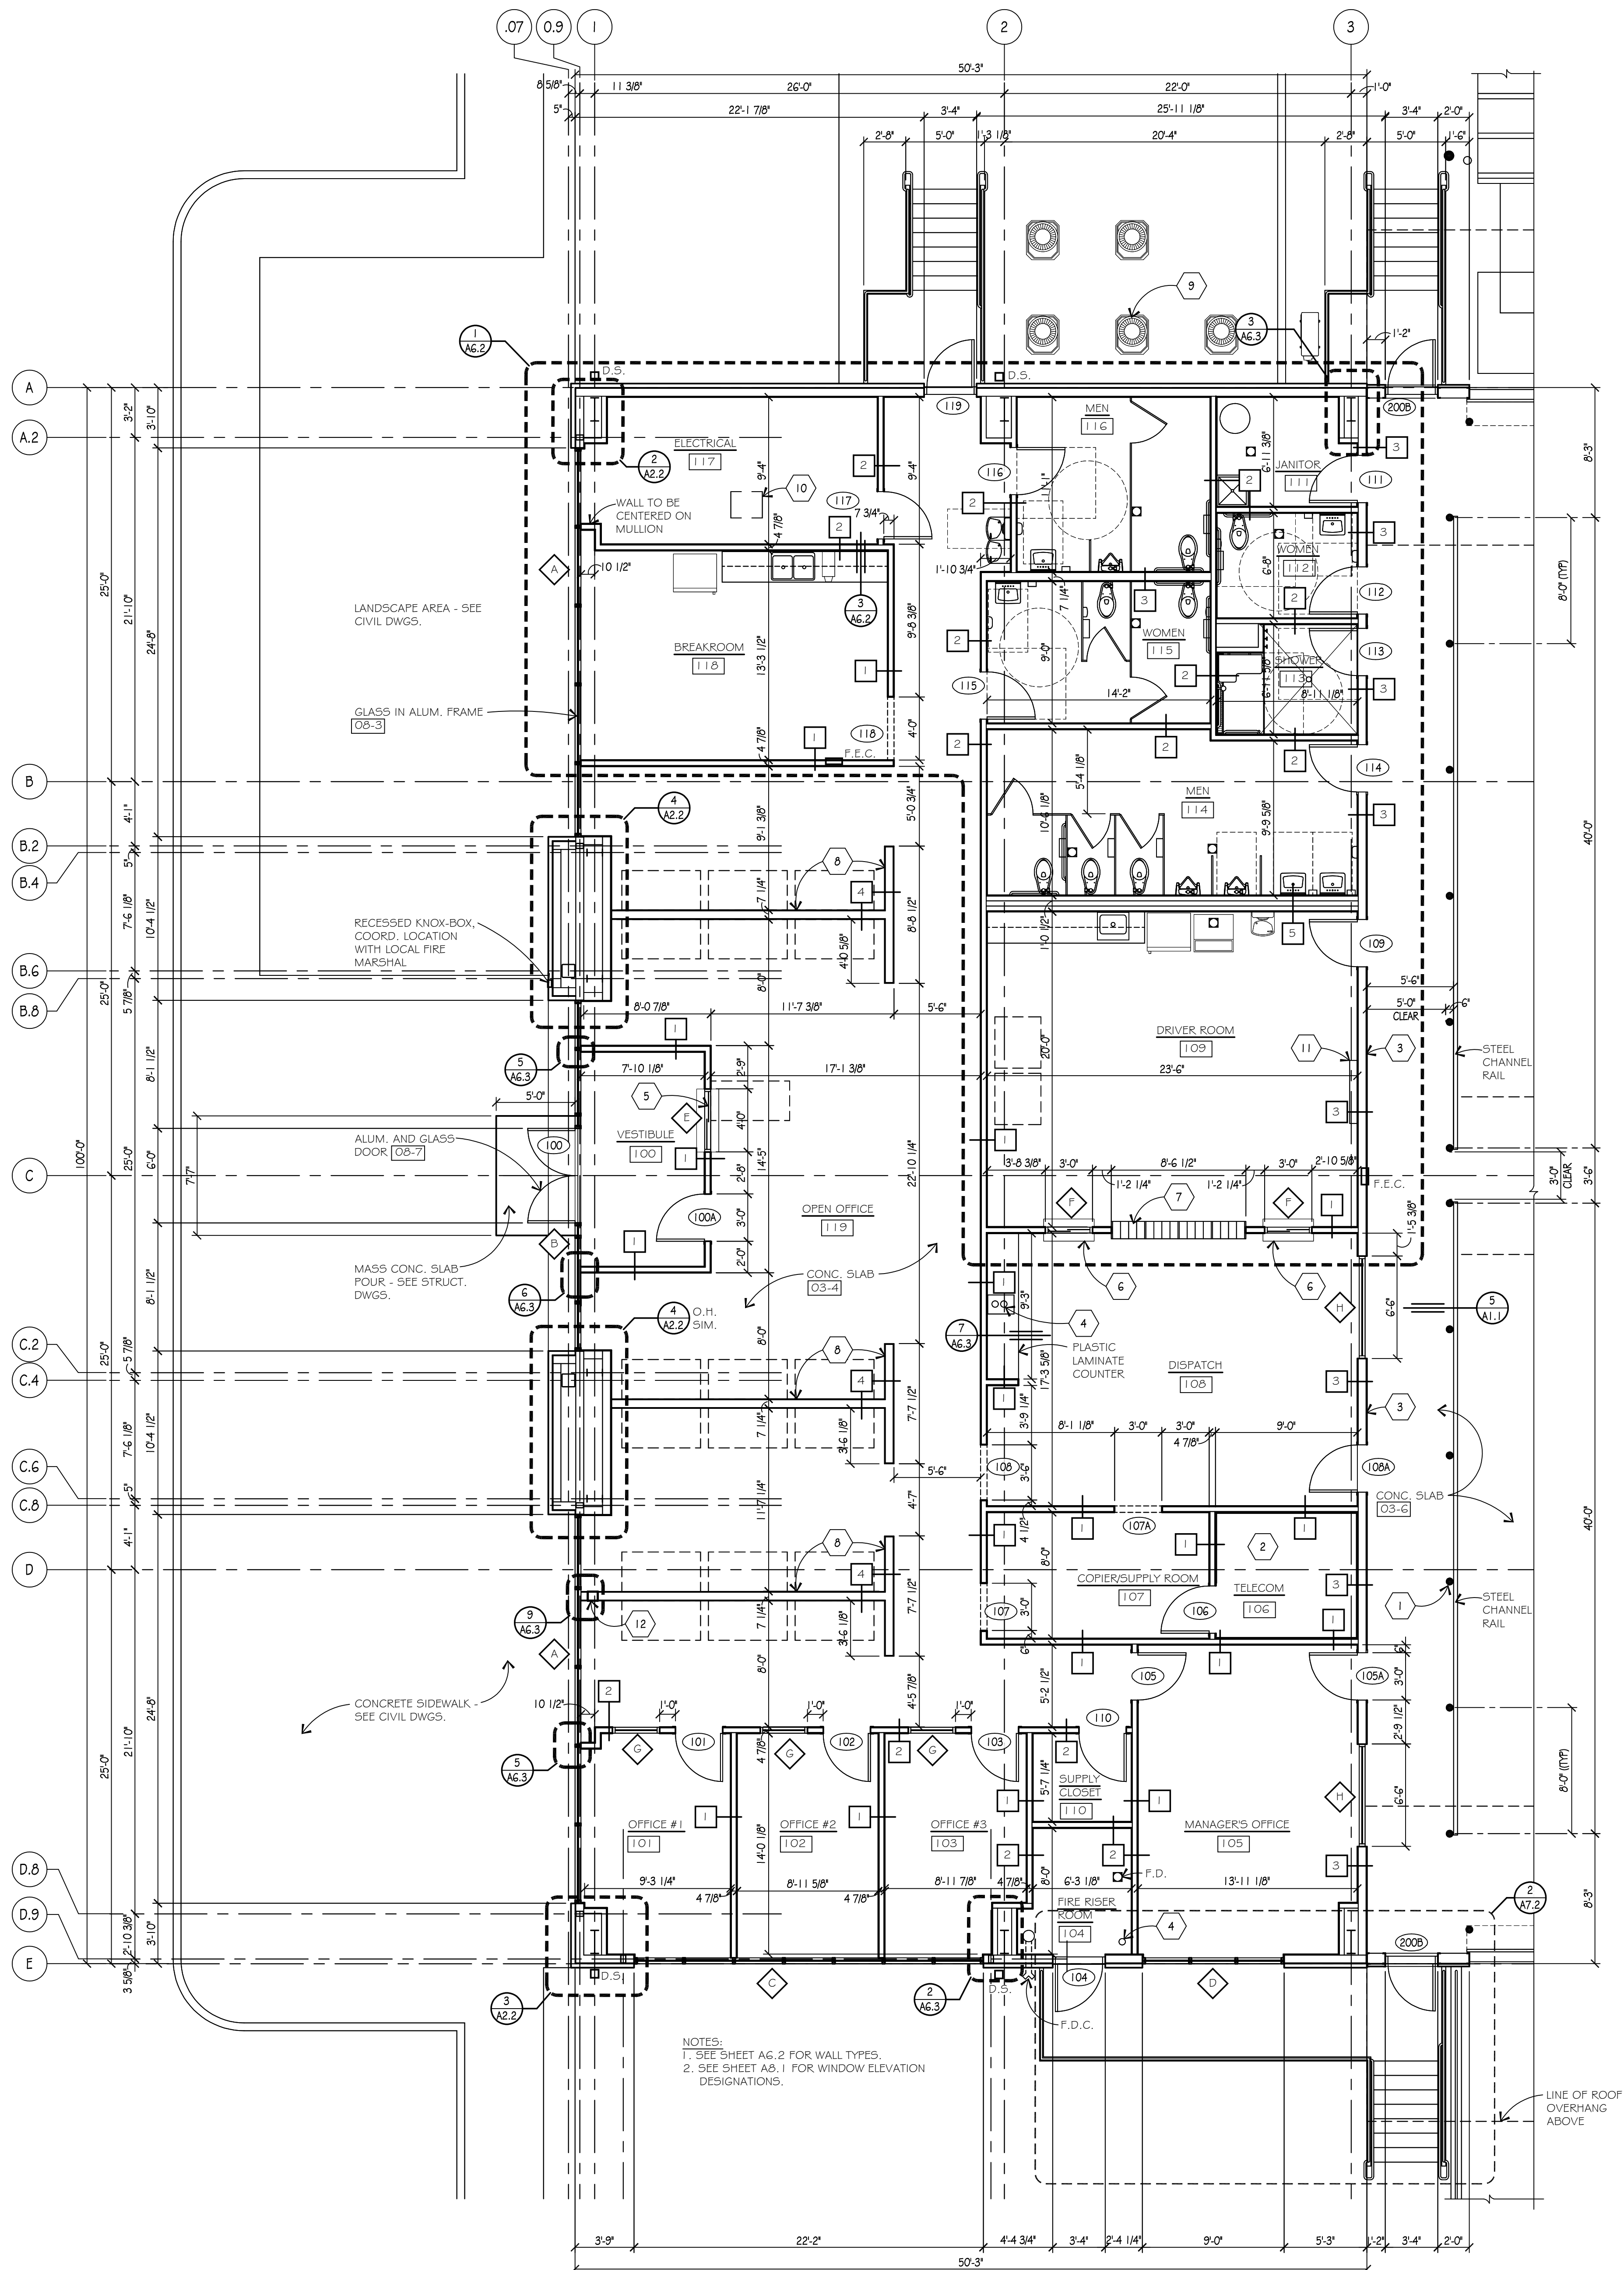



NOTES:  
1. SEE SHEET A6.2 FOR WALL TYPES.  
2. SEE SHEET A6.1 FOR WINDOW ELEVATION DESIGNATIONS.

ENLARGED OFFICE FLOOR PLAN

SCALE: 3/16" = 1'-0"

1  
A6.1

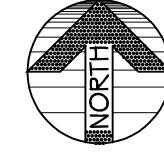

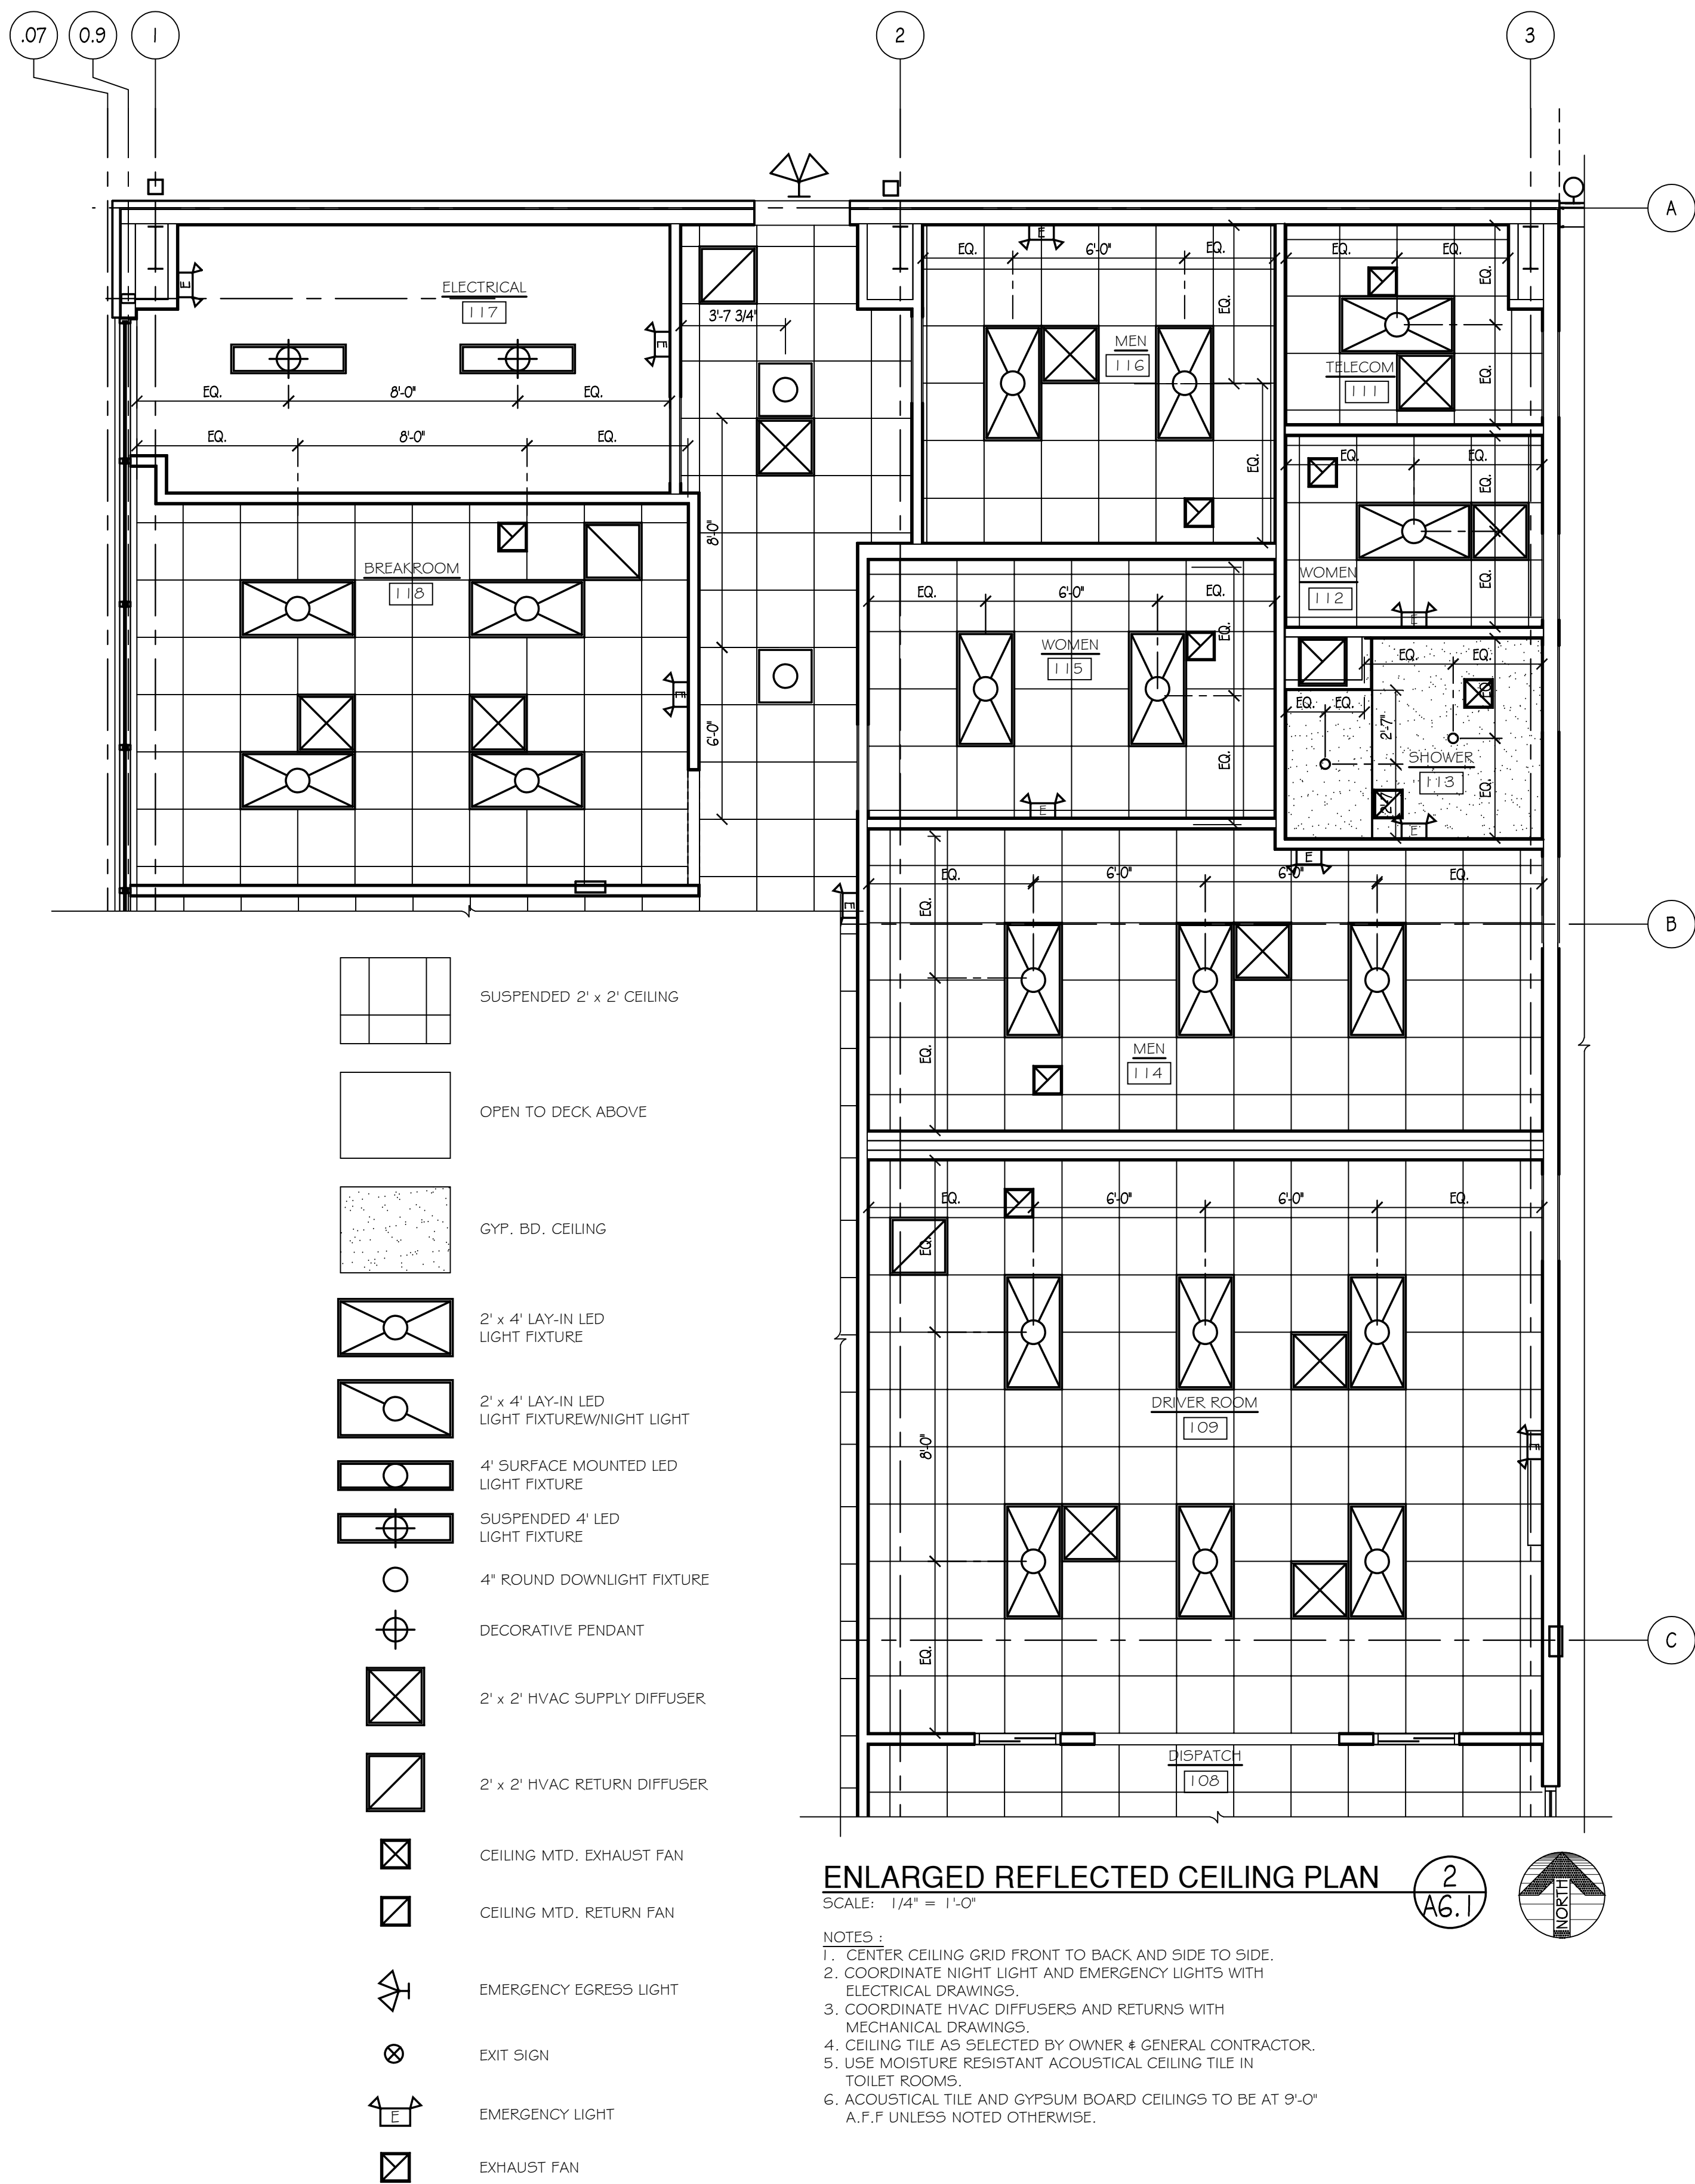


### KEY NOTES

1. REFRIGERATOR PROVIDED BY OWNER, INSTALLED BY GENERAL CONTRACTOR.
2. FLOOR MOUNTED ICE MAKER PROVIDED BY OWNER, INSTALLED BY GENERAL CONTRACTOR.
3. COUNTER MOUNTED COFFEE MAKER PROVIDED BY OWNER, INSTALLED BY GENERAL CONTRACTOR. SEE PLUMBING DRAWINGS.
4. VENDING MACHINES BY OWNER.
5. MICROWAVE MOUNTED OVER SINK PROVIDED BY OWNER, INSTALLED BY GENERAL CONTRACTOR.
6. WALL MOUNTED DRINKING FOUNTAIN WITH BOTTLE FILLER, SEE PLUMBING DRAWINGS.
7. ELECTRICAL TRANSFORMER SUSPENDED FROM STRUCTURE ABOVE.
8. SEE ELECTRICAL DRAWINGS FOR ELECTRICAL EQUIPMENT LAYOUT IN THIS ROOM.
9. WATER HEATER - SEE PLUMBING DRAWINGS.


NOTES:

1. 3/4" FIRE TREATED PLYWOOD TO 8'-0" A.F.F. ALL WALLS IN ELECTRICAL ROOM.
2. PROVIDE (2) 2" CONDUIT INTO DOCK SPACE, SEE ELECTRICAL DRAWINGS.

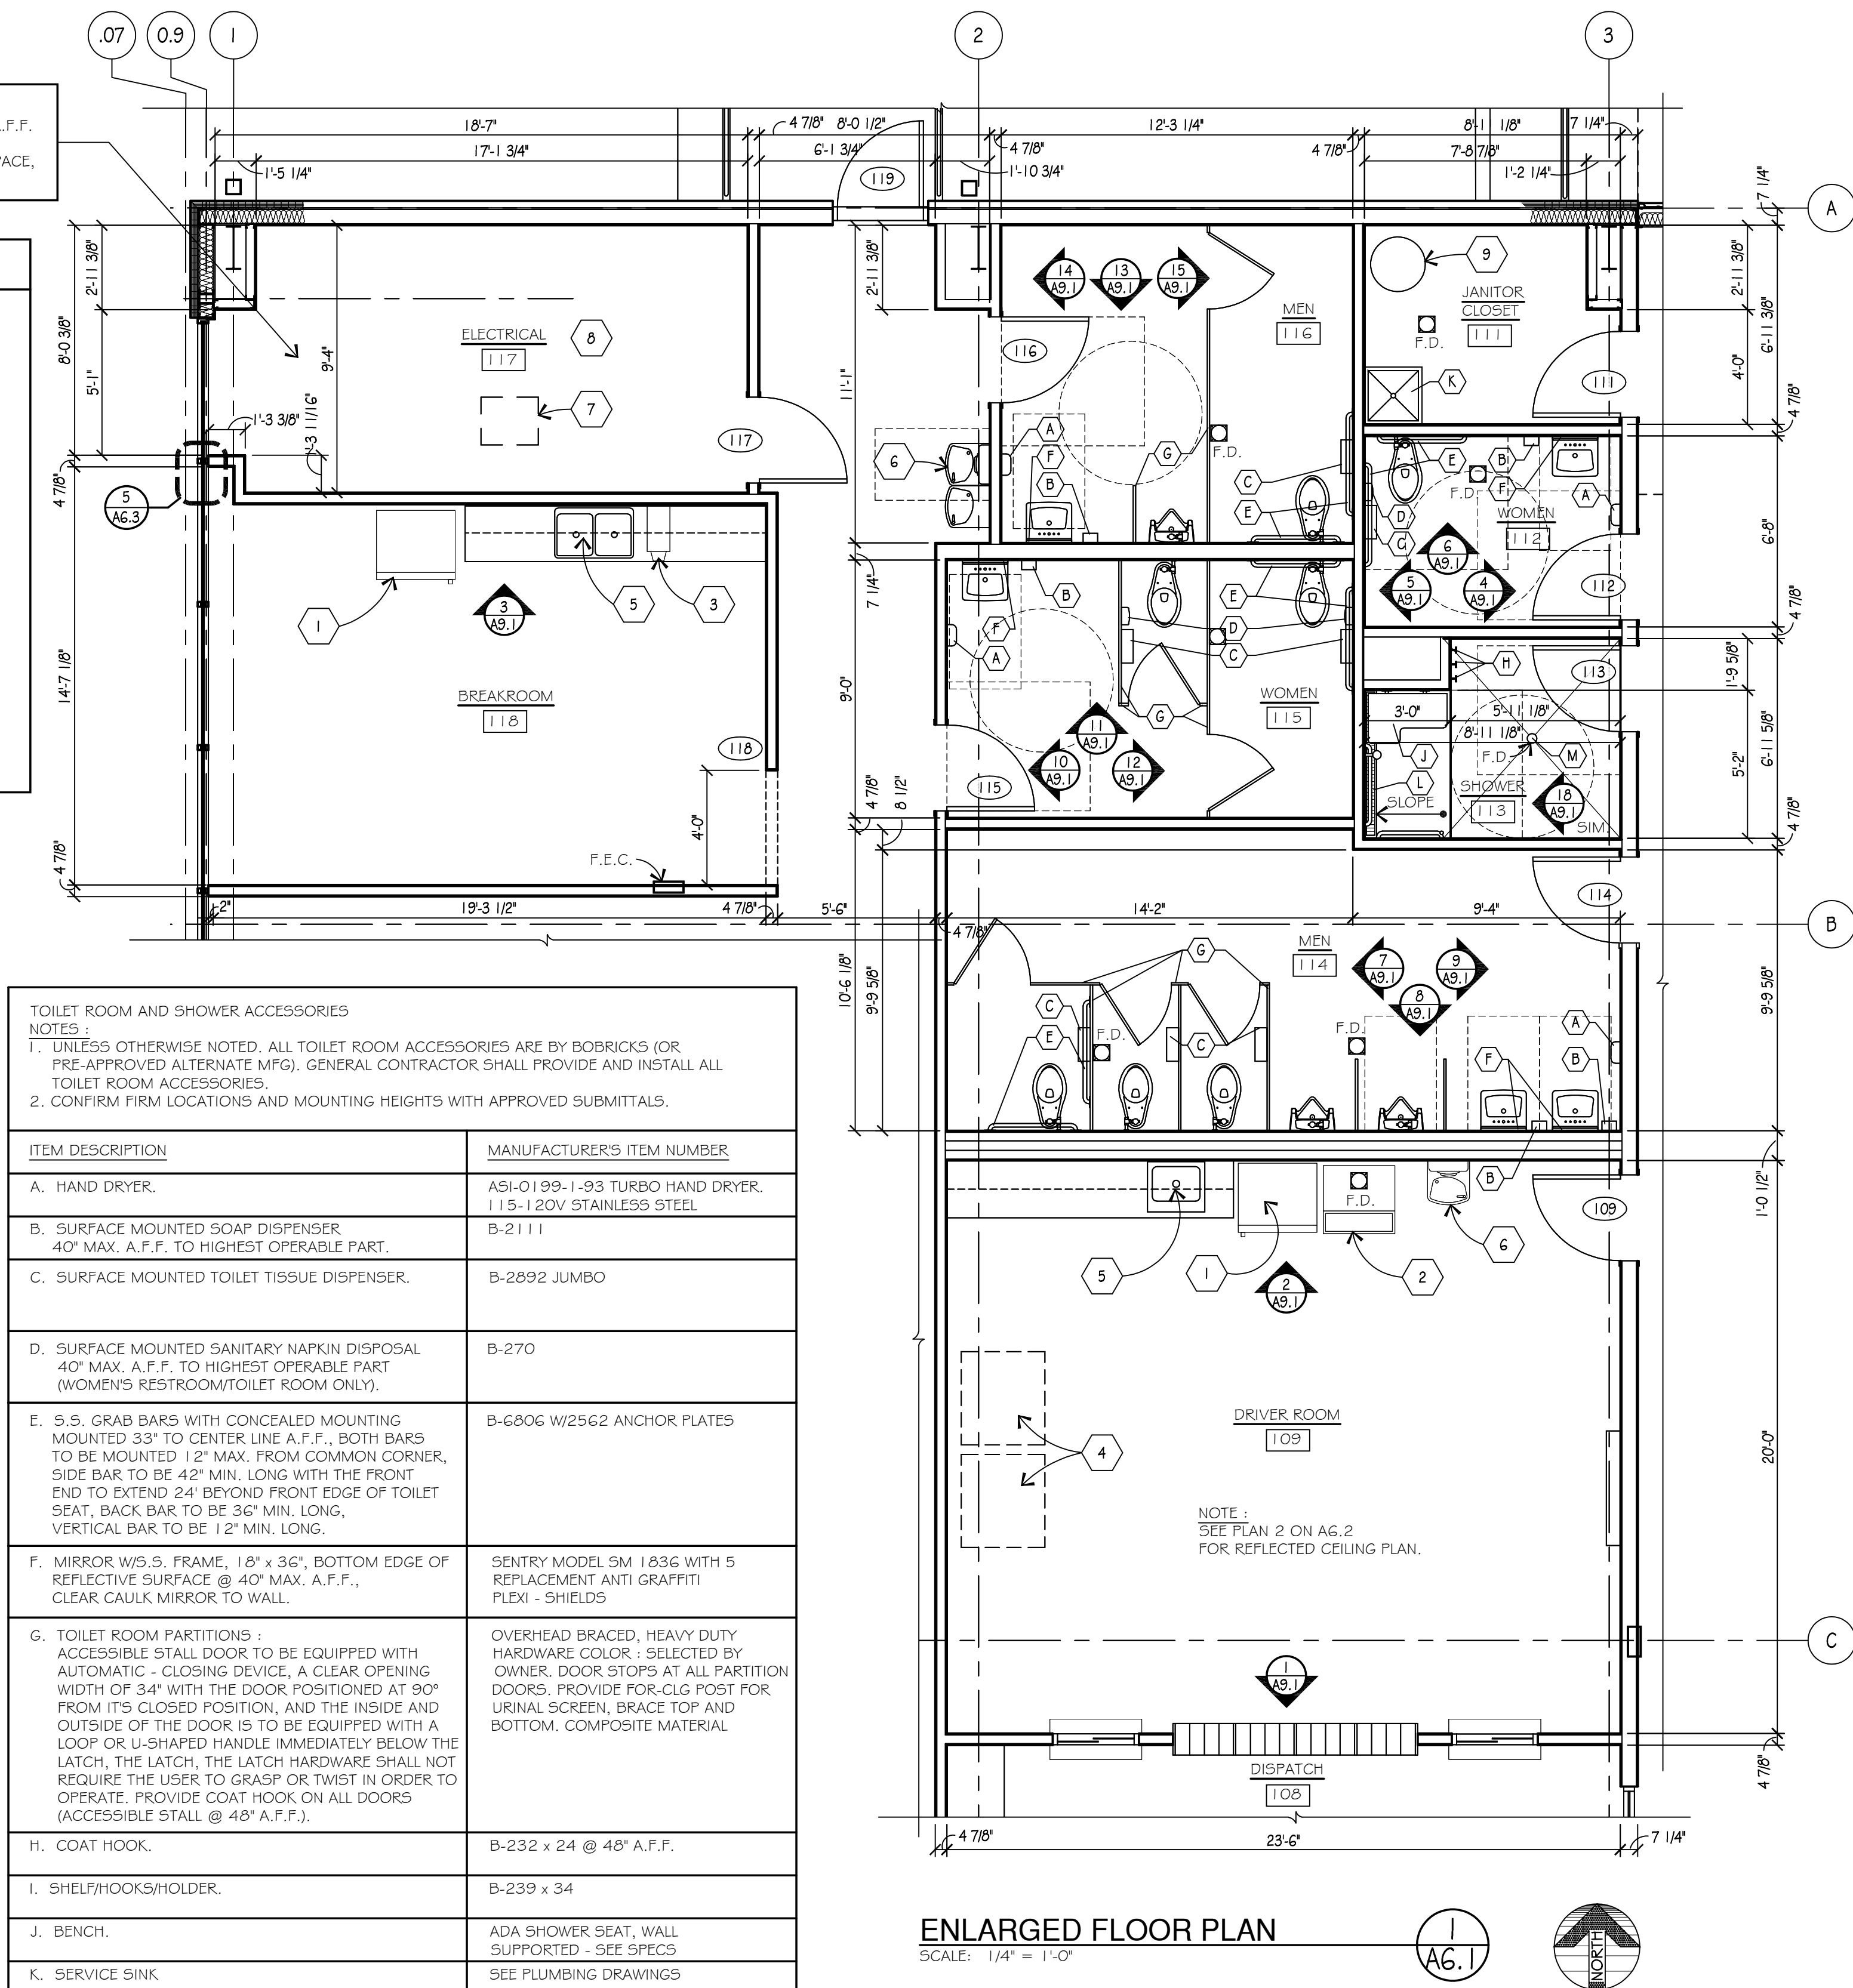


### GENERAL NOTES

1. PROVIDE CEMENTITIOUS WALL BOARD IN LIEU OF 5/8" GYPSUM BOARD AT ALL WALLS TO RECEIVE PORCELAIN TILE, CERAMIC TILE OR FRP.
2. WHERE U.L. ASSEMBLIES OR OTHER TESTED ASSEMBLIES ARE INDICATED, COMPLY WITH DETAILED REQUIREMENTS SHOWN ON U.L. ASSEMBLY SHEETS. U.L. ASSEMBLIES (OR OTHER TESTED ASSEMBLIES) REQUIREMENTS OVERRIDE THE STANDARD WALL PARTITION DETAILS.
3. INSTALL GYPSUM BOARD CONTROL JOINTS AT 30'-0" O.C. MAXIMUM, TYPICAL.
4. INTERIOR ROOF BATT INSULATION TO MEET MINIMUM JURISDICTION REQUIREMENTS.
5. INSULATION INSTALLED ALONG EXTERIOR WALL FURRING AND ROOF SPACES TO BE INSTALLED WITHOUT GAPS OR VOIDS; DO NOT COMPRESS INSULATION. REFER TO R VALUES INDICATED ON DRAWINGS.
6. MAXIMUM CLEAR SPANS HEIGHT FOR INTERIOR METAL STUDS SHALL BE SUCH THAT DEFLECTION SHALL NOT EXCEED L/360 UNDER A 5 PSF LOAD (CERAMIC TILE FINISH AND/OR WALLS TO DECK). SEE SPECIFICATIONS FOR ADDITIONAL INFORMATION.

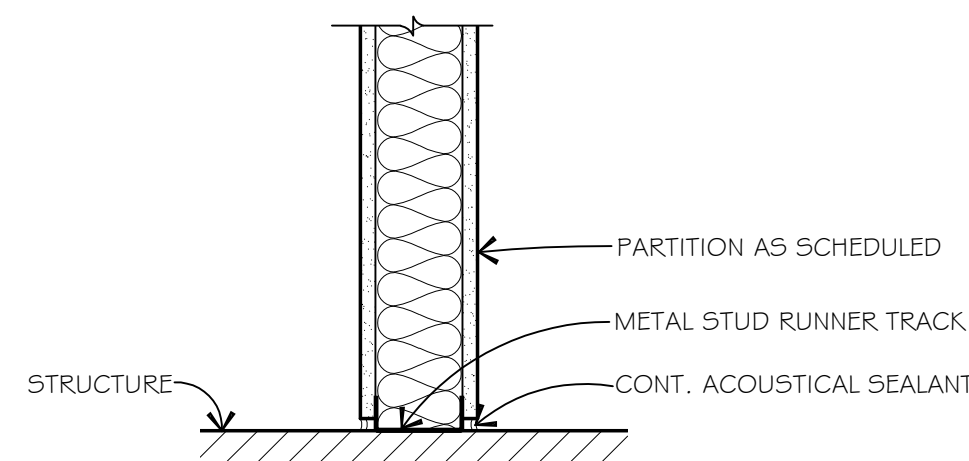


SILL 1

SCALE: 1-1/2" = 1'-0"

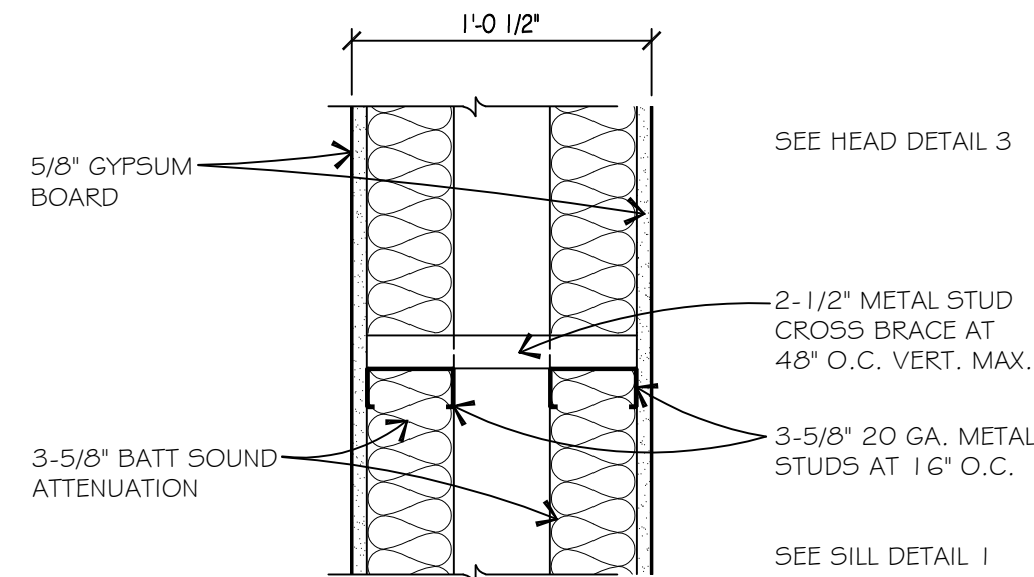


PARTITION TYPE 5

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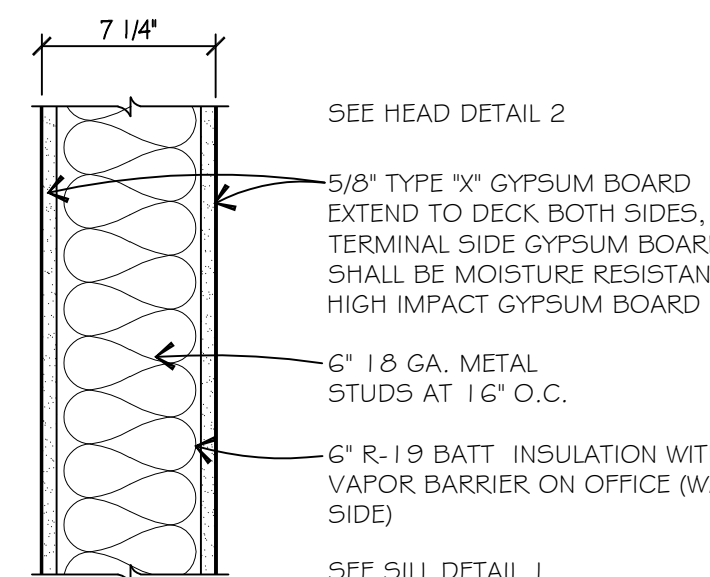
PARTITION TYPE 4
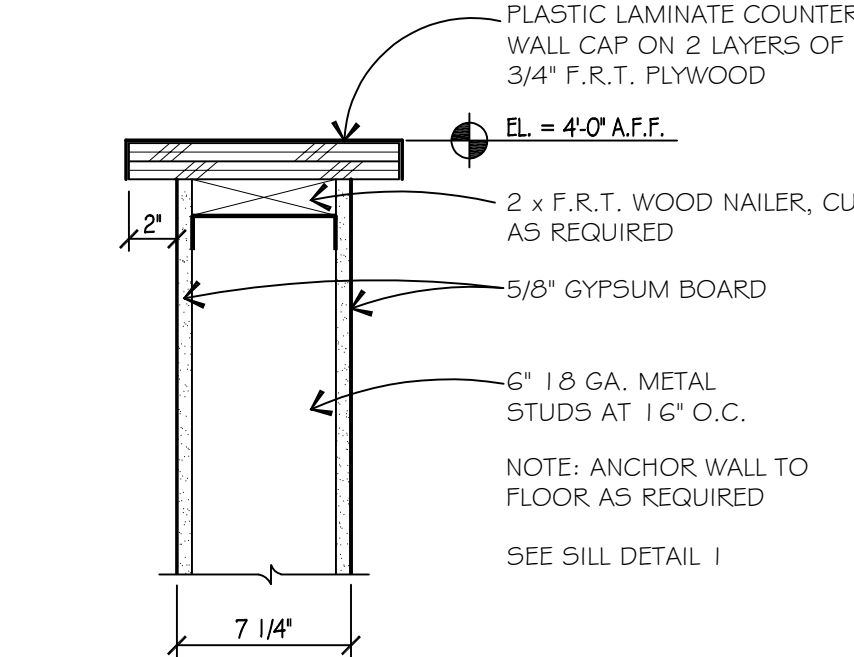
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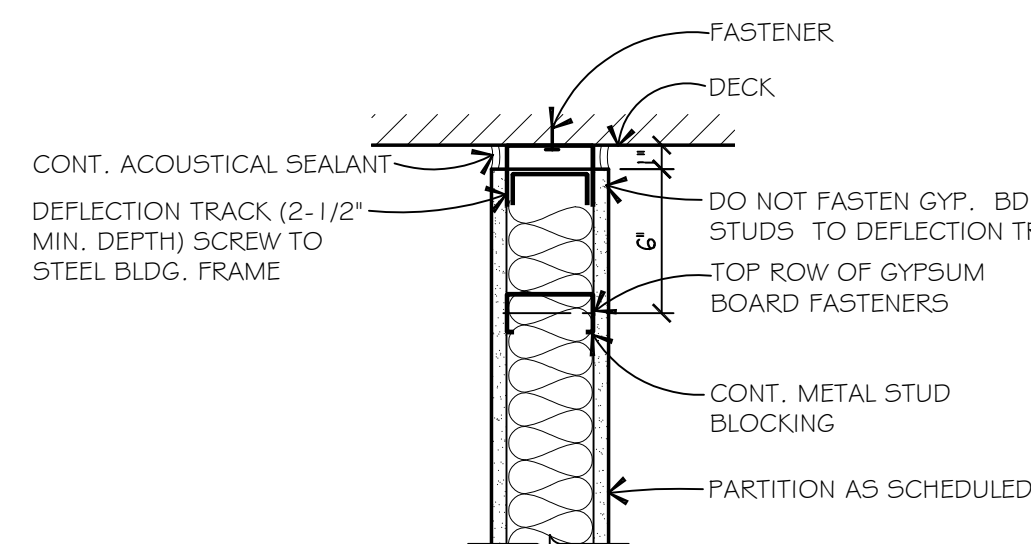
HEAD 3

SCALE: 1-1/2" = 1'-0"

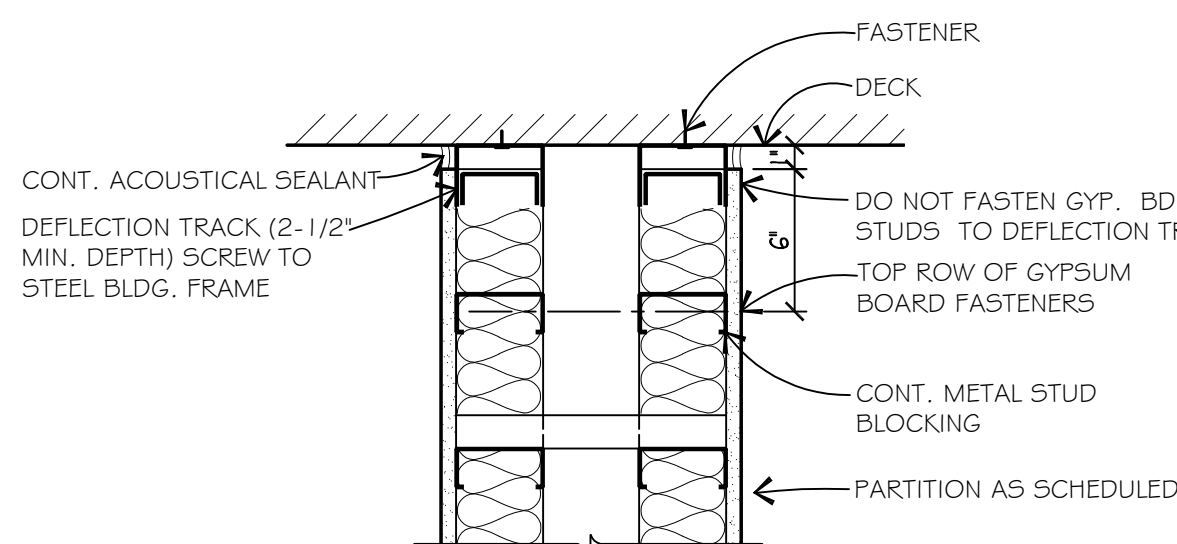


PARTITION TYPE 3

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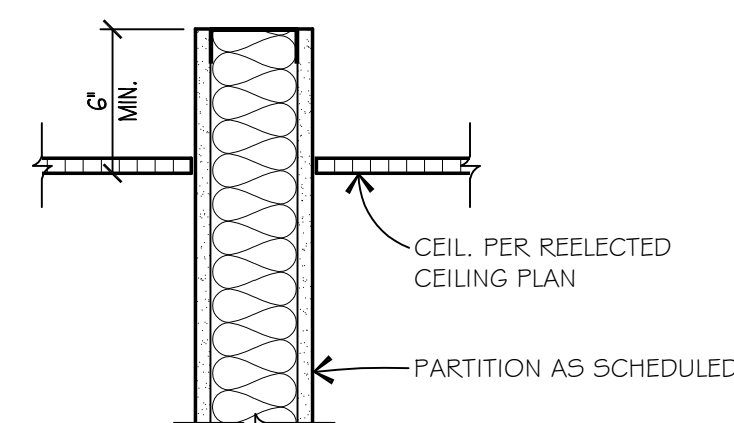
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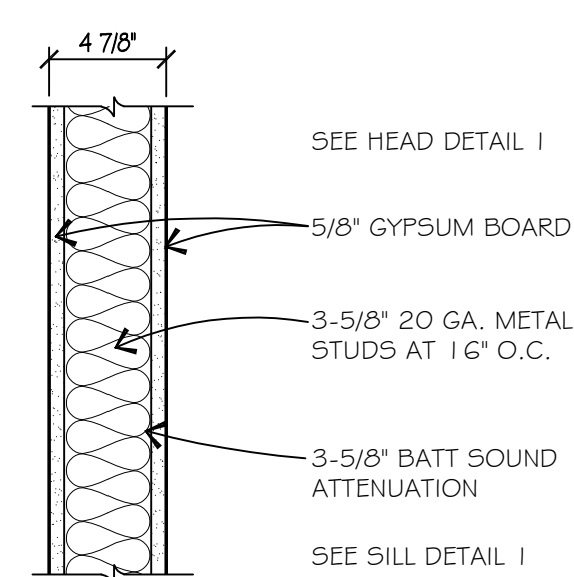
PARTITION TYPE 2

SCALE: 1-1/2" = 1'-0"



HEAD 1

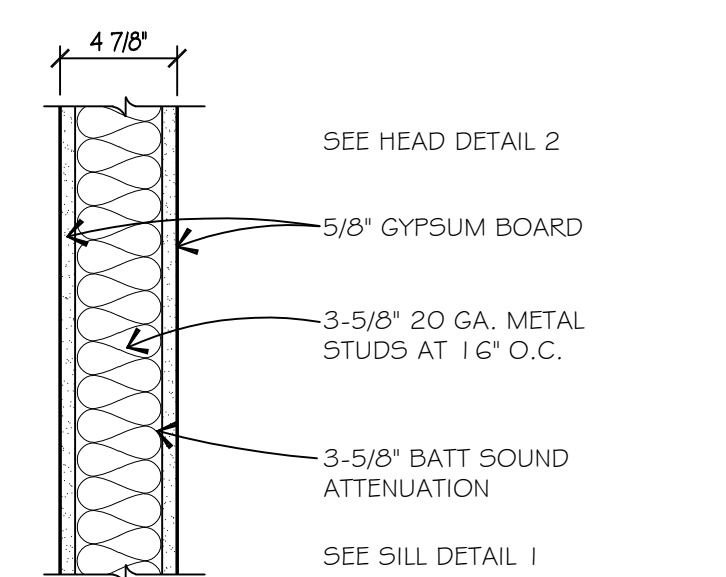SCALE: 1-1/2" = 1'-0"



PARTITION TYPE 1

SCALE: 1-1/2" = 1'-0"




FINISH SCHEDULE : TERMINAL & MAINTENANCE BUILDINGS								
FINISH SCHEDULE - COOL SCHEME								
CODE	MATERIAL	MANUFACTURER	DESCRIPTION	COLOR	DEALER	REP. NAME	CONTACT NO.	REMARKS
FLOOR								
F1	TILE	CROSSVILLE TILE	SIDEWALK SERIES	BC006 TIC TAC TOE				VERIFY PATTERN WITH OWNER
F2	SEALED CONCRETE		SEALED CONCRETE	CLEAR				SEE SPEC. FOR SEALER TYPE AND LOCATIONS
F3	POLISHED CONCRETE	CLEAR						
F4	PAINT		EPOXY PAINT	WHITE				TYPICAL FOR SAFETY AND SERVICE PIT FLOORS, VERIFY COLOR WITH OWNER
BASE								
B1	TILE		TILE GREY					WALL TILE TO FLOOR AND CAULK
B2	TILE							
B3	RUBBER		ATLAS CONCORDE USA : FRAY COLLECTION : 6' x 12' COVE BASE : ALIGN TO FLOOR	WHITE				
WALL								
W1	CERAMIC TILE	CROSSVILLE TILE	SIDEWALK SERIES	BC003 JACKS 12 x 24 : GROUT : FLEXCOLOR CQ PEWTER				
W2	PAINT	SHERWIN WILLIAMS	OFFICE GYP. BD. WALLS (NON-CERAMIC TILE)	SW7016 - MINDFUL GRAY				
W3	PAINT	SHERWIN WILLIAMS	GWB - SW ENAMEL	ARCTIC WHITE				
W4	METAL PANEL			GRAY				
W5	PAINT		EPOXY PAINT	WHITE				TYPICAL ON TRUCK WASH INTERIOR CONCRETE BLOCK WALLS AND SAFETY AND SERVICE LANE PIT WALLS, VERIFY COLOR WITH OWNER
CEILING								
C1	GYP. BD.	SHERWIN WILLIAMS	FLAT LATEX : OFFICE GYP. BD. CEILINGS	SW7007 - WHITE				
C2	OPEN TO STRUCTURE		SEE PLAN FOR LOCATION					
CP1	ACOUSTICAL CEILING TILE - 1	ARMSTRONG	STANDARD 2 x 2 OFFICE TILE : CORTEGA #769 (TYP.)					
CP2	ACOUSTICAL CEILING TILE - 2	ARMSTRONG	2 x 2 x 1/2" ROCKFON ARCTIC SQUARE REGULAR NARROW #5LN 620 WITH 9/16" SUSPENSION GRID					


PAINTING / FINISH SCHEDULE SUPPLEMENT : TERMINAL & MAINTENANCE BUILDINGS

TERMINAL BUILDING		MAINTENANCE BUILDING	
DESCRIPTION	COLOR	DESCRIPTION	COLOR
4'-2" HT DOCK WALL	NO PAINT - EXPOSED CONCRETE	PIPE BOLLARDS	SAFETY YELLOW - #SW4048
1'0" DOCK PERIMETER CHANNEL - 1'0" FACE	GRAY (MATCH DOCK LEVELERS)	PIT ANGLES EMBEDS	SAFETY YELLOW - #SW4048
1'0" DOCK PERIMETER CHANNEL - 3' FACE	GRAY (MATCH DOCK LEVELERS)	PIT STAIR CASES	SAFETY YELLOW - #SW4048
DOCK LEVELER BUMPERS AND PLATES	GRAY (MATCH DOCK LEVELERS)	BOX AT DOCK FIRE EXTINGUISHER LOCATIONS	SAFETY RED
PIPE BOLLARDS	SAFETY YELLOW - #SW4048	SHOP - OFFICE WALL (MAINTENANCE SIDE) AND SHOP 8'-0" HIGH PERIMETER CMU WALL	#SW7018 - DOVETAIL
STEEL STAIRCASES	SAFETY YELLOW - #SW4048	H.M. PERSONNEL DOOR & FRAMES (MAINTENANCE)	#SW7018 - DOVETAIL
DOCK WALL LADDERS	SAFETY YELLOW - #SW4048	H.M. PERSONNEL DOOR & FRAMES (OFFICE)	#SW7018 - DOVETAIL
DOCK STANDS	GREEN R+L	OFFICE GYPSUM BOARD AND CMU WALLS	#SW7016 - MINDFUL GRAY
DOCK STAND BOLLARDS	SAFETY YELLOW - #SW4048	PARTS ROOM WALLS	ARCTIC WHITE - HIGH GLOSS ENAMEL
RAMP HANDRAILS	GREEN R+L	I.T., COMPRESSOR, AND ELECTRICAL ROOM ROOM PLYWOOD WALLS	ARCTIC WHITE - HIGH GLOSS ENAMEL
DOCK 1/2 GA OVERHEAD DOOR JAMBS	ARCTIC WHITE - HIGH GLOSS ENAMEL	OFFICE GYP. BD. CEILINGS	ARCTIC WHITE - HIGH GLOSS ENAMEL
DOCK OVERHEAD DOOR HEADER GIRT (EXTERIOR)	ARCTIC WHITE - HIGH GLOSS ENAMEL	OFFICE FLOORS (U.O.N.)	POLISHED CONCRETE WITH NON-SLIP FINISH (CLEAR)
DOCK OFFICE WALL (DOCK SIDE)	#SW7018 - DOVETAIL	TRUCK HEATER POSTS	SAFETY YELLOW - #SW4048
FIRE PROTECTION ROOM	#SW7018 - DOVETAIL		
DOCK PERSONNEL DOORS AND H.M. FRAMES (DOCK AND EXTERIOR SIDES)	#SW7018 - DOVETAIL		
BOX AT DOCK FIRE EXTINGUISHER LOCATIONS	SAFETY RED		
BUILDING MOUNTED LIGHT POLES	FACTORY FINISH		
OFFICE GYP. BD. WALLS (NON-CERAMIC TILE)	#SW7016 - MINDFUL GRAY		
OFFICE TRIM, COVE BASE & INTERIOR DOORS	#SW7018 - DOVETAIL		
OFFICE GYP. BD. CEILINGS	#SW7007 - WHITE - FLAT LATEX		
OFFICE GYPSUM BOARD WALLS - 6" RUBBER BASE	JOHNSONITE - 48 GRAY		
OFFICE COUNTERTOPS, WALL CAPS, WINDOW SILLS	FORMICA LAMINATE - GRAPHITE GRARIX (MATTE 515-58)		
CABINET / CASE WORK	WILSONART - LAMINATE ZANZIBAR - 7957 K18		
OFFICE FLOORS TO RECEIVE FLOOR TILE (U.O.N.)	CROSSVILLE TILE - SIDEWALK SERIES - (COLOR BC006 TIC TAC TOE) , GROUT - FLEXCOLOR CQ CHARCOAL, VERIFY PATTERN WITH OWNER		
OFFICE WALL TILE	CROSSVILLE TILE - SIDEWALK SERIES - (COLOR BC0003 JACKS) 12 x 24 , GROUT - FLEXCOLOR CQ PEWTER		


FINISH SCHEDULE NOTES :  
1. ALL STEEL ITEMS TO BE PAINTED ARE TO BE SHOP PRIMED AND PAINTED GREEN R+L.  
2. G.C. TO VERIFY WITH OWNER FOR PAINT COLORS.  
3. ALL PAINT COLORS ARE FROM SHERWIN WILLIAMS.

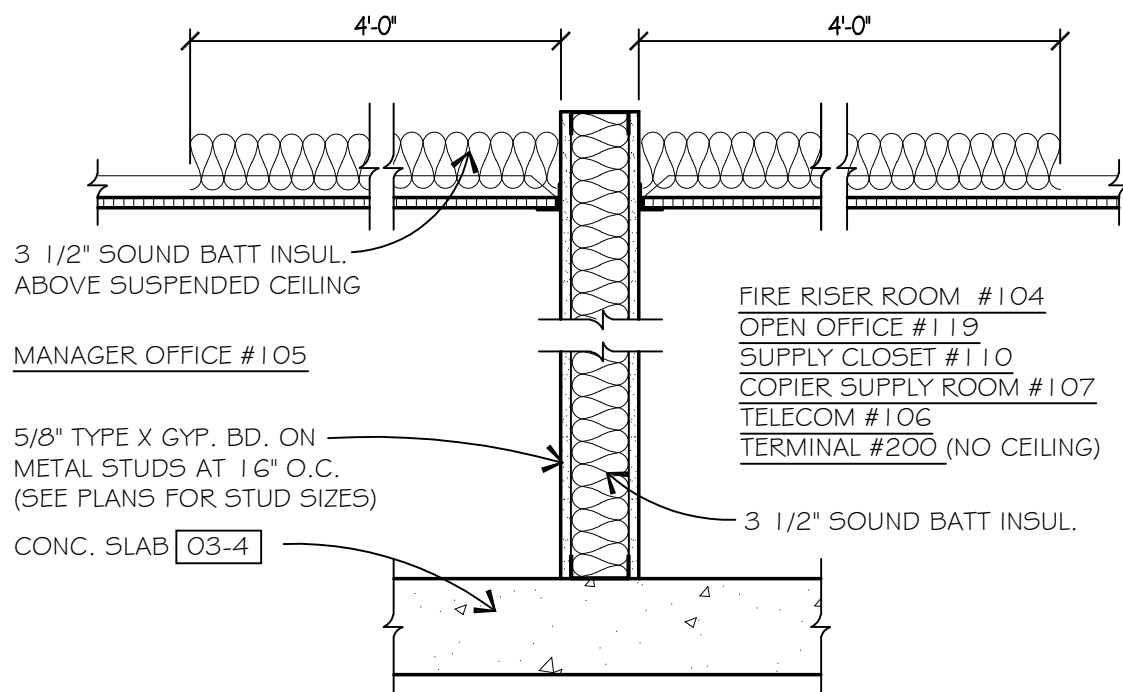


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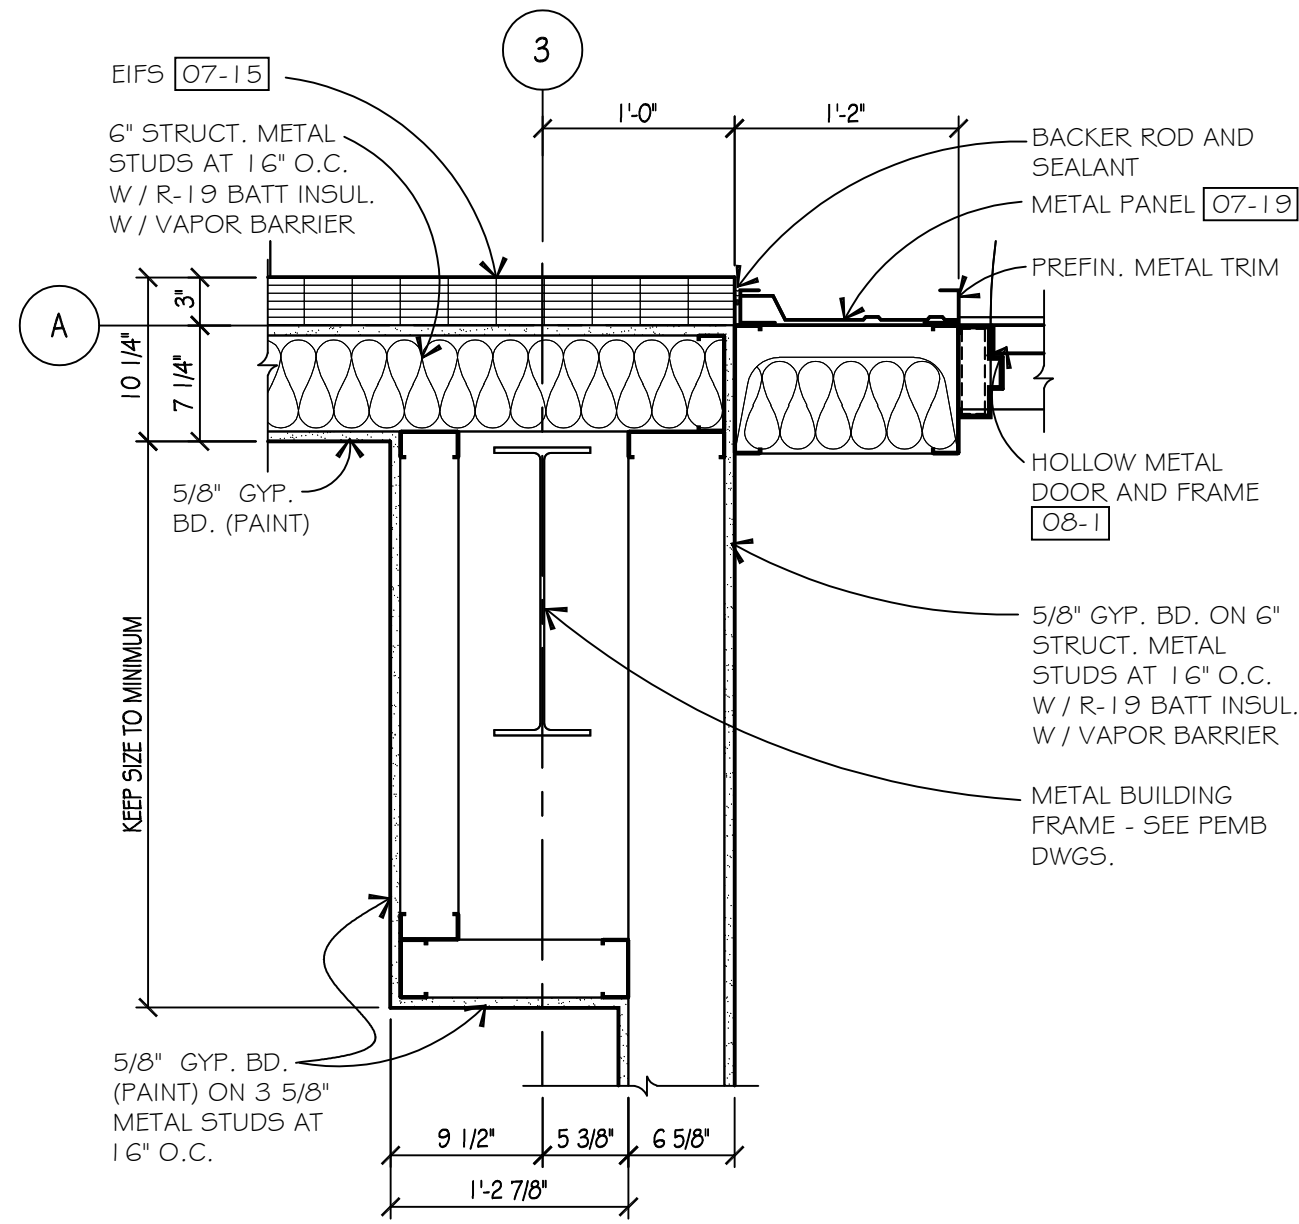
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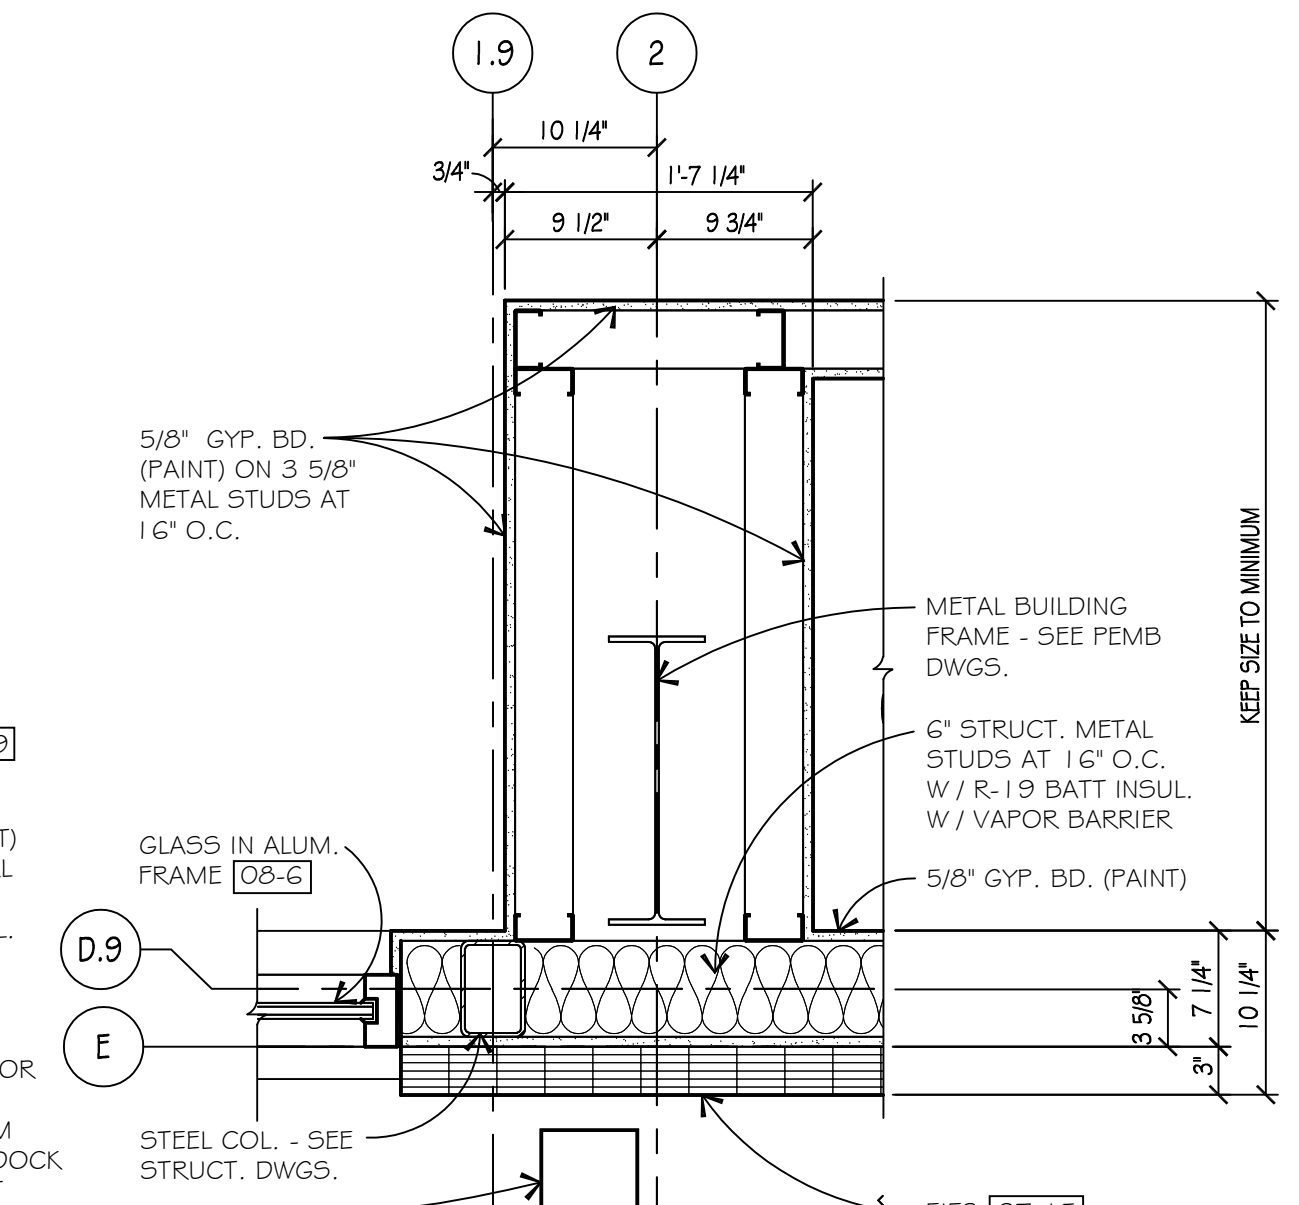
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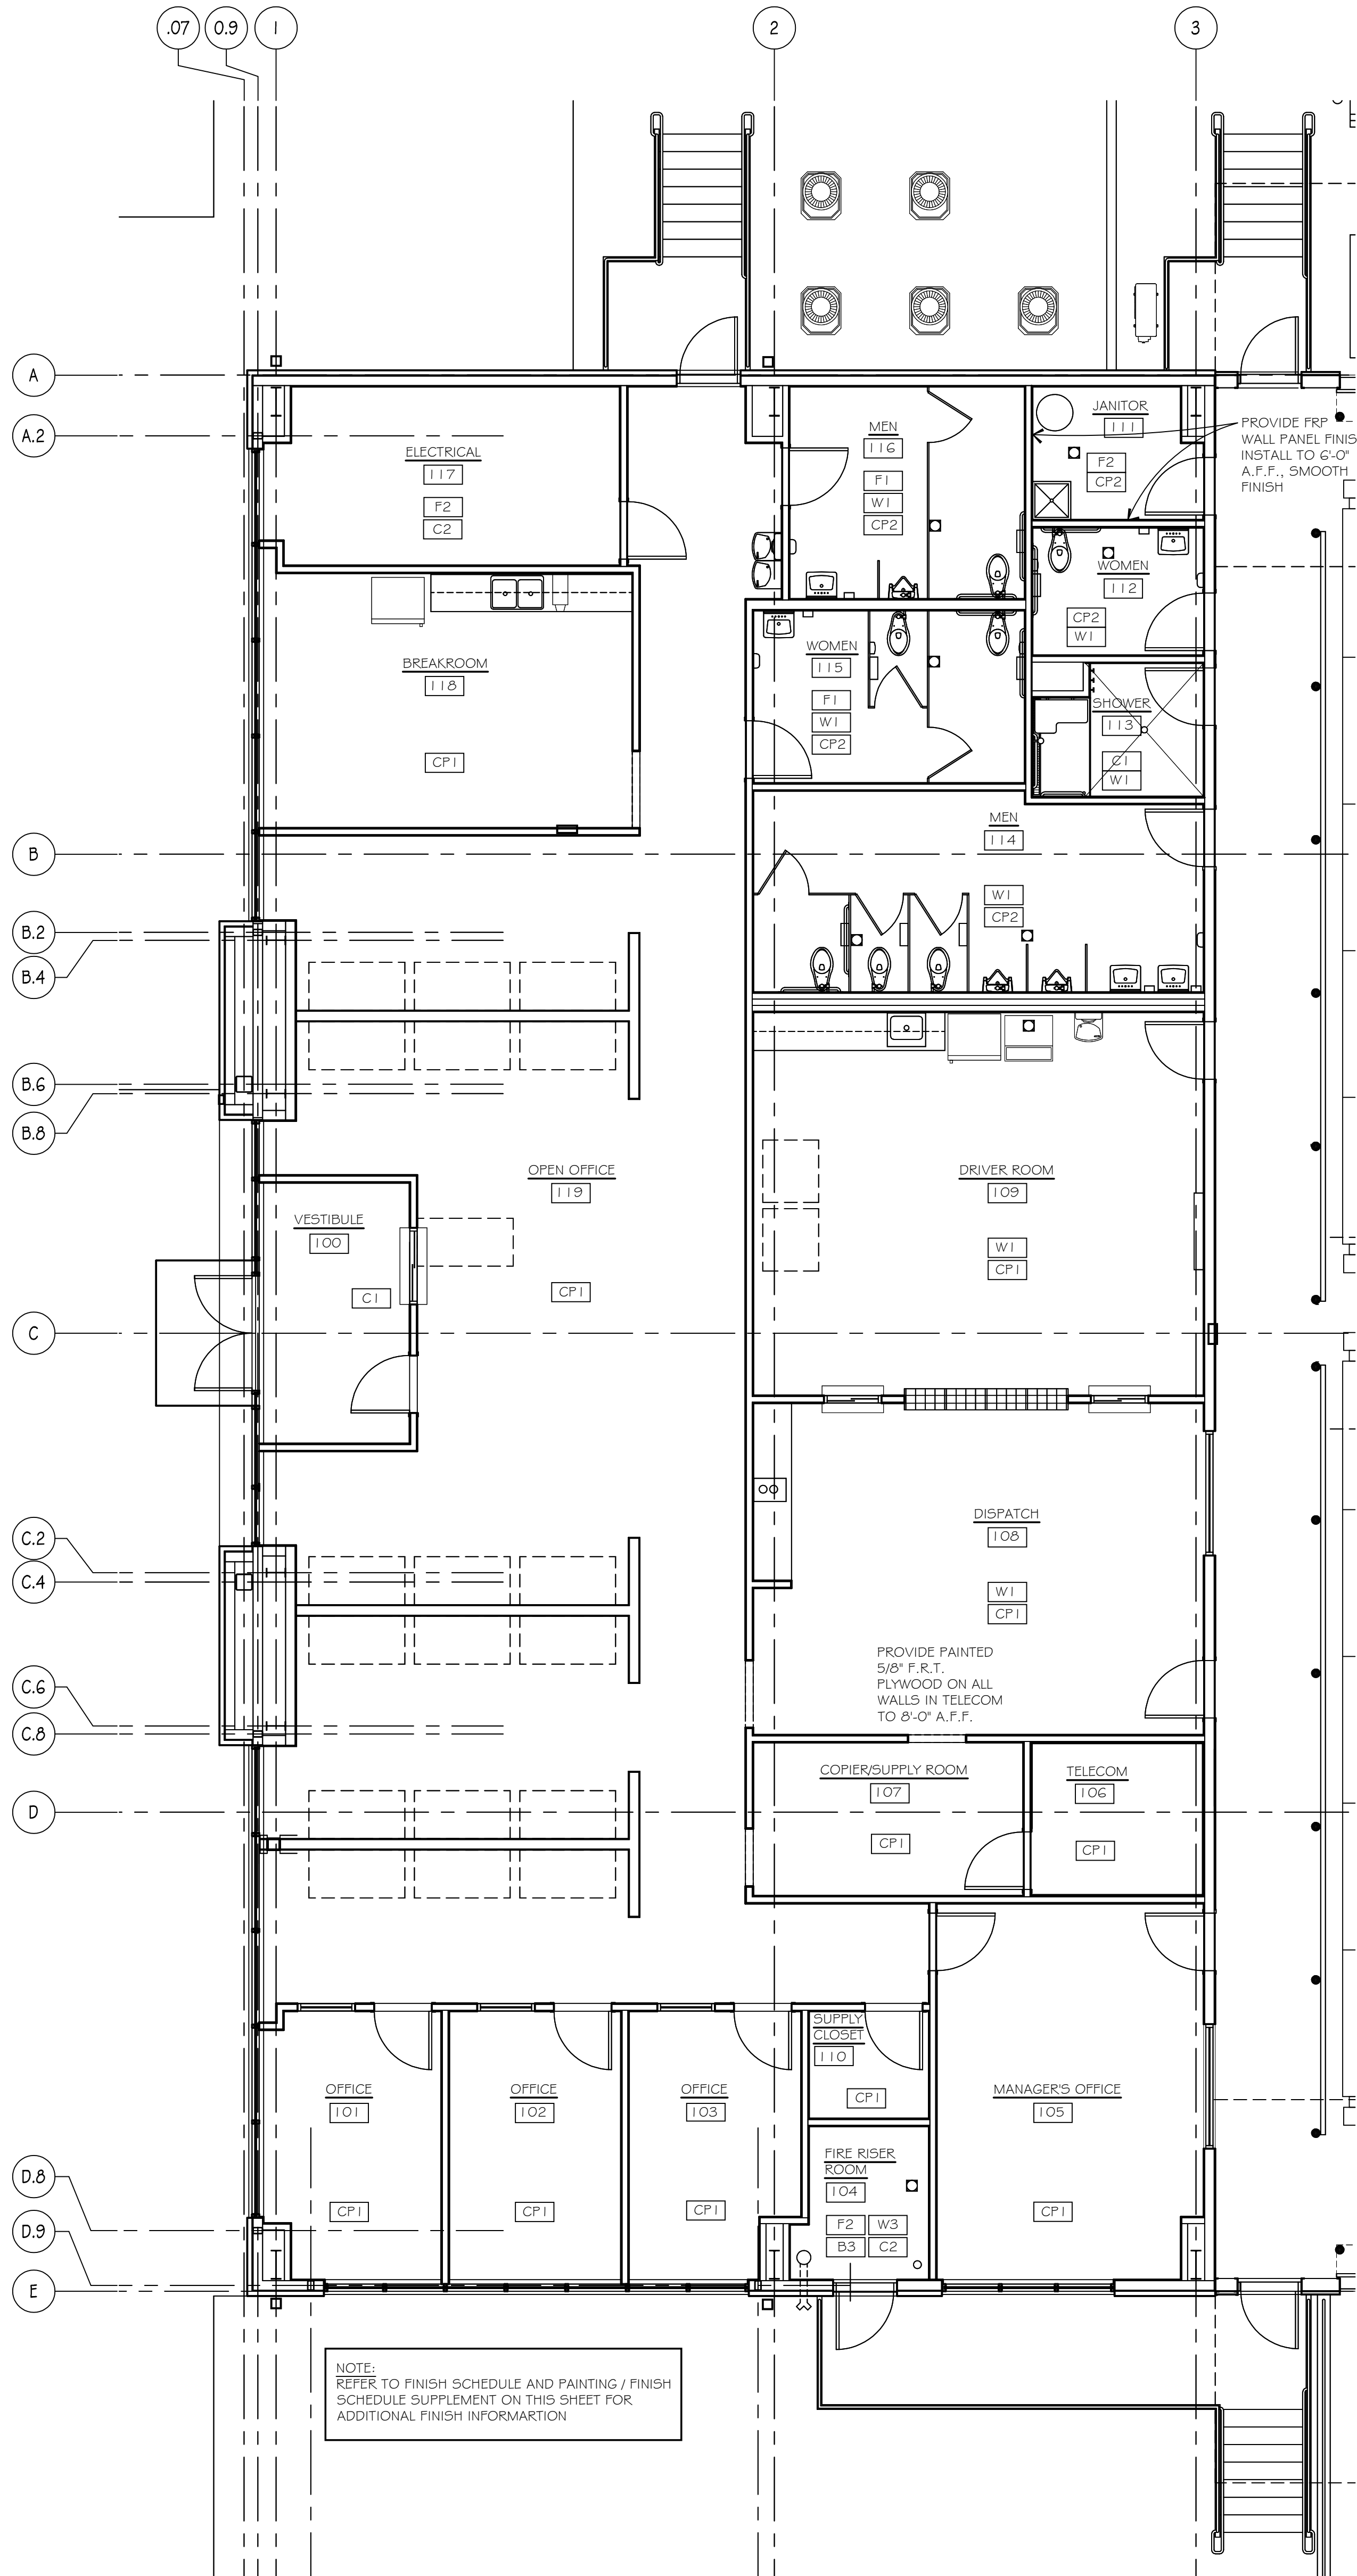
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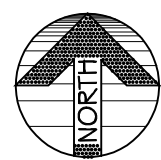
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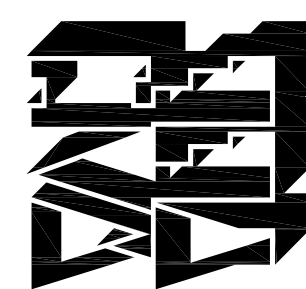
PLAN  
SCALE: 1" = 1'-0"

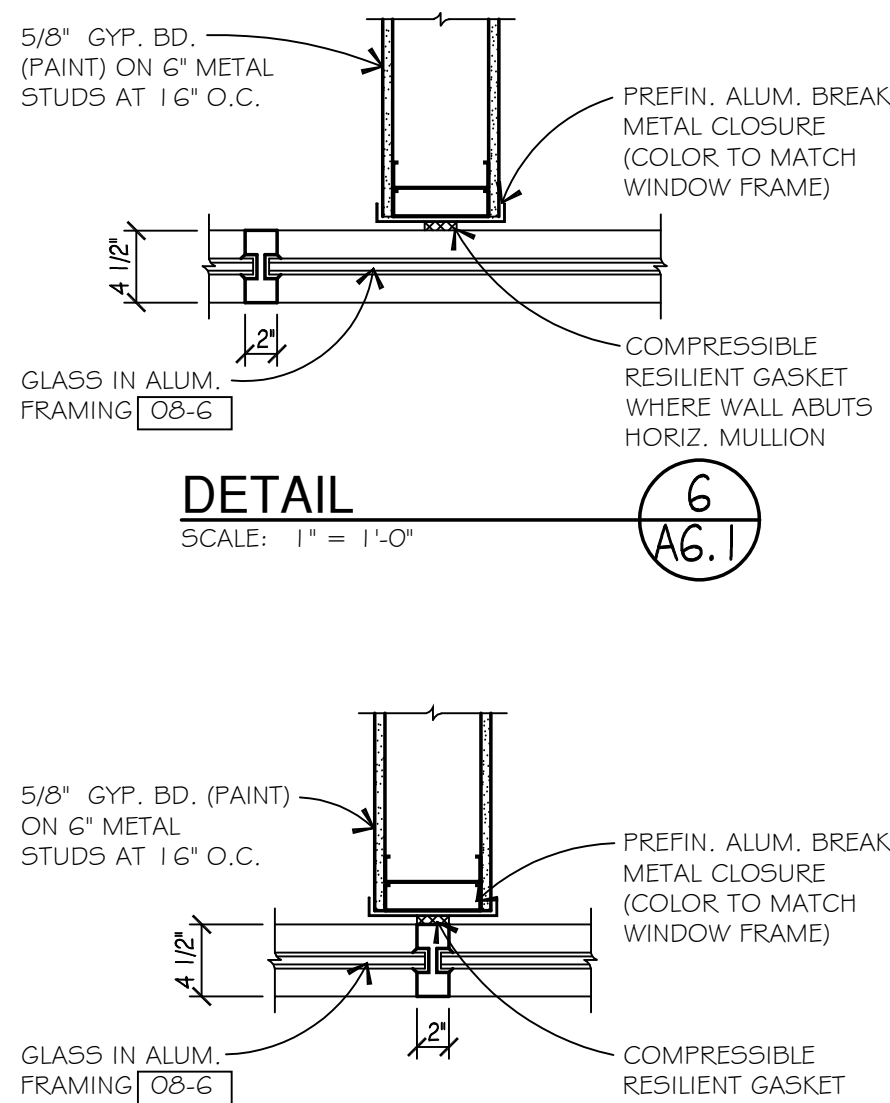

ENLARGED OFFICE FINISH FLOOR PLAN  
SCALE: 3/16" = 1'-0"

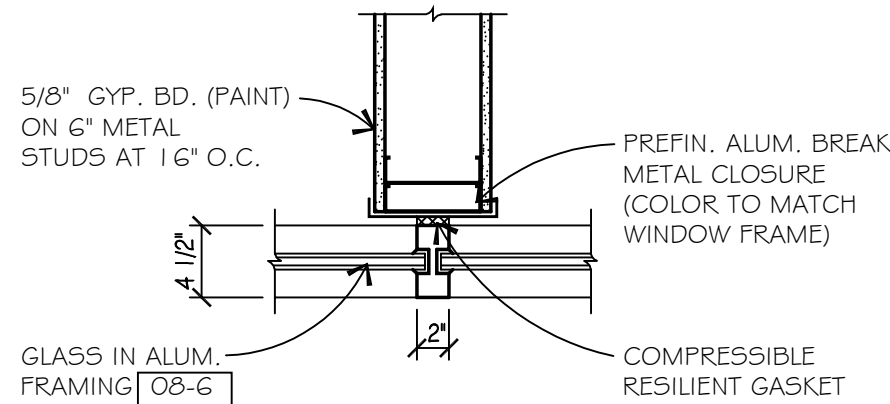

Won Yee Associates  
Architects & Planners  
400 GRANDVIEW AVENUE, SUITE 200  
EDMUNBURGH, INDIANA 46523  
PHONE 248.489.9160

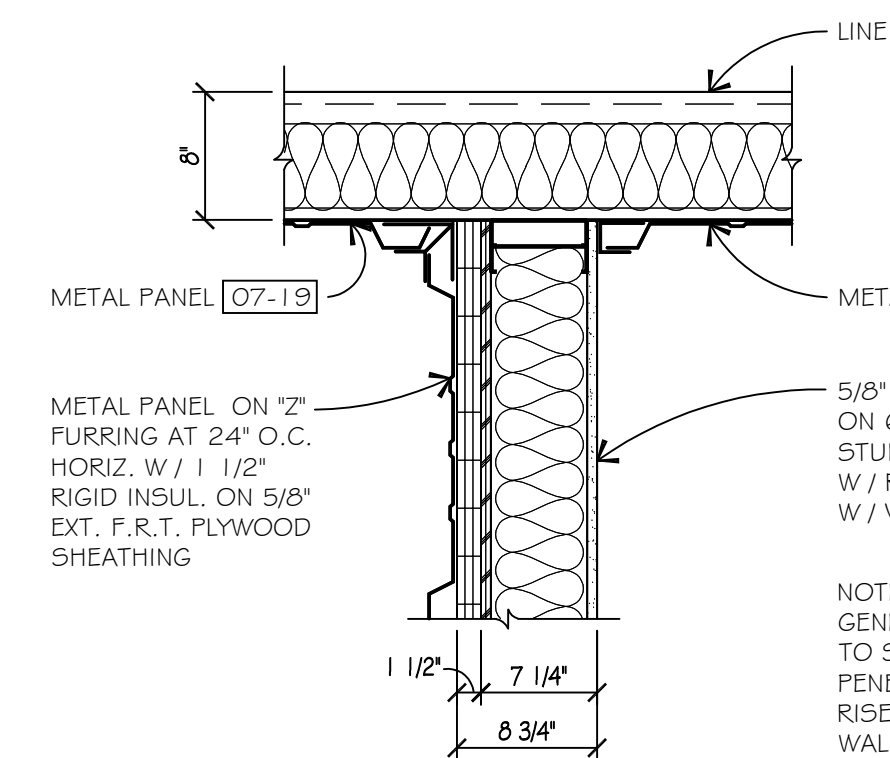

PROJECT  
**R + L CARRIERS**  
EDMUNBURGH, INDIANA



Date Issued  
Bids & Permit Oct. 8, 2021

Job Number  
5147











SHEET TITLE  
ENLARGED  
OFFICE 100  
FINISH FLOOR  
PLAN AND  
DETAILS

Sheet Number  
A6.3


Do not scale drawings - Use figured dimensions CAD DWG S147x61.DWG

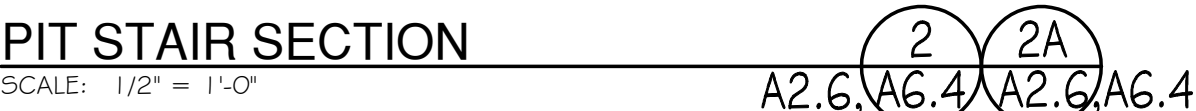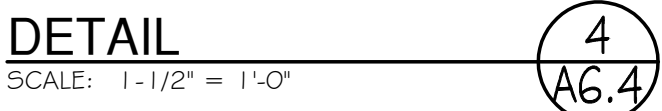




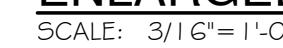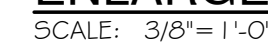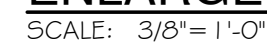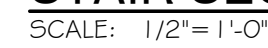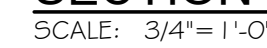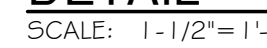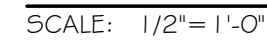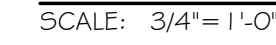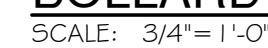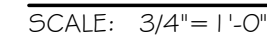


NOTE:  
GENERAL CONTRACTOR TO  
VERIFY IF UNISTRUT IS REQUIRED  
ON EACH SIDE METAL STUDS AS  
REQD FOR CONDUIT SUPPORTS.

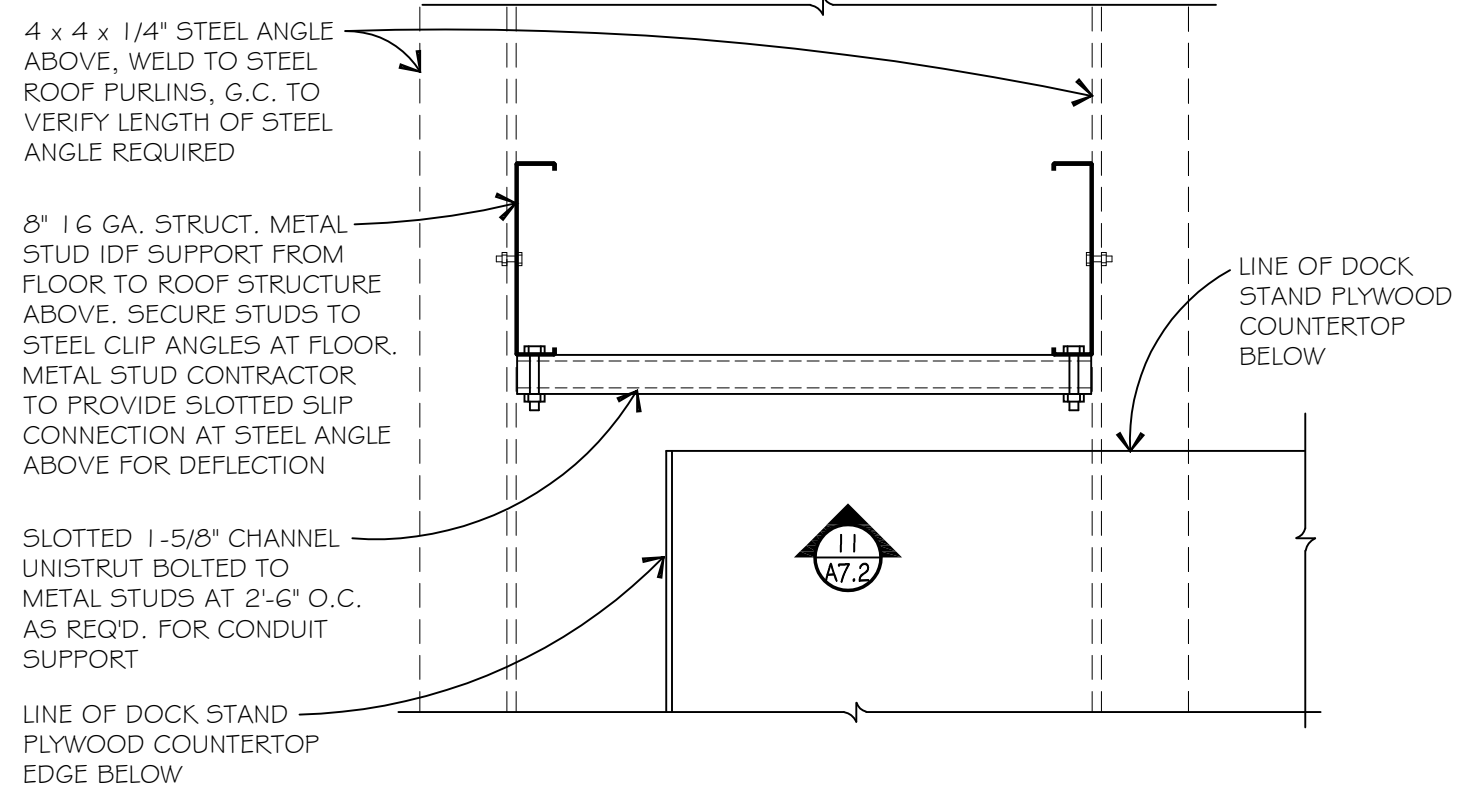


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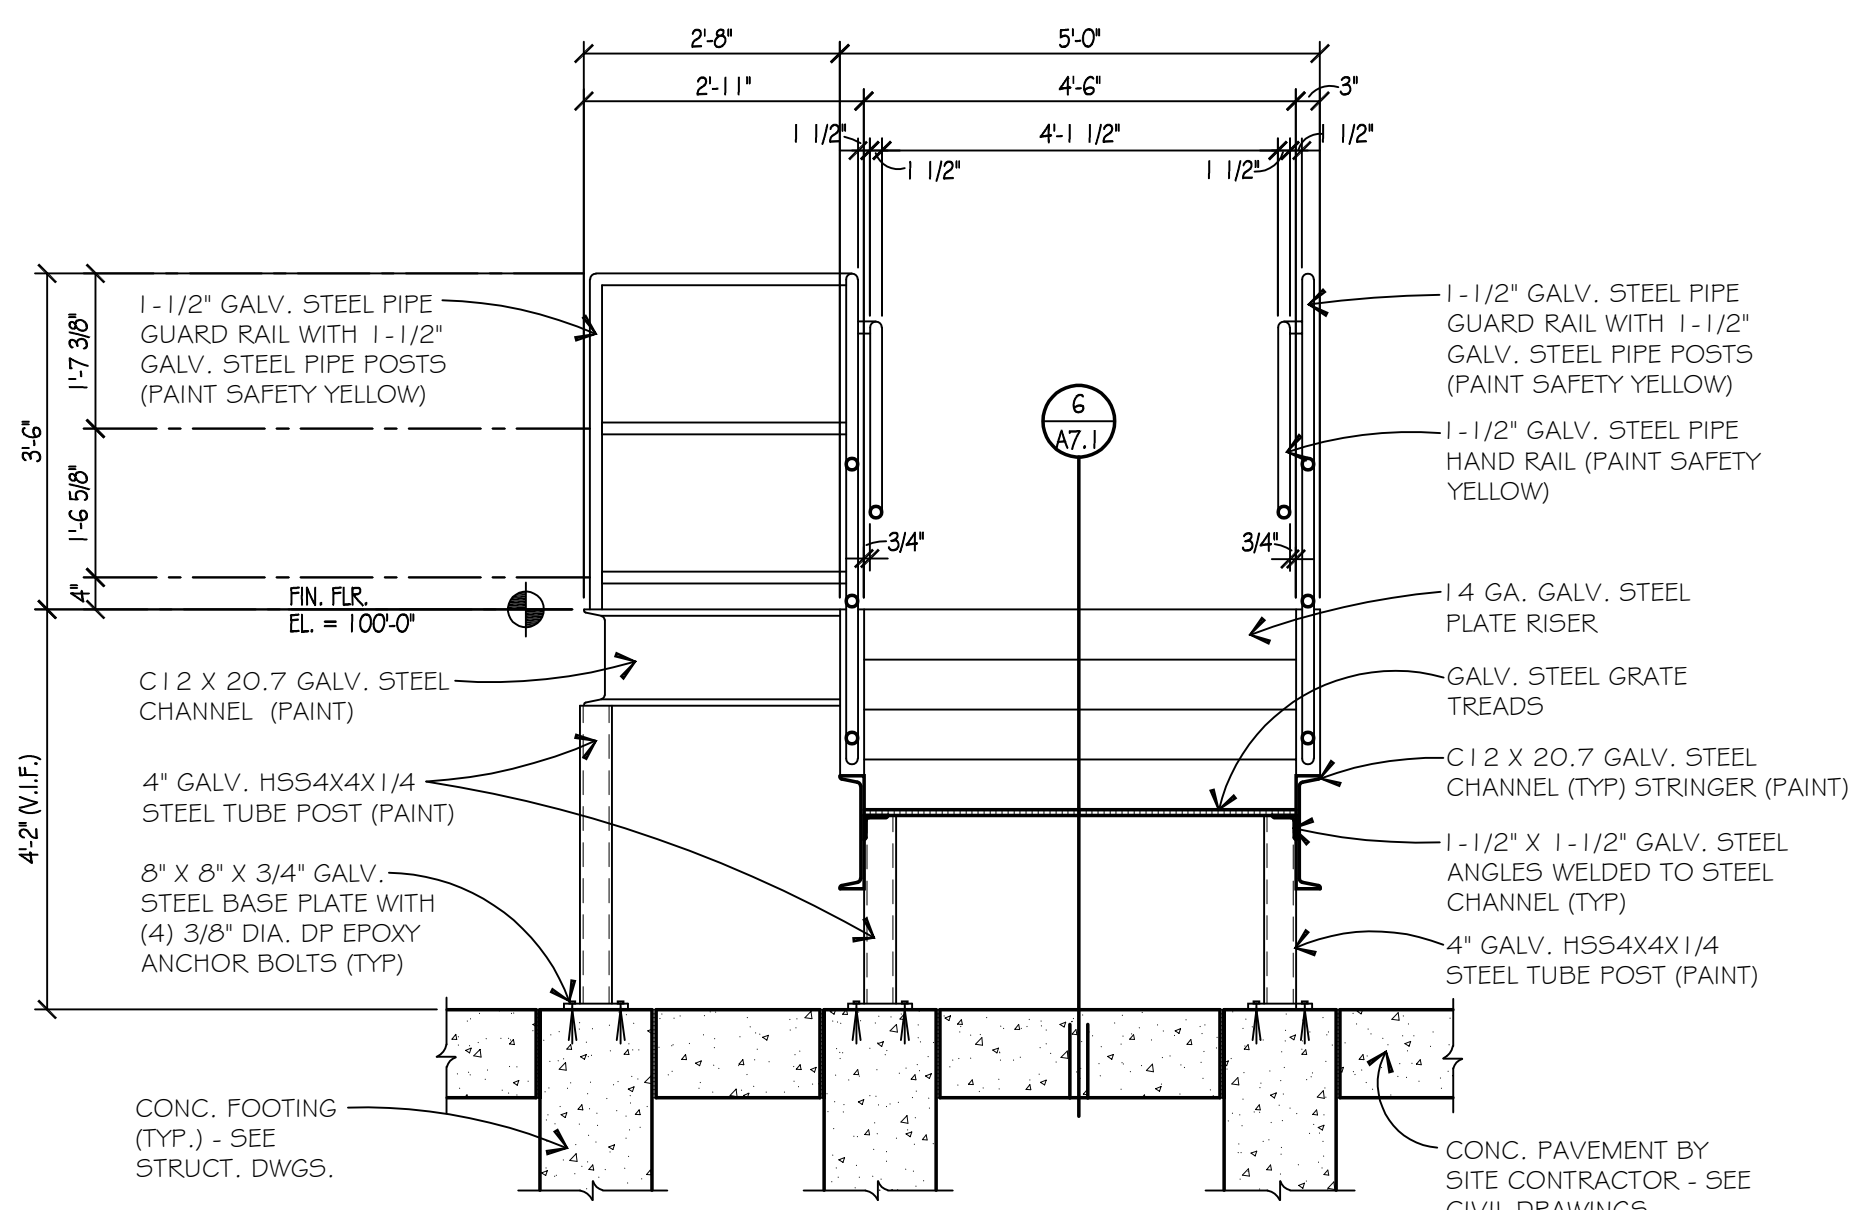
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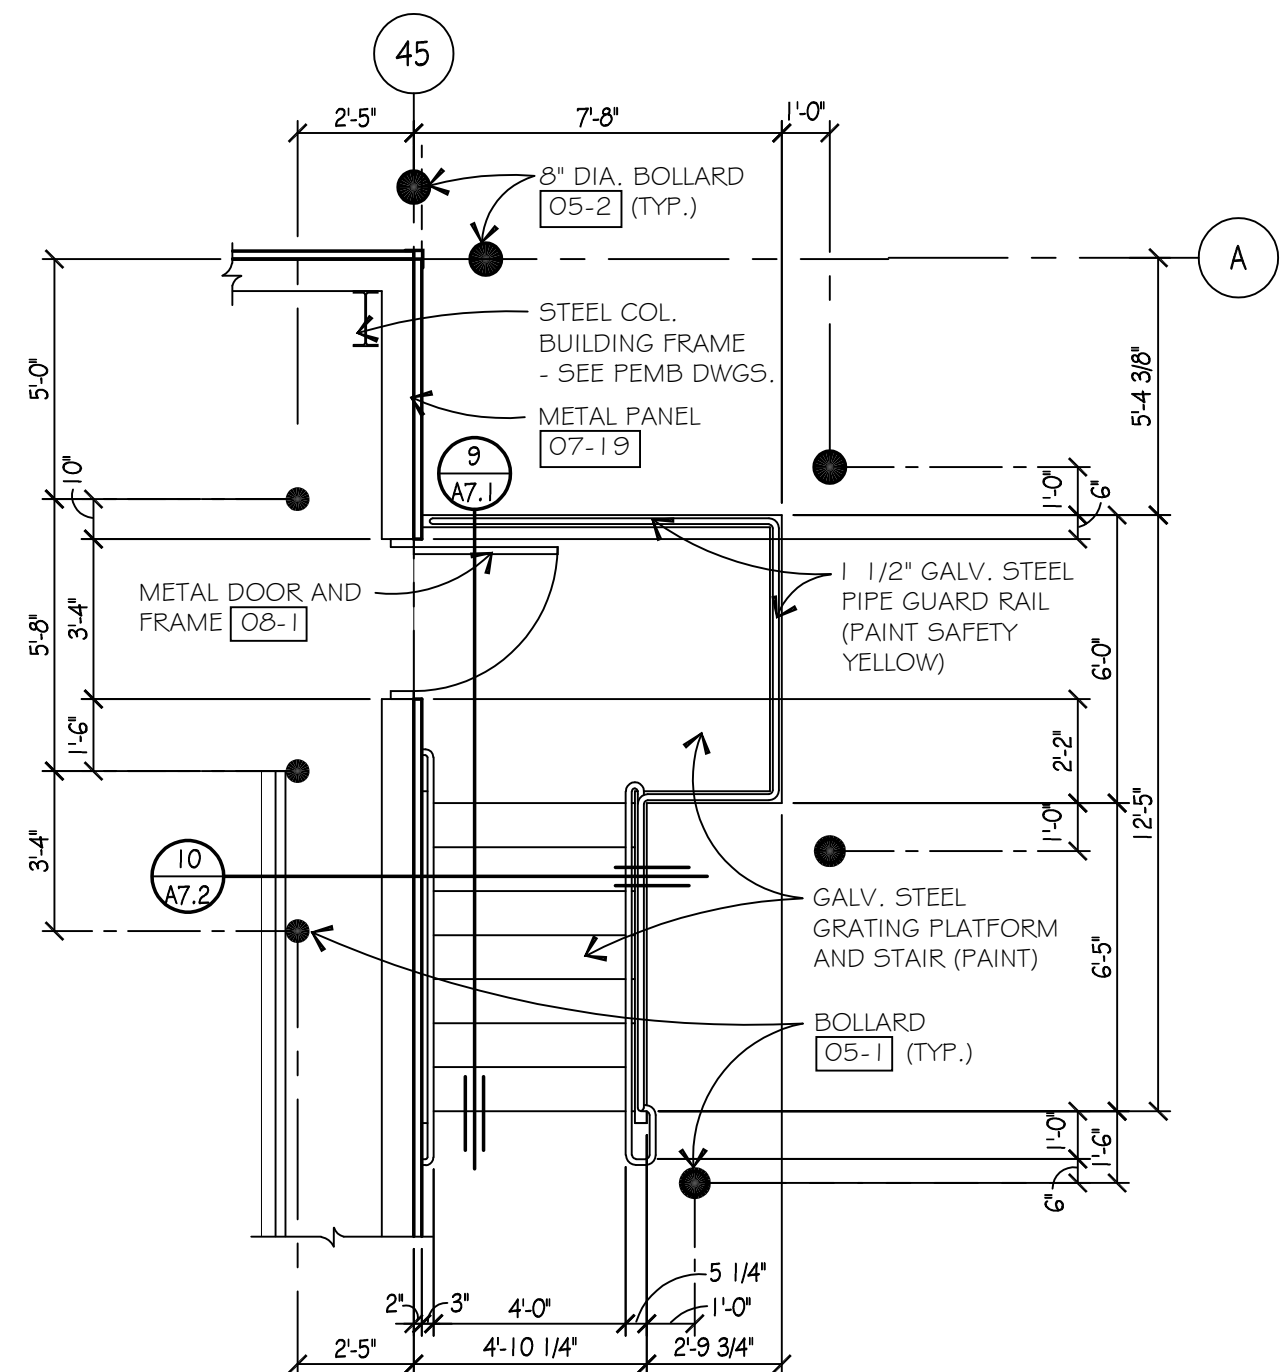
DOCK STAND ELEVATION  
SCALE: 1/2"=1'-0"

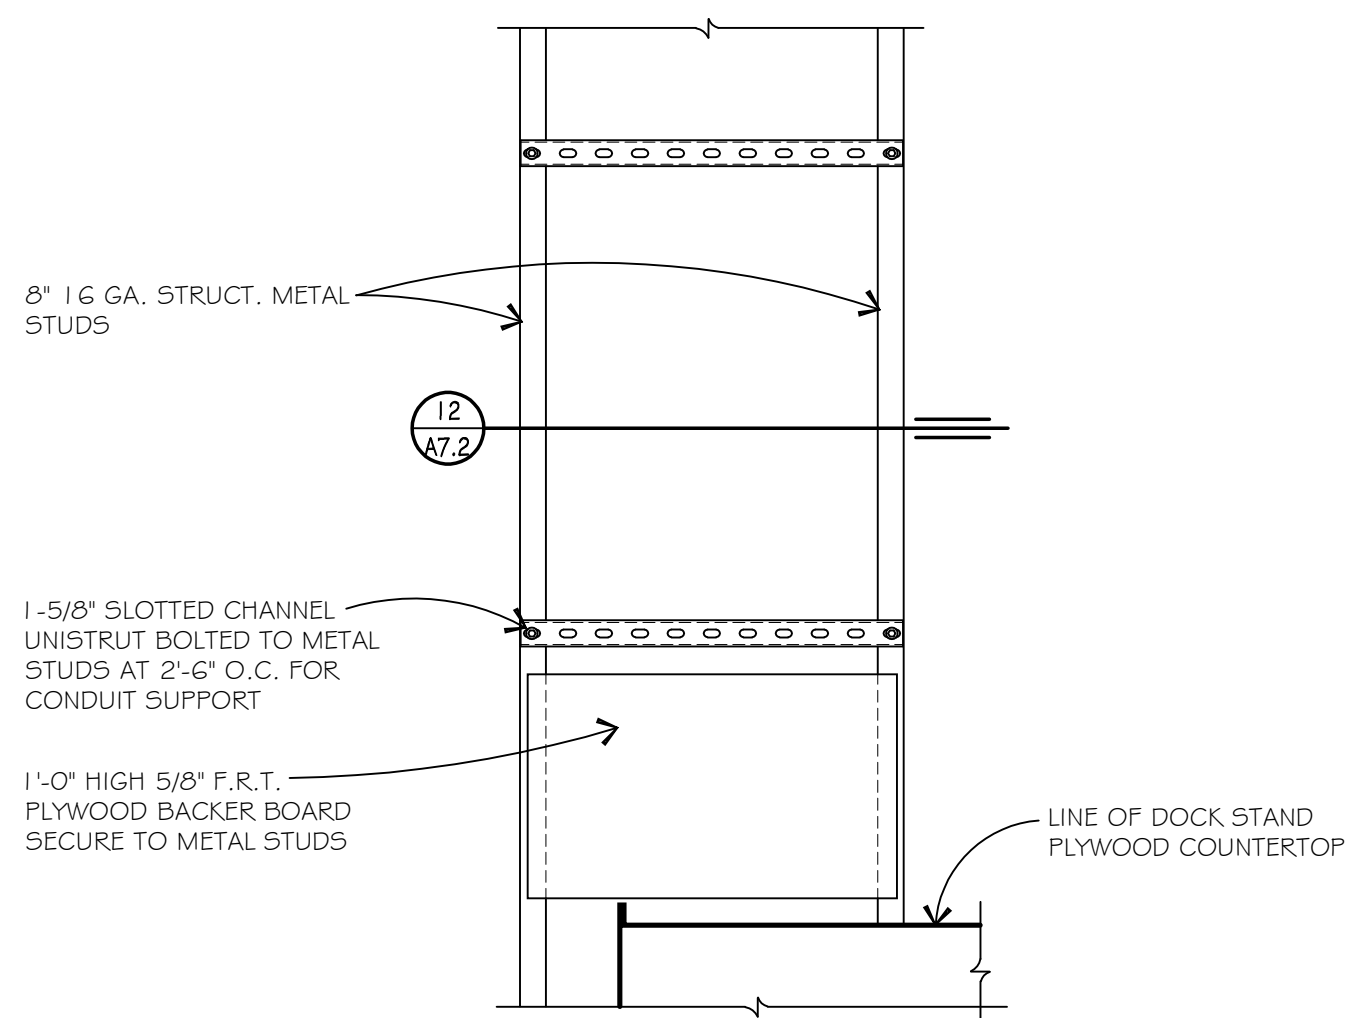


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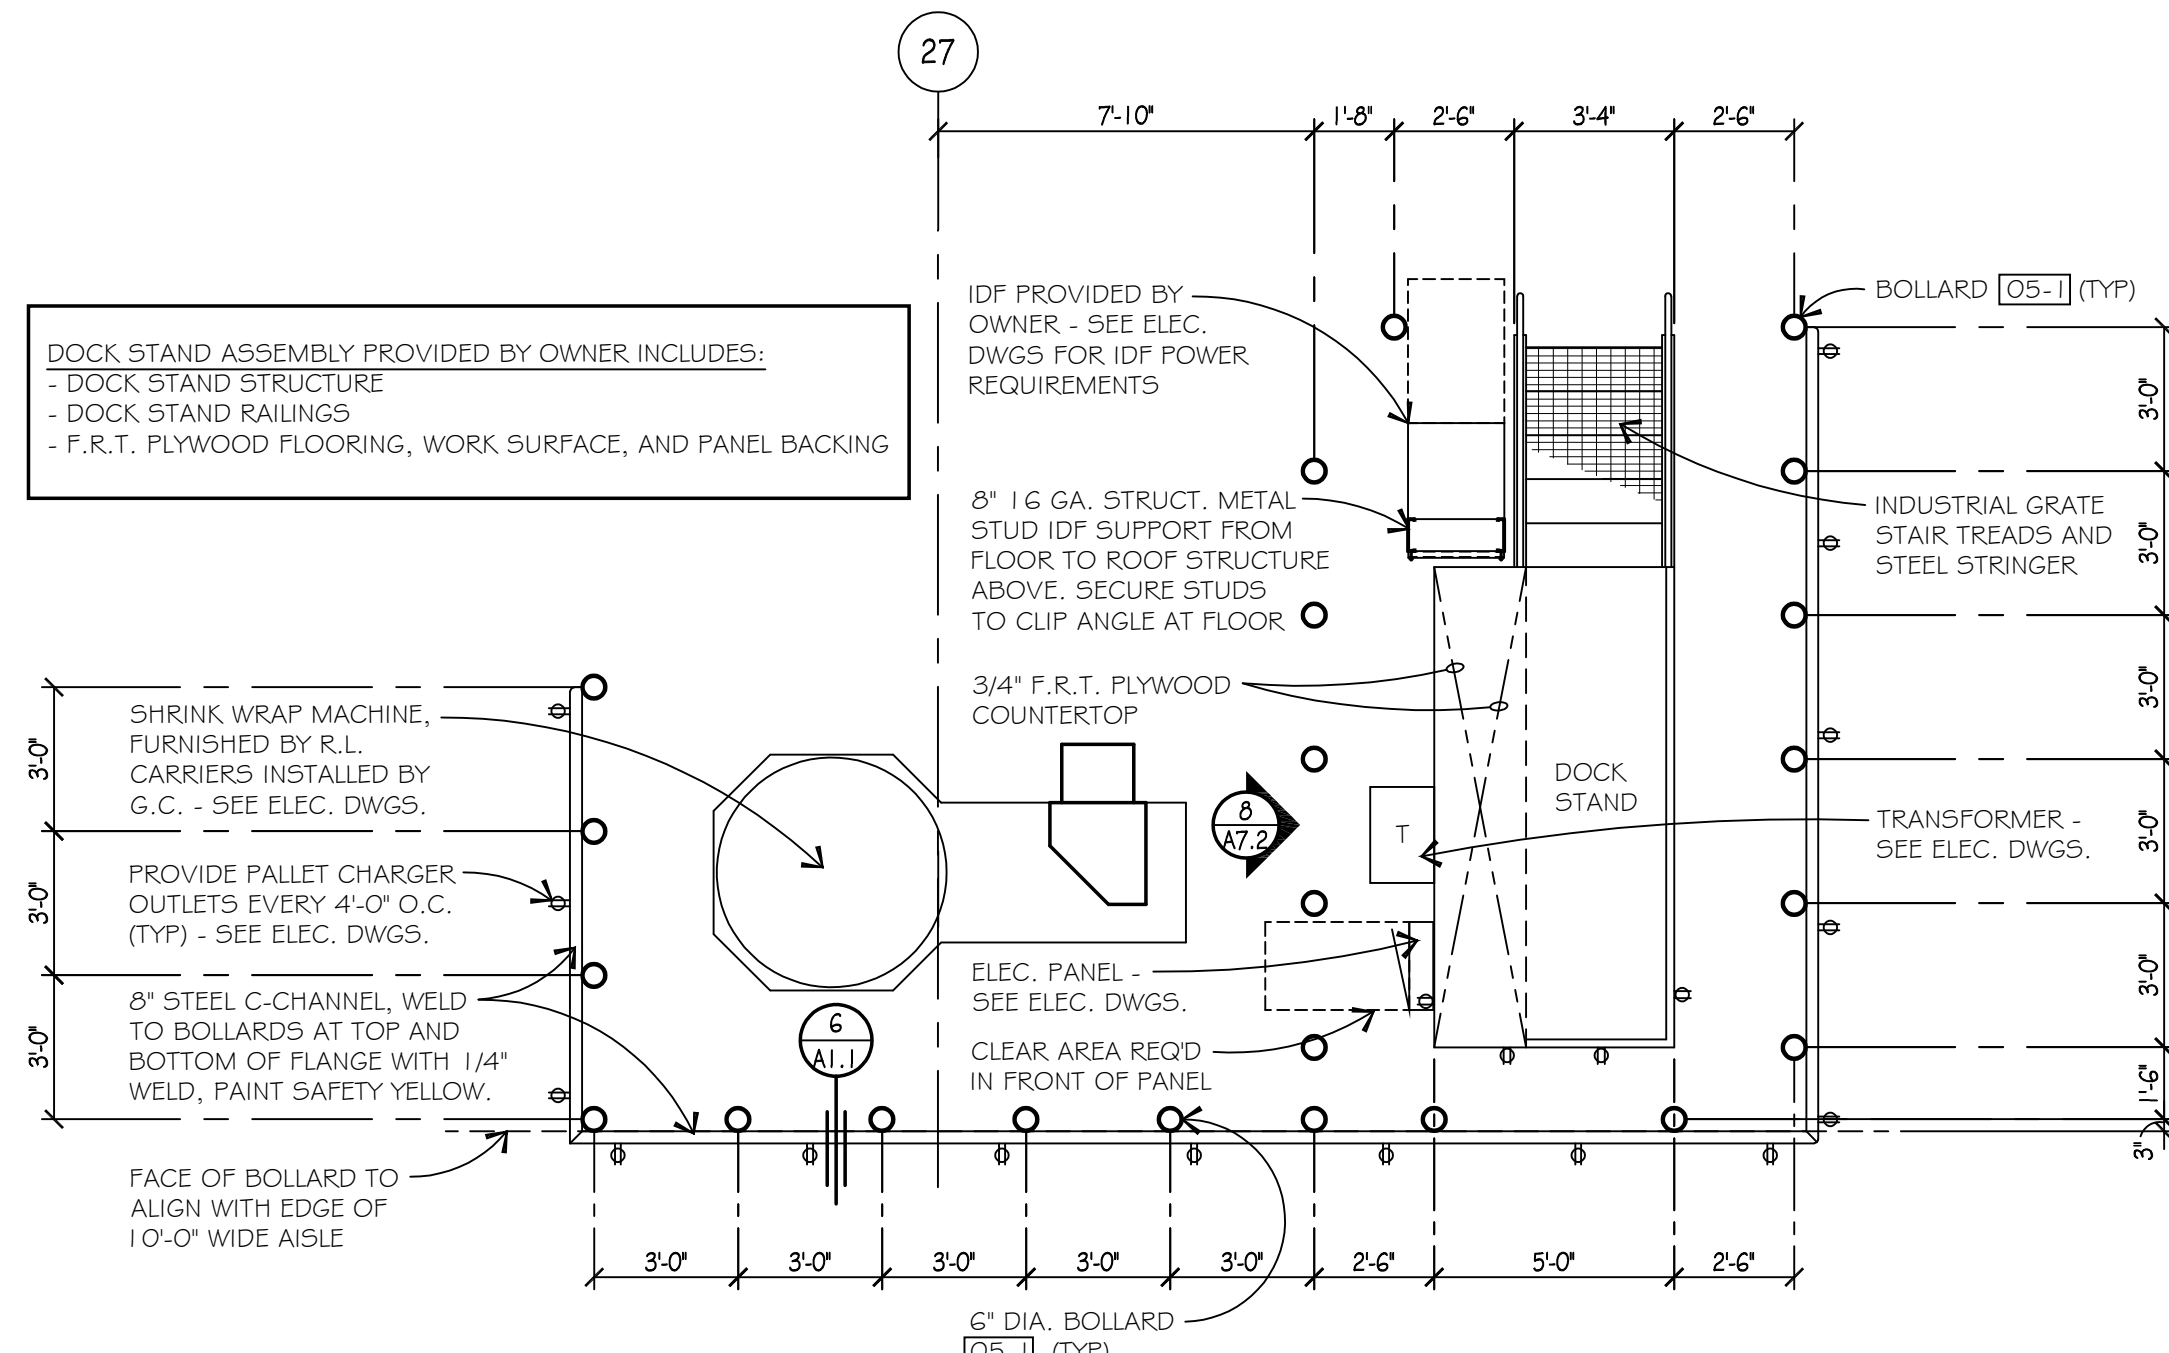
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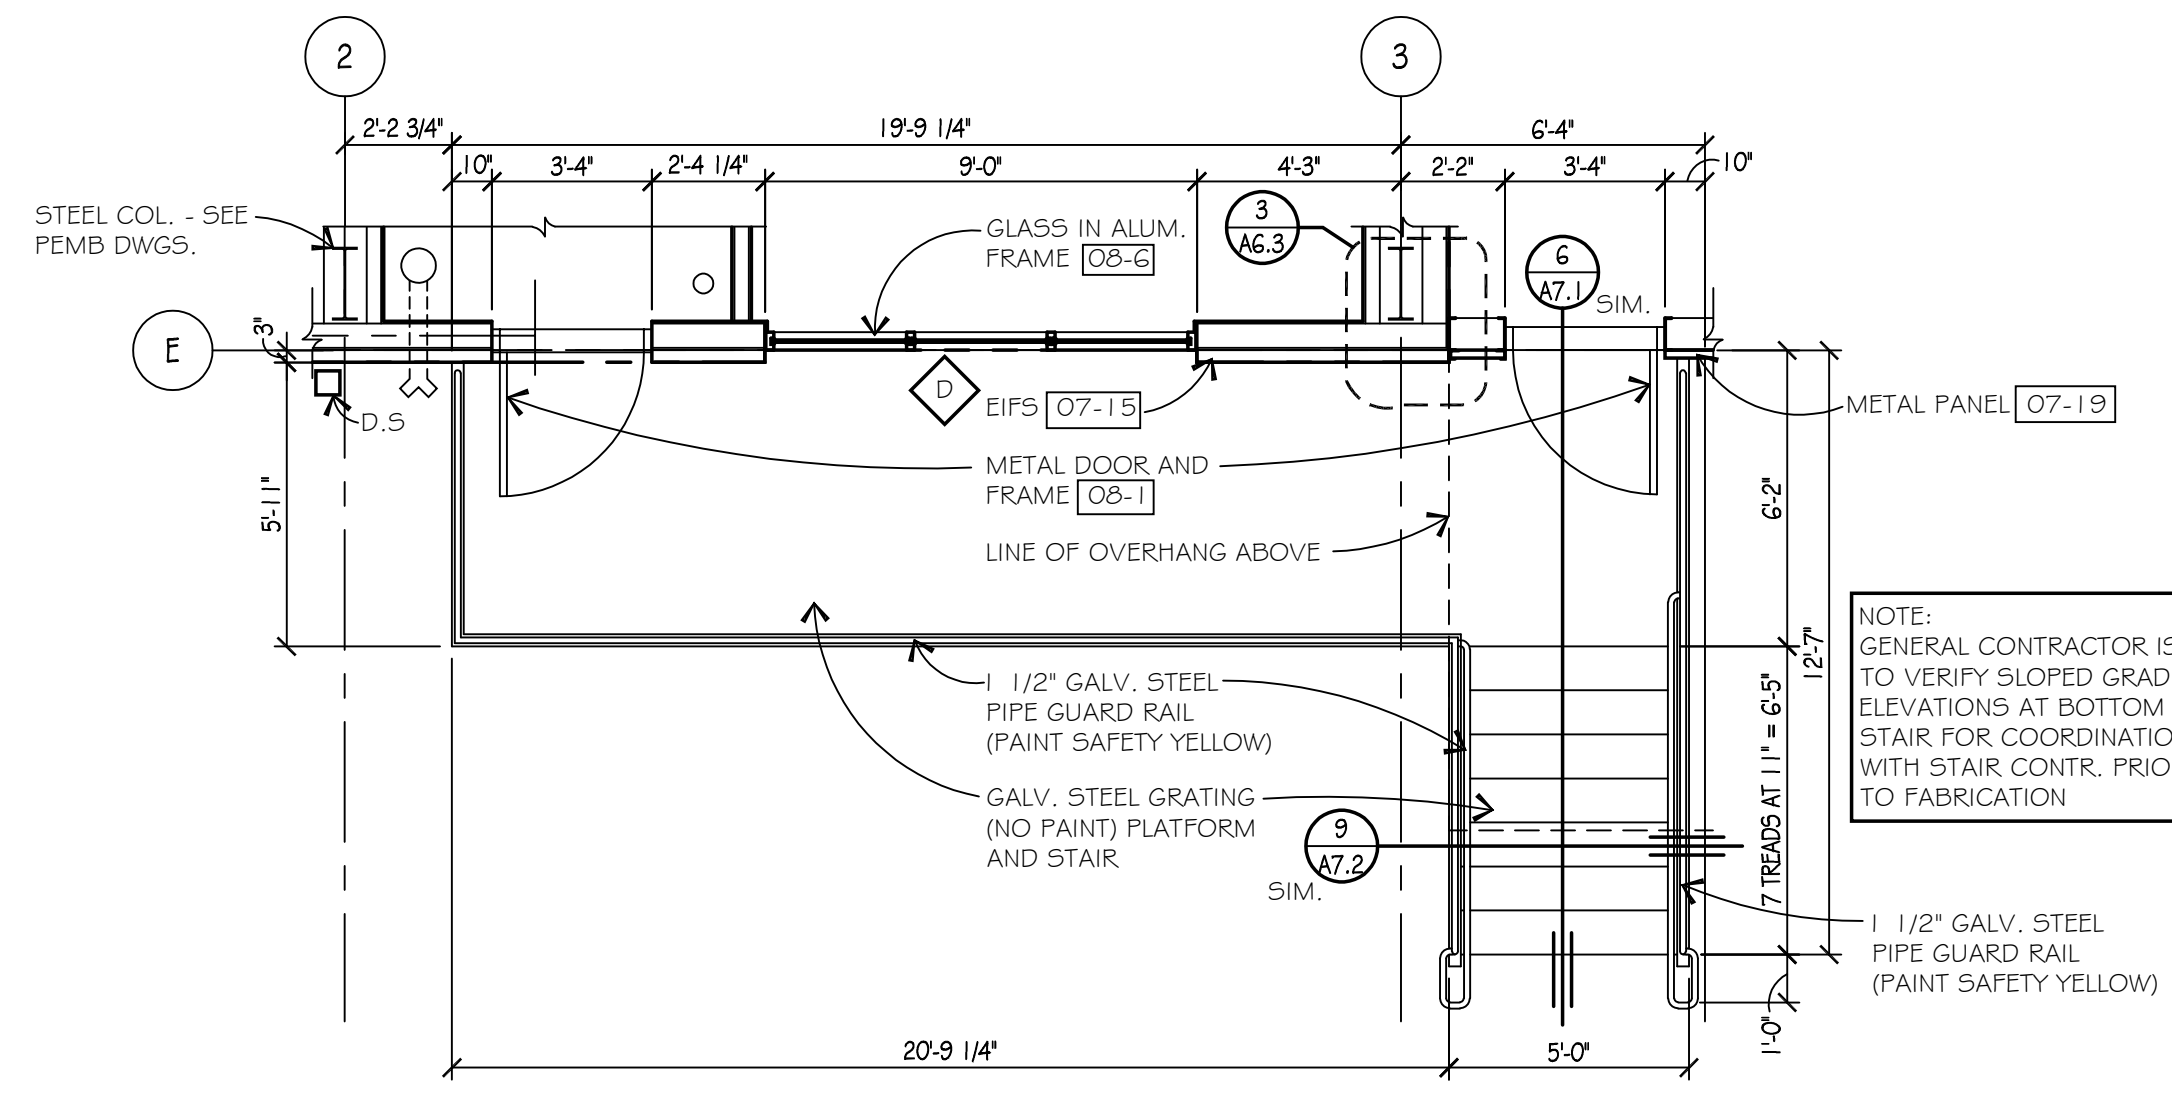
ENLARGED PLAN  
SCALE: 1/4"=1'-0"

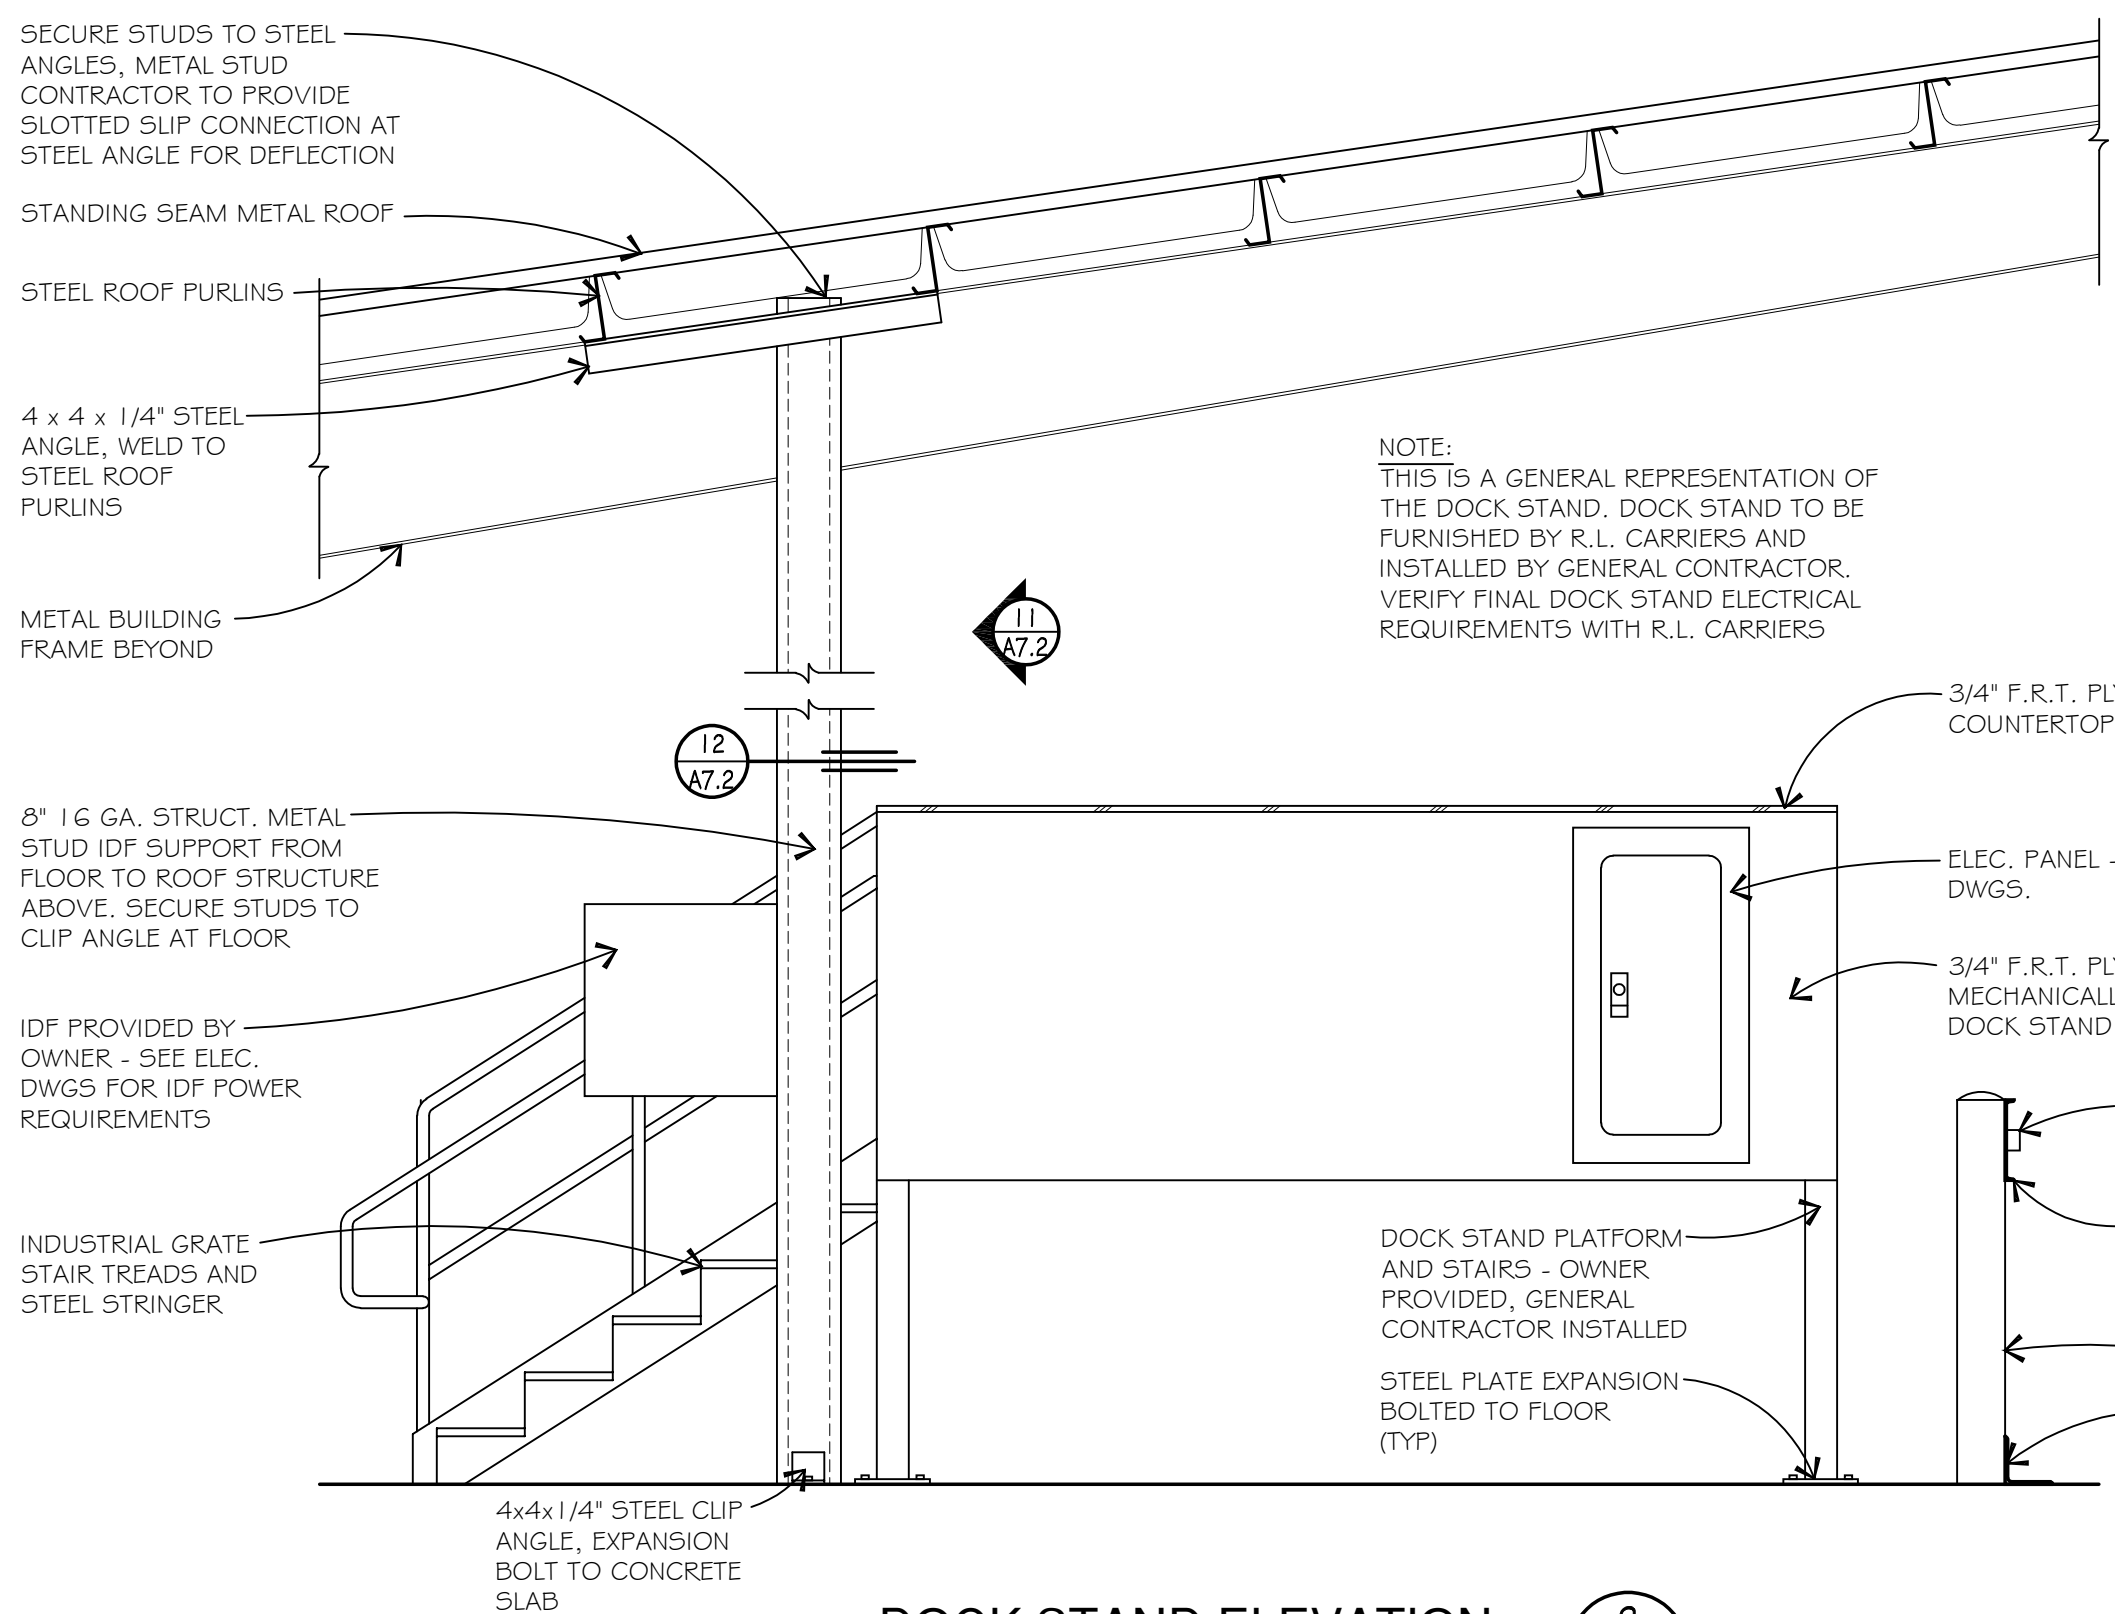


DOCK STAND PLAN  
SCALE: 1/4"=1'-0"

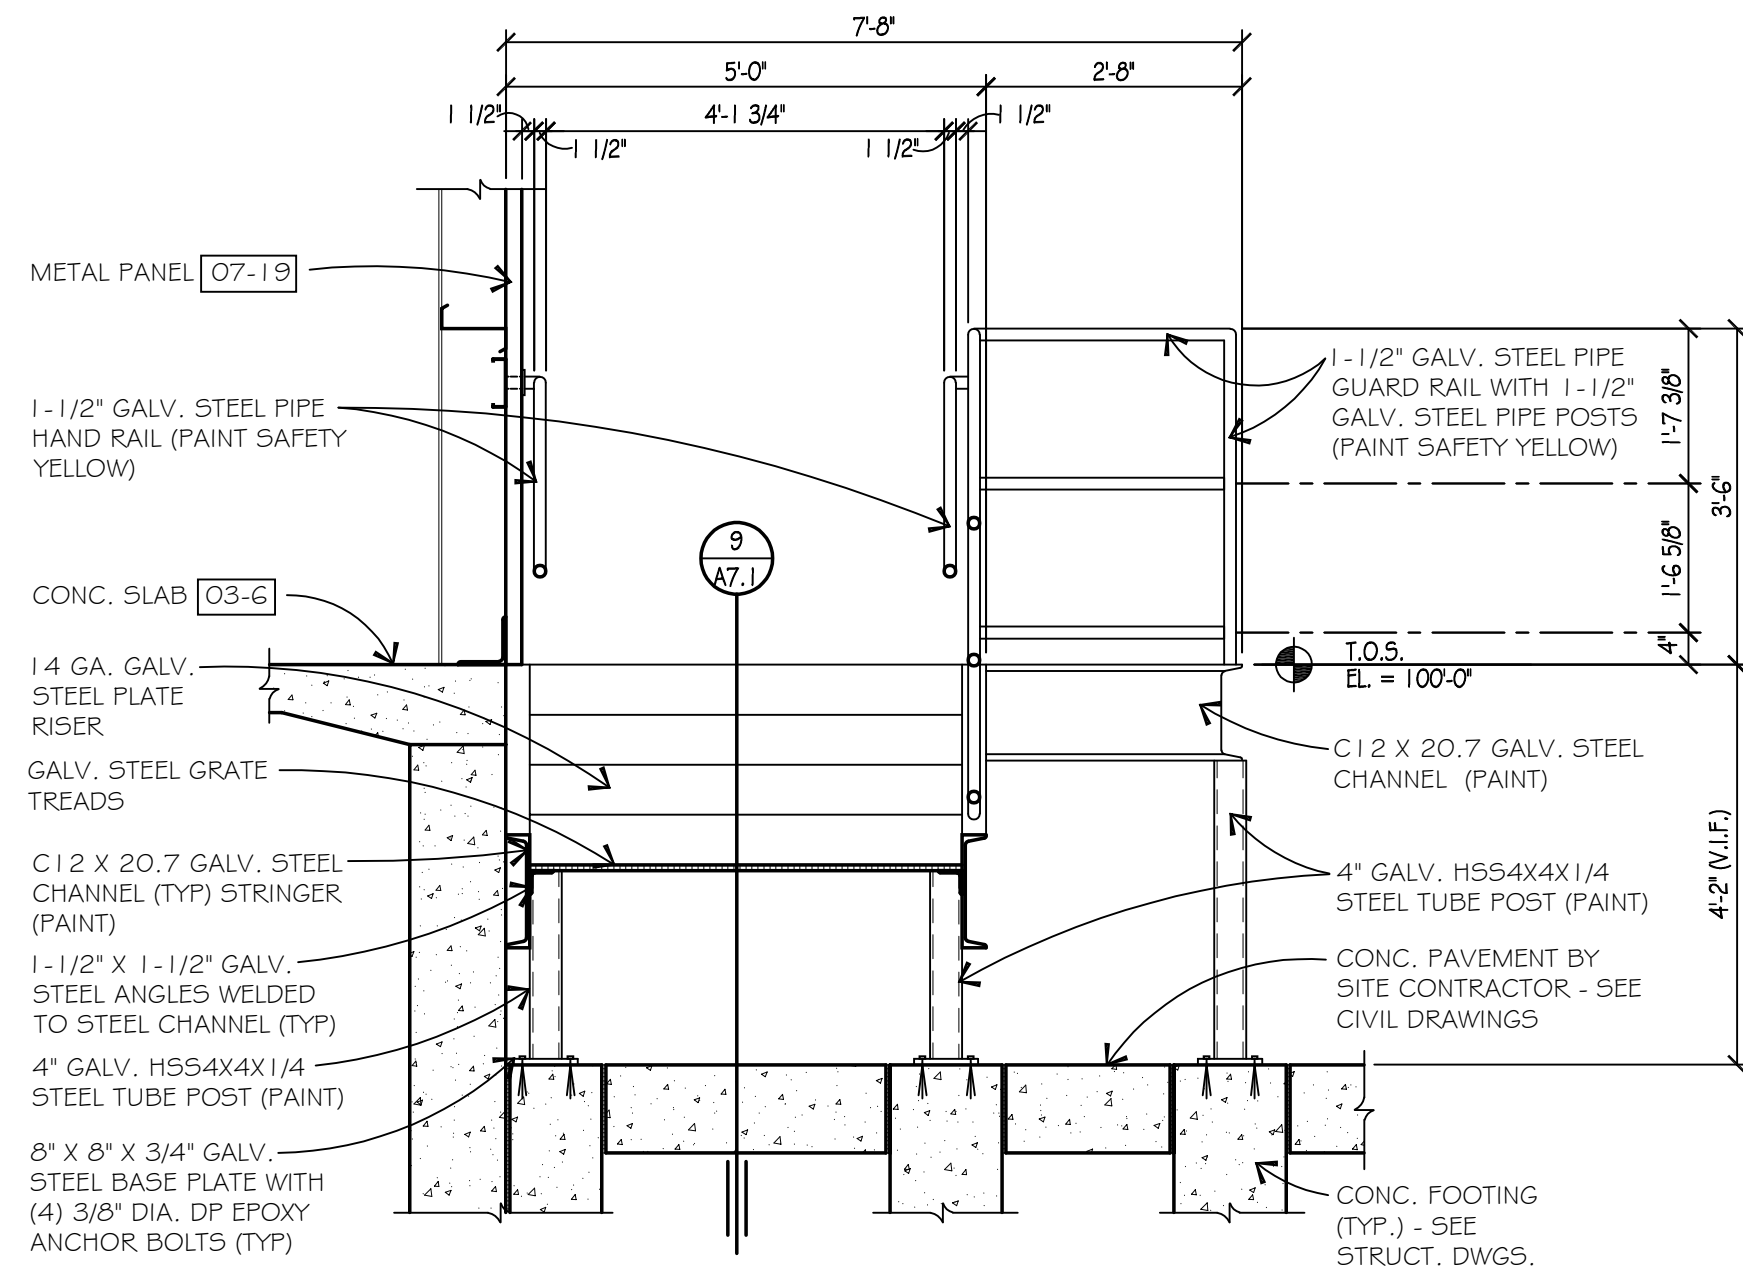

DOCK STAND PLAN  
SCALE: 1/4"=1'-0"

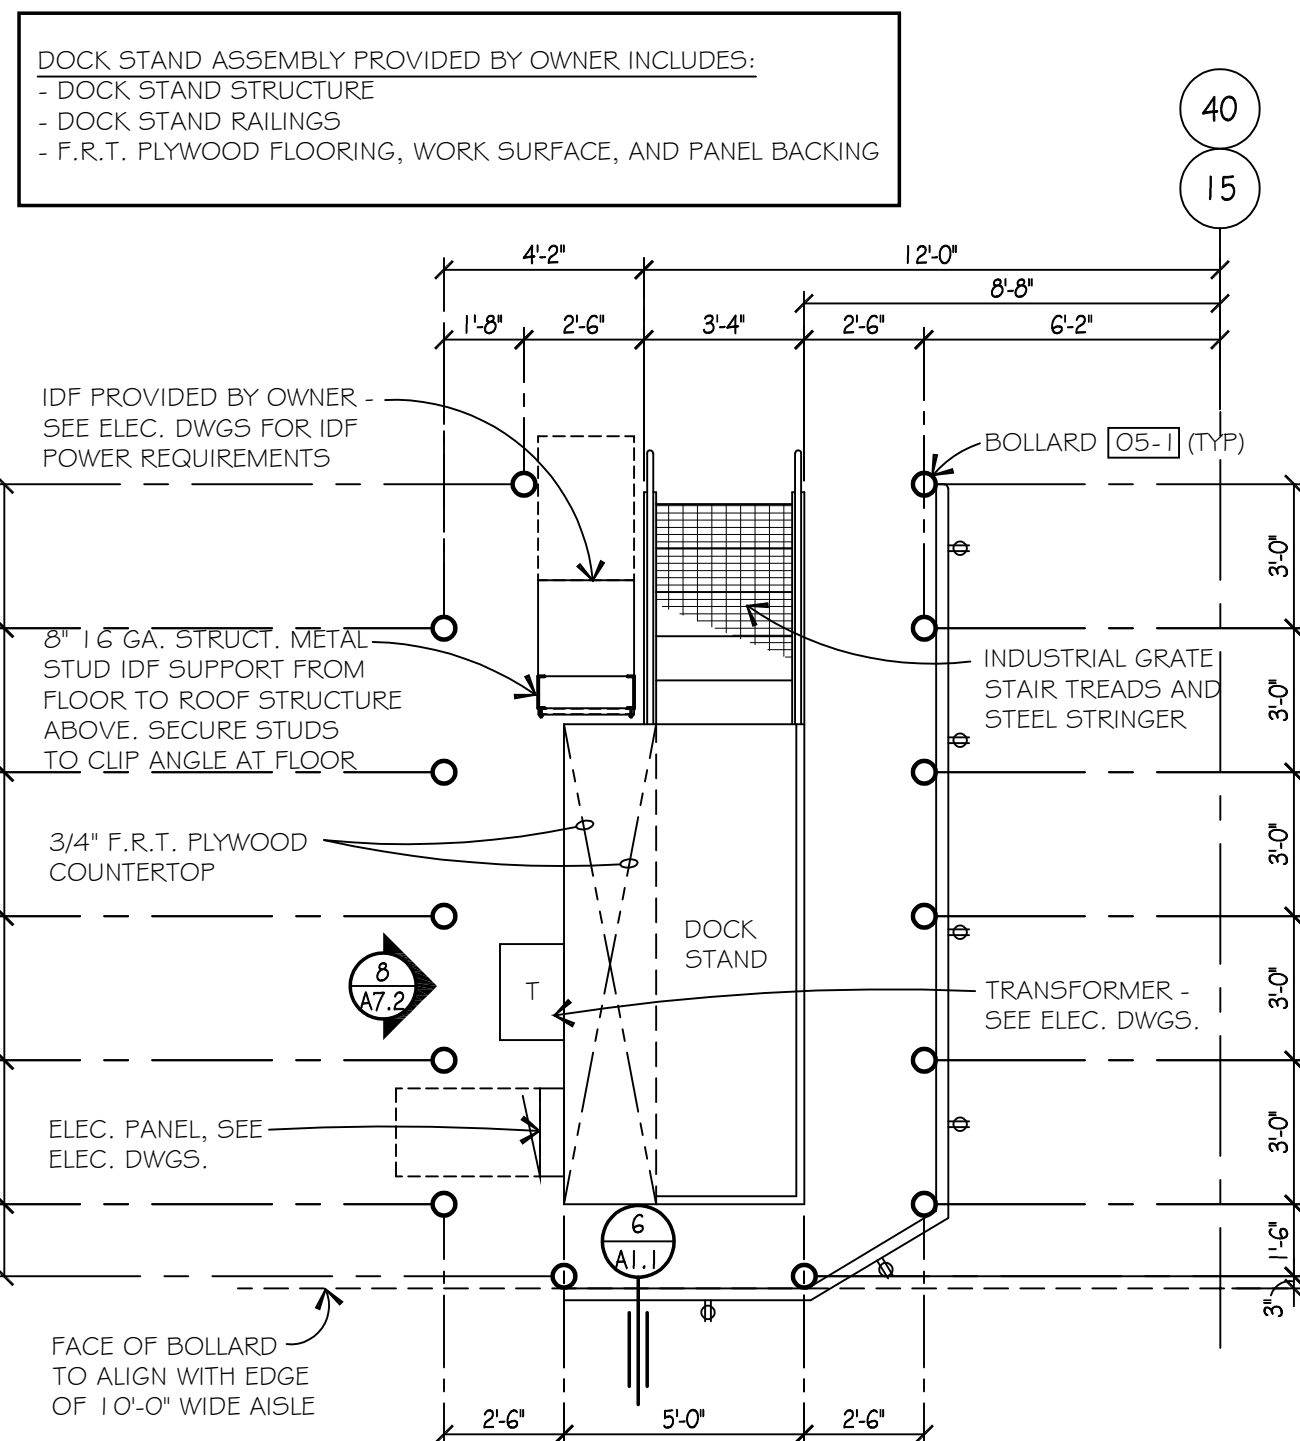

ENLARGED PLAN  
SCALE: 1/4"=1'-0"


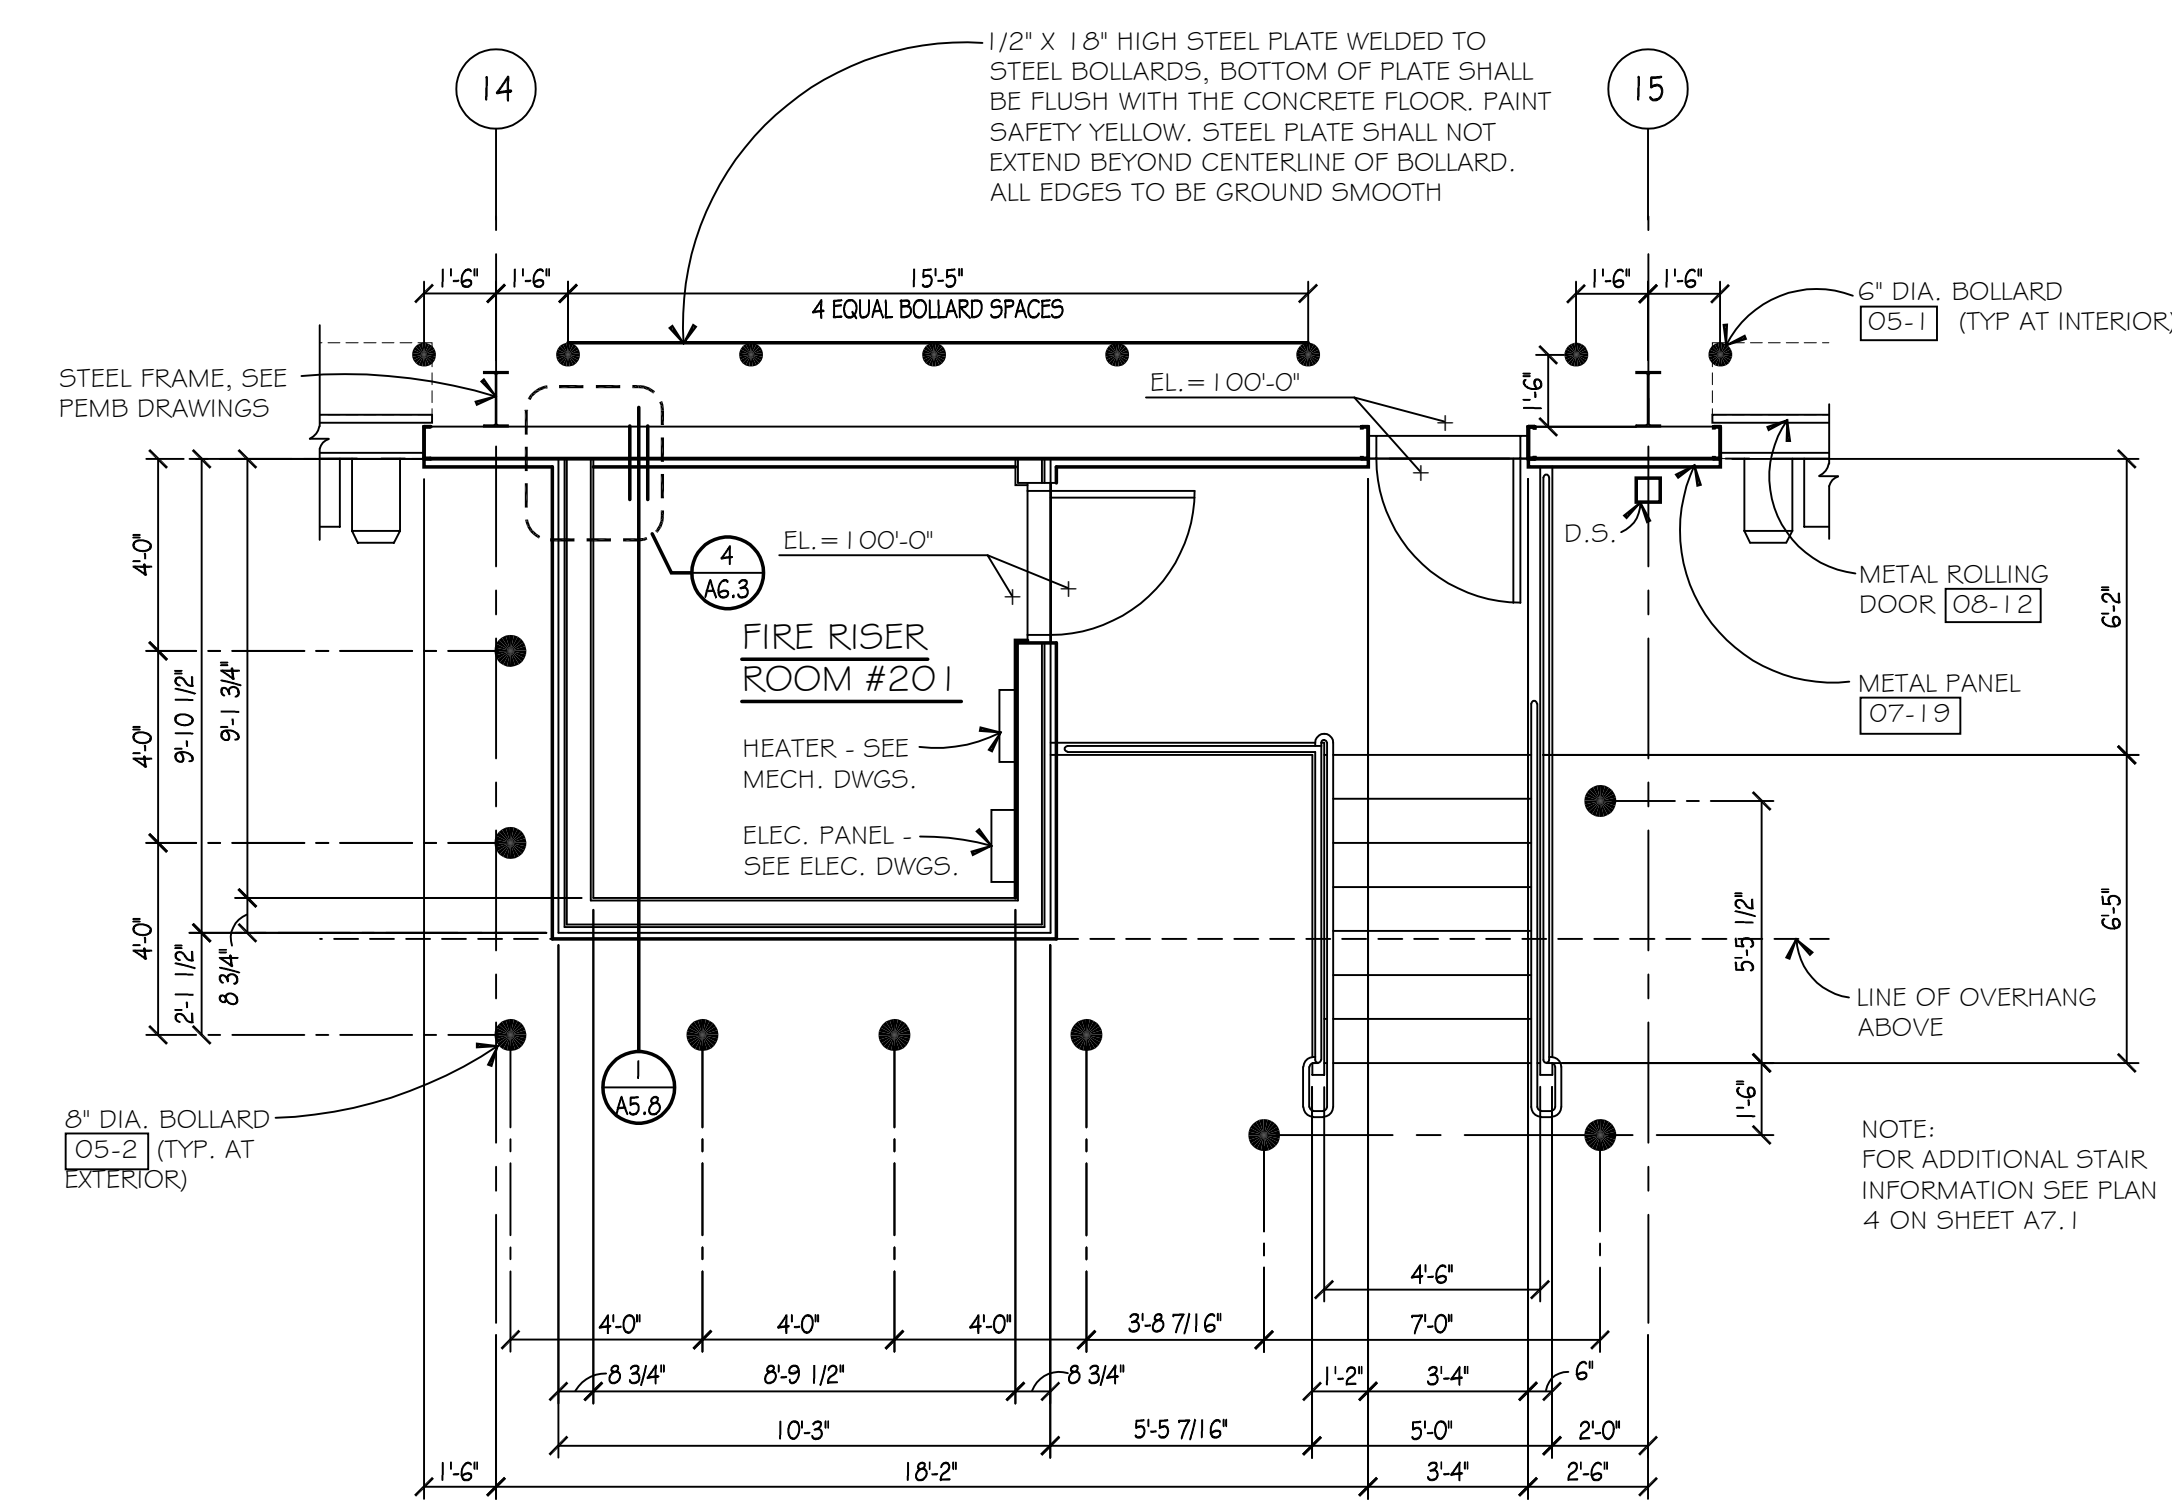


ENLARGED PLAN  
SCALE: 1/4"=1'-0"



## DOOR AND FRAME SCHEDULE


LOCATION	MARK SPECIFIC LOCATION	DOOR										LOUVER		FRAME				FIRE RATING LABEL	HARDWARE SET NO.	DOOR SCHEDULE NOTES
		QTY	SIZE			MATL	TYPE	GLAZING	FINISH	WTH	HGT	MATL	DETAIL			FINISH				
			WTH	HGT	THK								HEAD	JAMB	SILL					
OFFICE #100	100 VESTIBULE 100	1	PR. 3'-0"x7'-0"	1'-3/4"	ALUM 4 GLASS	C	—	DARK BRONZE	—	—	ALUM.	—	—	S-1	DARK BRONZE	1	PAD READER			
	100A VESTIBULE 100	1	3'-0"	6'-10"	1'-3/4"	H.M.	E	—	PREFIN.	—	—	H.M.	H-2	J-2	S-2	PAINTED	2	CARD READER, SEE DOOR SCHEDULE NOTE 3		
	101 OFFICE 101	1	3'-0"	6'-10"	1'-3/4"	H.M.	E	—	PREFIN.	—	—	H.M.	H-2	J-2	S-2	PAINTED	2			
	102 OFFICE 102	1	3'-0"	6'-10"	1'-3/4"	H.M.	E	—	PREFIN.	—	—	H.M.	H-2	J-2	S-2	PAINTED	2			
	103 OFFICE 103	1	3'-0"	6'-10"	1'-3/4"	H.M.	E	—	PREFIN.	—	—	H.M.	H-2	J-2	S-2	PAINTED	2			
	104 RISER ROOM 104	1	3'-0"	7'-0"	1'-3/4"	H.M.	B	—	PREFIN.	—	—	H.M.	H-3	J-3	S-3	PAINTED	3			
	105 MANAGER'S OFFICE 105	1	3'-0"	6'-10"	1'-3/4"	H.M.	E	—	PREFIN.	—	—	H.M.	H-2	J-2	S-2	PAINTED	2			
	105A MANAGER'S OFFICE 105	1	3'-0"	7'-0"	1'-3/4"	H.M.	F	24" X 24"	PREFIN.	—	—	H.M.	H-2	J-2	S-6	PAINTED	4	CARD READER, SEE DOOR SCHEDULE NOTE 3, DOOR TO BE INSULATED		
	106 TELECOM 106	1	3'-0"	7'-0"	1'-3/4"	H.M.	D	—	PREFIN.	—	—	H.M.	H-2	J-2	S-2	PAINTED	2	CARD READER, SEE DOOR SCHEDULE NOTE 3		
	107 COPIER / SUPPLY ROOM 107	1	3'-0"	7'-0"	—	—	—	—	—	—	—	H.M.	H-8	J-8	—	PAINTED	—	CASED OPENING		
	107A COPIER / SUPPLY ROOM 107	1	3'-0"	7'-0"	—	—	—	—	—	—	—	H.M.	H-8	J-8	—	PAINTED	—	CASED OPENING		
	108 DISPATCH 108	1	3'-6"	7'-0"	—	—	—	—	—	—	—	H.M.	H-8	J-8	—	PAINTED	—	CASED OPENING		
	108A DISPATCH 108	1	3'-0"	7'-0"	1'-3/4"	H.M.	F	24" X 24"	PREFIN.	—	—	H.M.	H-2	J-2	S-6	PAINTED	4	CARD READER, SEE DOOR SCHEDULE NOTE 3, DOOR TO BE INSULATED		
	109 DRIVER ROOM 109	1	3'-0"	7'-0"	1'-3/4"	H.M.	F	24" X 24"	PREFIN.	—	—	H.M.	H-2	J-2	S-6	PAINTED	4	DOOR TO BE INSULATED		
	110 SUPPLY CLOSET 110	1	3'-0"	6'-10"	1'-3/4"	H.M.	E	—	PREFIN.	—	—	H.M.	H-2	J-2	S-2	PAINTED	5			
	111 JANITOR 111	1	3'-0"	7'-0"	1'-3/4"	H.M.	B	—	PREFIN.	—	—	H.M.	H-2	J-2	S-2	PAINTED	5	DOOR TO BE INSULATED		
	112 WOMEN 112	1	3'-0"	7'-0"	1'-3/4"	H.M.	B	—	PREFIN.	—	—	H.M.	H-6	J-6	S-6	PAINTED	6	DOOR TO BE INSULATED		
	113 SHOWER 113	1	3'-0"	7'-0"	1'-3/4"	H.M.	B	—	PREFIN.	—	—	H.M.	H-2	J-2	S-6	PAINTED	6	DOOR TO BE INSULATED		
	114 MEN 114	1	3'-0"	7'-0"	1'-3/4"	H.M.	B	—	PREFIN.	—	—	H.M.	H-2	J-2	S-6	PAINTED	7	DOOR TO BE INSULATED		
115 WOMEN 115	1	3'-0"	7'-0"	1'-3/4"	H.M.	D	—	PREFIN.	—	—	H.M.	H-2	J-2	S-2	PAINTED	7	1" UNDERCUT			
116 MEN 116	1	3'-0"	7'-0"	1'-3/4"	H.M.	D	—	PREFIN.	—	—	H.M.	H-2	J-2	S-2	PAINTED	7	1" UNDERCUT			
117 ELECTRICAL 117	1	3'-0"	7'-0"	1'-3/4"	H.M.	D	—	PREFIN.	—	—	H.M.	H-2	J-2	S-2	PAINTED	8	CARD READER, SEE DOOR SCHEDULE NOTE 3			
118 BREAKROOM 118	1	4'-0"	7'-0"	—	—	—	—	—	—	—	H.M.	H-8	J-8	—	PAINTED	—	CASED OPENING			
119 OPEN OFFICE 119	1	3'-0"	7'-0"	1'-3/4"	H.M.	B	—	PREFIN.	—	—	H.M.	H-3	J-3	S-5	PAINTED	10				
TERMINAL #200	200A TERMINAL 200	155	9'-0"	9'-0"	2"	STEEL	A	—	PREFIN.	—	—	STEEL	H-1	J-1	—	PAINTED	9	SEE MANUFACTURERS SPECIFICATIONS		
	200B TERMINAL 200	11	3'-0"	7'-0"	1'-3/4"	H.M.	B	—	PREFIN.	—	—	H.M.	H-4	J-4	S-3	PAINTED	10			
	201A RISER ROOM 201	1	3'-0"	7'-0"	1'-3/4"	H.M.	D	—	PAINT	—	—	H.M.	H-5	J-5	S-3	PAINTED	10			
	202A RISER ROOM 202	1	3'-0"	7'-0"	1'-3/4"	H.M.	D	—	PAINT	—	—	H.M.	H-5	J-5	S-3	PAINTED	10			
	300A PARTS ROOM 300	2	9'-0"	8'-8"	2"	STEEL	A	—	PREFIN.	—	—	STEEL	H-6	J-6	—	PAINTED	11	SEE MANUFACTURERS SPECIFICATIONS		
300B PARTS ROOM 300	2	3'-0"	7'-0"	1'-3/4"	H.M.	E	8" X 24" VISION LITES	PAINTED	—	—	H.M.	H-7	J-7	—	PAINTED	12				
300C PARTS ROOM 300	1	9'-0"	10'-0"	2"	STEEL	G	—	PREFIN.	—	—	STEEL	H-1	J-1	S-7	PAINTED	11	SEE MANUFACTURERS SPECIFICATIONS			
300D PARTS ROOM 300	1	3'-0"	7'-0"	1'-3/4"	H.M.	B	—	PAINTED	—	—	H.M.	H-11	J-11	S-4	PAINTED	10				
300E PARTS ROOM 300	1	3'-0"	7'-0"	1'-3/4"	H.M.	E	8" X 24" VISION LITES	PAINTED	—	—	H.M.	H-7	J-7	—	PAINTED	4				
301A NORTH BAY 301	8	14'-0"	16'-0"	2"	STEEL	G	—	PREFIN.	—	—	STEEL	H-1	J-1	S-7	PAINTED	11	SEE MANUFACTURERS SPECIFICATIONS			
301B NORTH BAY 301	1	3'-0"	7'-0"	1'-3/4"	H.M.	D	—	PAINTED	—	—	H.M.	H-7	J-7	—	PAINTED	14				
301C NORTH BAY 301	1	3'-0"	7'-0"	1'-3/4"	H.M.	B	—	PAINTED	—	—	H.M.	H-11	J-11	S-4	PAINTED	10				
302A SAFETY LANE 302	2	14'-0"	16'-0"	2"	STEEL	G	—	PREFIN.	—	—	STEEL	H-1	J-1	S-7	PAINTED	11	SEE MANUFACTURERS SPECIFICATIONS			
302B SAFETY LANE 302	1	3'-0"	7'-0"	1'-3/4"	H.M.	B	—	PAINTED	—	—	H.M.	H-11	J-11	S-4	PAINTED	10				
302C SAFETY LANE 302	2	3'-0"	7'-0"	1'-3/4"	H.M.	F	24" X 24"	PAINTED	—	—	H.M.	H-9	J-9	—	PAINTED	16	DOOR TO BE INSULATED			
302D SAFETY LANE 302	1	3'-0"	6'-8"	1'-3/4"	H.M.	B	—	PAINTED	—	—	H.M.	H-11	J-7	S-4	PAINTED	10	2" HIGH HOLLOW METAL DOOR HEAD			
303A SOUTH BAY 303	6	14'-0"	16'-0"	2"	STEEL	G	—	PREFIN.	—	—	STEEL	H-1	J-1	S-7	PAINTED	11	SEE MANUFACTURERS SPECIFICATIONS			
303B SOUTH BAY 303	2	3'-0"	7'-0"	1'-3/4"	H.M.	B	—	PAINTED	—	—	H.M.	H-11	J-7	S-4	PAINTED	10				
303C SOUTH BAY 303	1	3'-0"	7'-0"	1'-3/4"	H.M.	D	—	PAINTED	—	—	H.M.	H-7	J-7	—	PAINTED	14				
303D SAFETY LANE 302	1	3'-0"	6'-8"	1'-3/4"	H.M.	B	—	PAINTED	—	—	H.M.	H-11	J-7	S-4	PAINTED	10	2" HIGH HOLLOW METAL DOOR HEAD			
304A OFFICE 304	1	3'-0"	7'-0"	1'-3/4"	H.M.	F	8" X 24"	PAINTED	—	—	H.M.	H-7	J-7	—	PAINTED	15				
305A FIRE RISER 305	1	PR. 3'-0"x7'-0"	1'-3/4"	H.M.	H	—	PAINTED	—	—	—	H.M.	H-7	J-7	—	PAINTED	13				
306A BREAKROOM 306	1	3'-0"	7'-4"	—	—	—	—	—	—	—	—	—	—	—	PAINTED	—	CASED OPENING			
307A OFFICE 307	1	3'-0"	7'-0"	1'-3/4"	H.M.	E	8" X 24"	PAINTED	—	—	H.M.	H-7	J-7	—	PAINTED	15				
308A OFFICE 308	1	3'-0"	7'-0"	1'-3/4"	H.M.	E	8" X 24"	PAINTED	—	—	H.M.	H-7	J-7	—	PAINTED	15				
309A COMPRESSOR 309	1	PR. 3'-0"x7'-0"	1'-3/4"	H.M.	I	—	PAINTED	18" 18"	—	—	H.M.	H-7	J-7	—	PAINTED	13	PROVIDE LOUVER ON EACH DOOR			
310A ELECTRICAL RM. 310	1	3'-0"	7'-0"	1'-3/4"	H.M.	D	—	PAINTED	—	—	H.M.	H-7	J-7	—	PAINTED	15	PAD READER			
311A JANITOR 311	1	3'-0"	7'-0"	1'-3/4"	H.M.	D	—	PAINTED	—	—	H.M.	H-7	J-7	—	PAINTED	15				
312A WOMEN 312	1	3'-0"	7'-0"	1'-3/4"	H.M.	D	—	PAINTED	—	—	H.M.	H-7	J-7	—	PAINTED	6				
313A SHOWER 313	1	3'-0"	7'-0"	1'-3/4"	H.M.	D	—	PAINTED	—	—	H.M.	H-7	J-7	—	PAINTED	6				
314A MEN 314	1	3'-0"	7'-0"	1'-3/4"	H.M.	D	—	PAINTED	—	—	H.M.	H-7	J-7	—	PAINTED	7				
315A CORRIDOR 315	1	3'-0"	7'-0"	1'-3/4"	H.M.	E	8" X 24"	PAINTED	—	—	H.M.	H-11	J-7	S-4	PAINTED	10				
316A I.T. RM. 316	1	PR. 3'-0"x7'-0"	1'-3/4"	H.M.	D	—	PAINTED	—	—	—	H.M.	H-7	J-7	—	PAINTED	13	PAD READER			
TRUCK WASH #400	401A DETAILING BAY	1	14'-0"	16'-0"	INSUL	STEEL	G	VISION LITES	PREFIN.	—	—	STEEL	H-10	J-10	S-7	PAINTED	11	SEE MANUFACTURERS SPECIFICATIONS		
	401B DETAILING BAY	1	3'-0"	7'-0"	1'-3/4"	H.M.	D	—	PAINTED	—	—	H.M.	H-7	J-7	—	PAINTED	14			
	401C DETAILING BAY	1	3'-0"	7'-0"	1'-3/4"	H.M.	B	—	PAINTED	—	—	H.M.	H-7	J-7	S-4	PAINTED	10			
	402A EQUIPMENT BAY	1	14'-0"	16'-0"	INSUL	STEEL	G	VISION LITES	PREFIN.	—	—	STEEL	H-10	J-10	S-7	PAINTED	11	SEE MANUFACTURERS SPECIFICATIONS		
	402B EQUIPMENT BAY	1	3'-0"	7'-0"	1'-3/4"	H.M.	D	—	PAINTED	—	—	H.M.	H-7	J-7	—	PAINTED	14			
	402C EQUIPMENT BAY	1	3'-0"	7'-0"	1'-3/4"	H.M.	B	—	PAINTED	—	—	H.M.	H-7	J-7	S-4	PAINTED	10			
	403A WASH BAY	2	14'-0"	16'-0"	INSUL	STEEL	G	VISION LITES	PAINTED	—	—	STEEL	H-10	J-10	S-7	PAINTED	11	SEE MANUFACTURERS SPECIFICATIONS		
	403B WASH BAY	2	3'-0"	7'-0"	1'-3/4"	H.M.	B	—	PAINTED	—	—	H.M.	H-7	J-7	S-4	PAINTED	10			
	403C WASH BAY	2	3'-0"	7'-0"	1'-3/4"	H.M.	B	—	PAINTED	—	—	H.M.	H-7	J-7	S-4	PAINTED	10			
	403D WASH BAY	2	3'-0"	7'-0"	1'-3/4"	H.M.	B	—	PAINTED	—	—	H.M.	H-7	J-7	S-4	PAINTED	10			

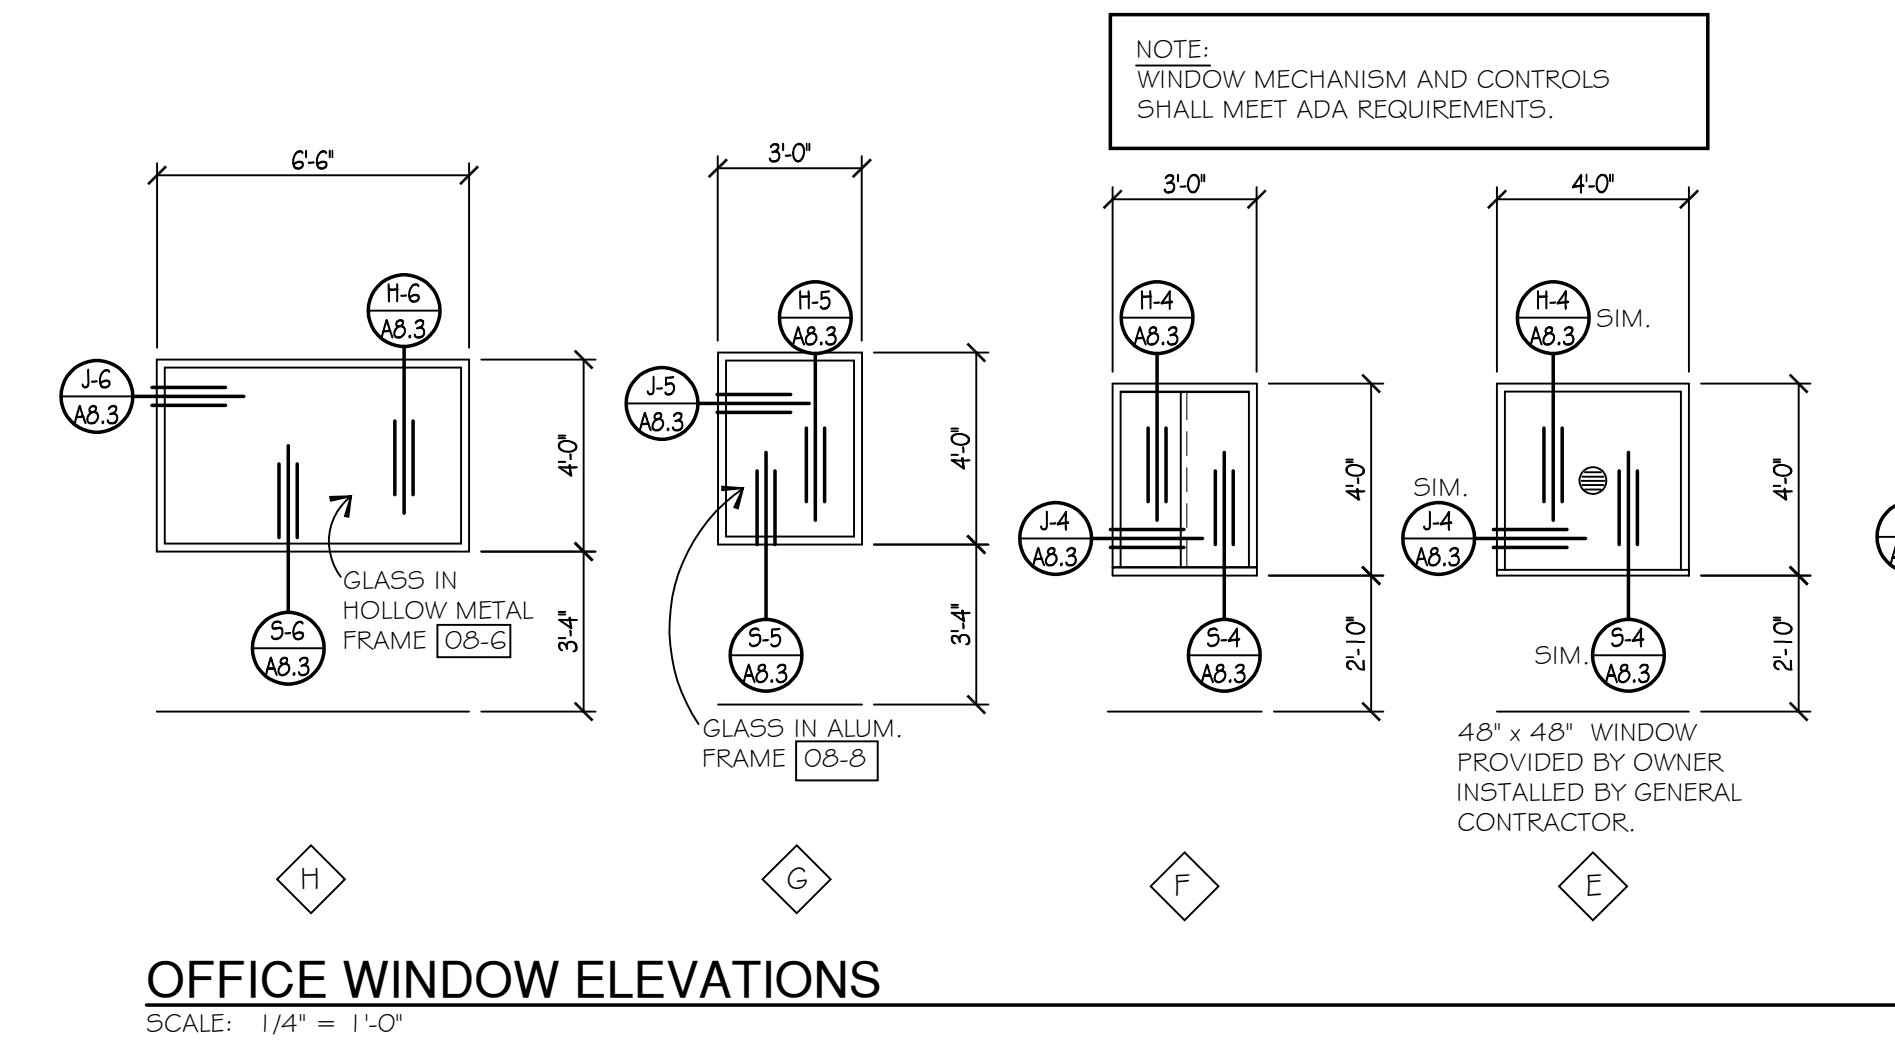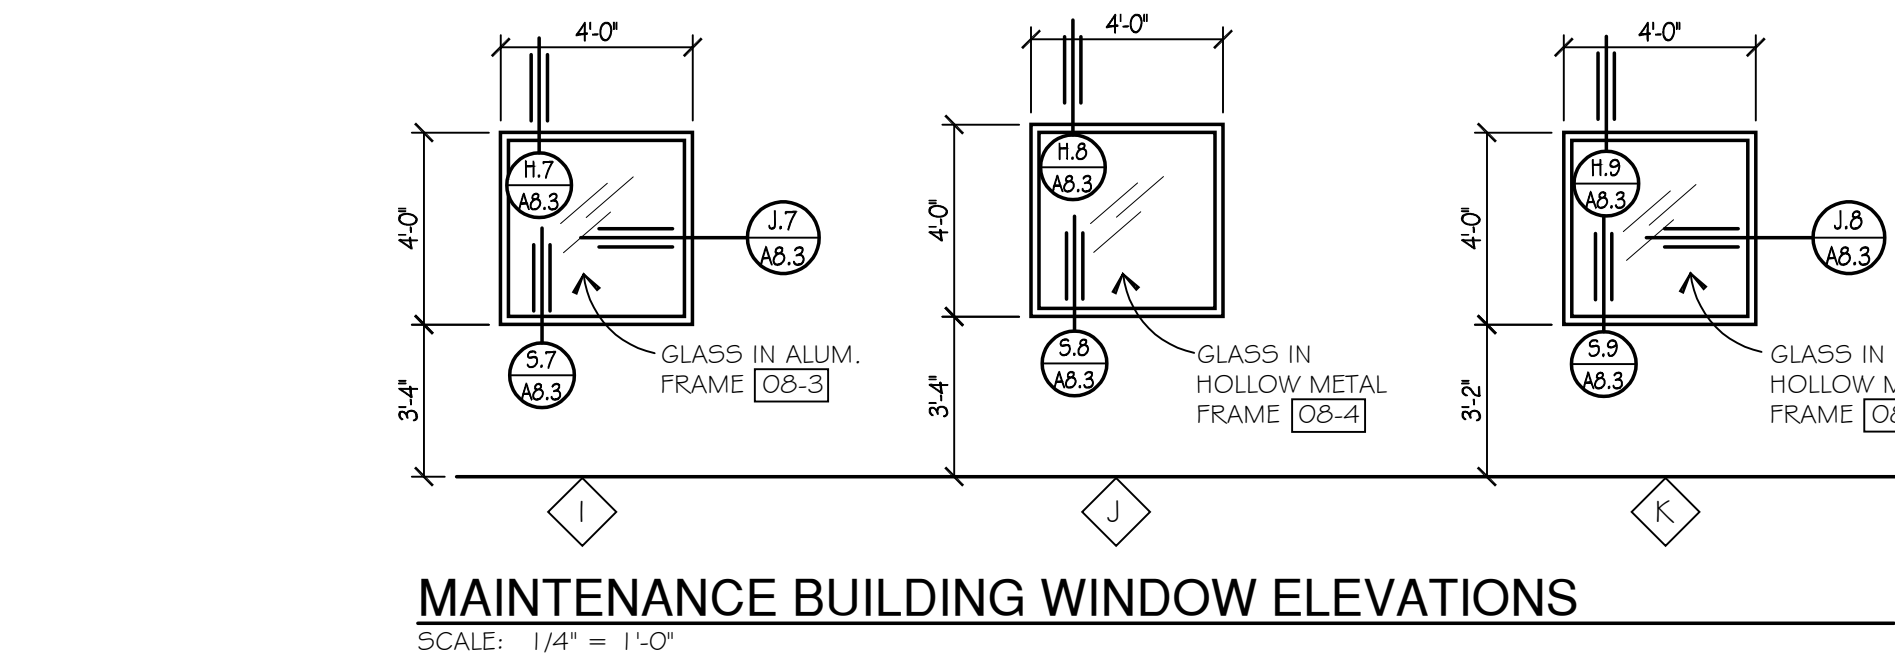

## HARDWARE SCHEDULE

<b>DOOR HDW. SET NO.1</b> 3 BUTTS 4-1/2" X 4-1/2" HEAVY DUTY HAGER BB HINGES WITH NON-REMOVABLE PINS (BY 5.F. MANUF.) 2 PUSH SETS (BY 5.F. MANUF.) 2 PULL HANDLES, ELMS DOOR HANDLES T60 10-01-001-L452 1 FAIR CONCEALED AUTOMATIC FLUSH BOLTS (INACTIVE LEAF) 2 HEAVY DUTY CLOSERS, TOP JAMB MOUNT 1 THRESHOLD, FEMAQ #255A SET ON SEALANT BED 2 SETS GASKETING AND SILL SWEEPER (BY 5.F. MANUF.) 1 "BEST LOCK" 7 PIN CYLINDER 1 ADA COMPLIANT PADDLE	<b>DOOR HDW. SET NO.7</b> 1-1/2 PR. BUTTS 4-1/2" X 4-1/2" HEAVY DUTY HINGES WITH NON-REMOVABLE PINS - HAGER BB 1279, US26D 1 SET PUSH / PULL 1 CLOSER - LCN SMOOTHIE, 4040, ALUMINUM 1 KICKPLATE - ROCKWOOD, 8" X 34" X .050", US26D 3 SILENCERS - GLYNN-JOHNSON, GJ64, GREY 1 DOOR SWEEP - PROVIDE AT DOOR 114 ONLY	<b>DOOR HDW. SET NO.13</b> 1 LOCKSET - ENTRY LOCKSET - SCHLAGE AL53PD, SATURN, T-STRIKE 1 LOCKSET - PASSAGE LOCKSET - SCHLAGE AL70PD, SATURN, T-STRIKE 1 CLOSER - LCN SMOOTHIE, 4040, ALUMINUM 1 KICKPLATE - ROCKWOOD, 8" X 34" X .050", US26D 3 SILENCERS - GLYNN-JOHNSON, GJ64, GREY 1 PAIR MANUAL FLUSH BOLTS
<b>DOOR HDW. SET NO.2</b> 1-1/2 PR. BUTTS 4-1/2" X 4-1/2" HEAVY DUTY HINGES WITH NON-REMOVABLE PINS - HAGER BB 1279, US26D 1 LOCKSET - OFFICE LOCKSET - SCHLAGE AL50PD, SATURN, T-STRIKE 1 KICKPLATE - ROCKWOOD, 8" X 34" X .050", US26D 3 SILENCERS - GLYNN-JOHNSON, GJ64, GREY	<b>DOOR HDW. SET NO.8</b> 1-1/2 PR. BUTTS 4-1/2" X 4-1/2" HEAVY DUTY HINGES WITH NON-REMOVABLE PINS - HAGER BB 1279, US26D 1 LOCKSET - ENTRY LOCKSET - SCHLAGE AL53PD, SATURN, T-STRIKE 1 CLOSER - LCN SMOOTHIE, 4040, ALUMINUM 1 CLOSER - LCN SMOOTHIE, 4040, ALUMINUM 1 EXIT DEVICE - 64 8804 FSW SARGENT 1 KICKPLATE - ROCKWOOD, 8" X 34" X .050", US26D 3 SILENCERS - GLYNN-JOHNSON, GJ64, GREY	<b>DOOR HDW. SET NO.14</b> 1-1/2 PR. BUTTS 4-1/2" X 4-1/2" HEAVY DUTY HINGES WITH NON-REMOVABLE PINS - HAGER BB 1279, US26D 1 LOCKSET - ENTRY LOCKSET - SCHLAGE AL53PD, SATURN, T-STRIKE 1 CLOSER - LCN SMOOTHIE, 4040, ALUMINUM 1 KICKPLATE - ROCKWOOD, 8" X 34" X .050", US26D 3 SILENCERS - GLYNN-JOHNSON, GJ64, GREY 1 DOOR SWEEP - PROVIDE AT DOOR 301B AND 303C ONLY
<b>DOOR HDW. SET NO.3</b> 1-1/2 PR. BUTTS 4-1/2" X 4-1/2" HEAVY DUTY HINGES WITH NON-REMOVABLE PINS - HAGER BB 1279, US26D 1 LOCKSET - STORAGE LOCKSET - SCHLAGE AL40S, SATURN, T-STRIKE 1 KICKPLATE - ROCKWOOD, 8" X 34" X .050", US26D 3 SILENCERS - GLYNN-JOHNSON, GJ64, GREY	<b>DOOR HDW. SET NO.9</b> COMMERCIAL, CHAIN HOIST, INSULATED COILING ROLL-UP DOOR, SLATS PRE-FINISHED WHITE. SEE SPECIFICATIONS FOR APPROVED MANUFACTURERS	<b>DOOR HDW. SET NO.15</b> 




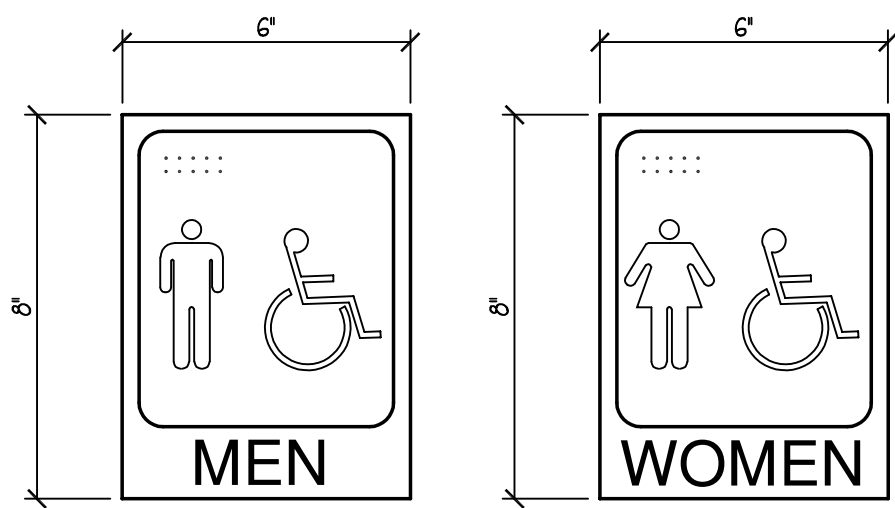

1. MANUFACTURER MODEL: CAL-ROYAL / MH-68 WITH BRAILLE.
2. TWO PLATES THIS SIZE FOR PUBLIC TOILET ROOMS AS REQUIRED FOR EACH SEX.
3. VERIFY AND MEET ADA ACCESSIBILITY CODE STANDARDS.
4. (703.4.1) TACTILE CHARACTERS ON SIGNS SHALL BE LOCATED 48" MINIMUM ABOVE FINISH FLOOR OR GROUND SURFACE, MEASURED FROM THE BASELINE OF THE LOWEST TACTILE CHARACTER AND 60" MAXIMUM ABOVE THE FINISHED FLOOR OR GROUND SURFACE, MEASURED TO THE BASELINE OF THE HIGHEST TACTILE CHARACTER.
5. (703.4.2) SIGNS CONTAINING TACTILE CHARACTERS SHALL BE LOCATED SO THAT A CLEAR FLOOR SPACE 18" MINIMUM BY 18" MINIMUM IS CENTERED ON THE TACTILE CHARACTERS.
6. 1/32" GRADE II BRAILLE 1/32" RAISED LETTERS AND GRAPHICS.


#### TYPICAL SIGNAGE DETAIL

SCALE: NONE

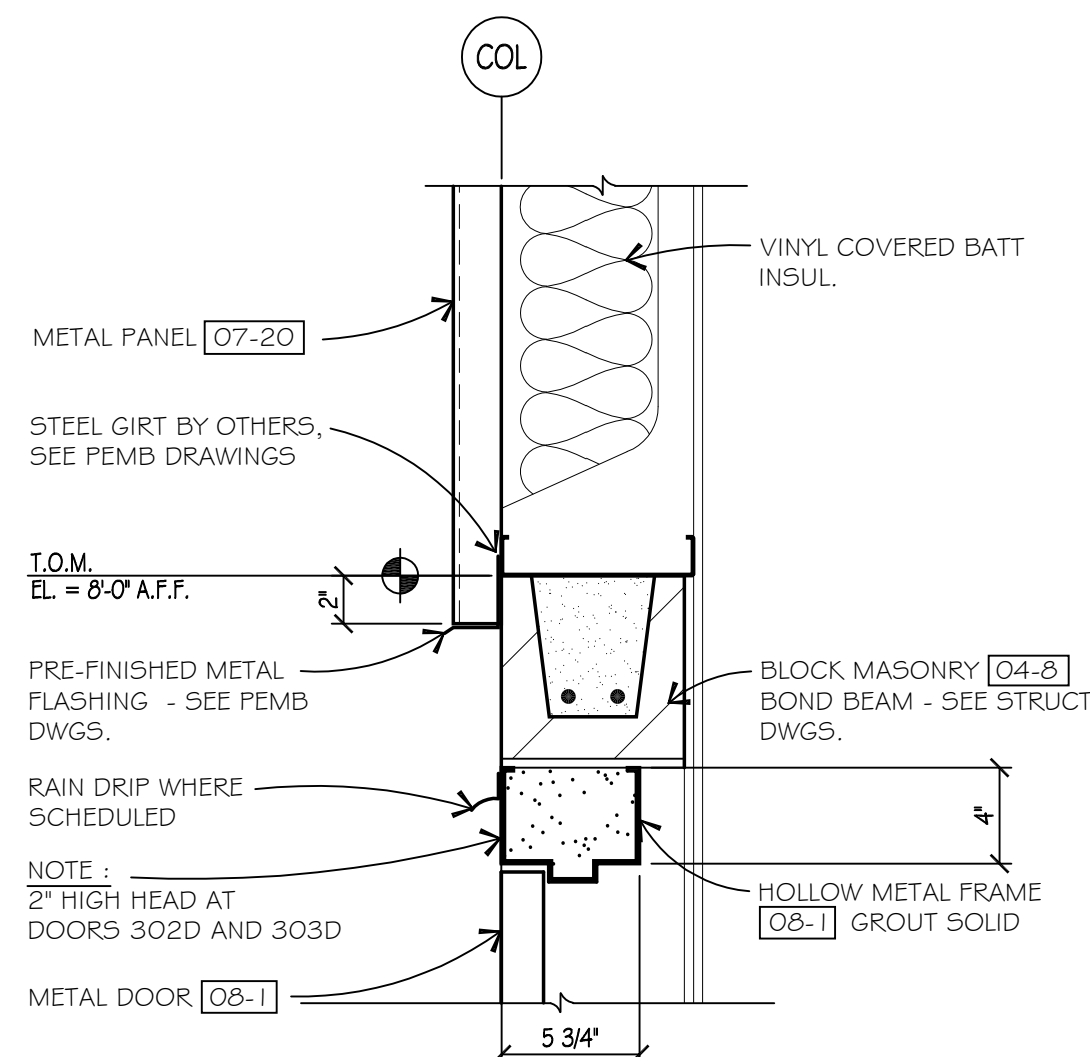


#### HEAD DETAIL H-11

SCALE: 1-1/2" = 1'-0"

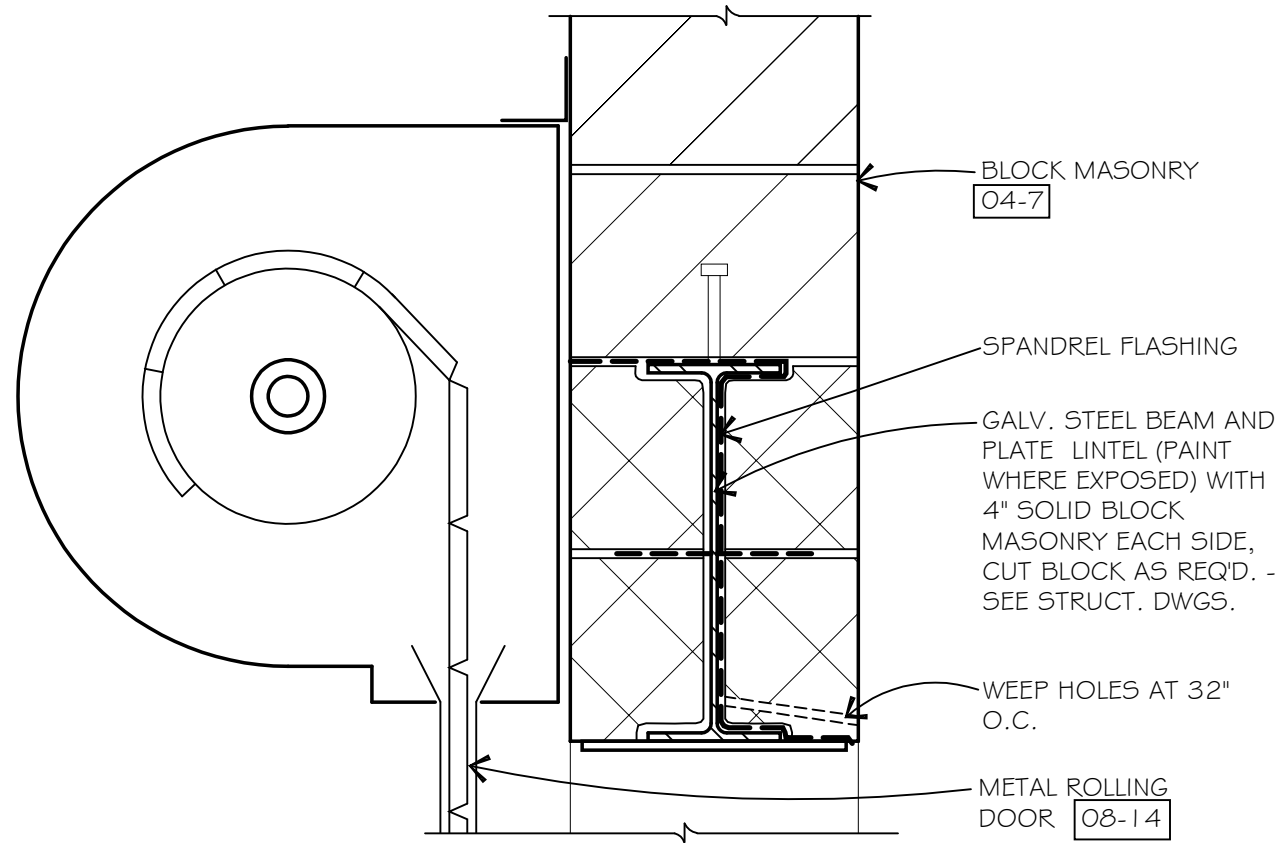


#### HEAD DETAIL H-10

SCALE: 1-1/2" = 1'-0"

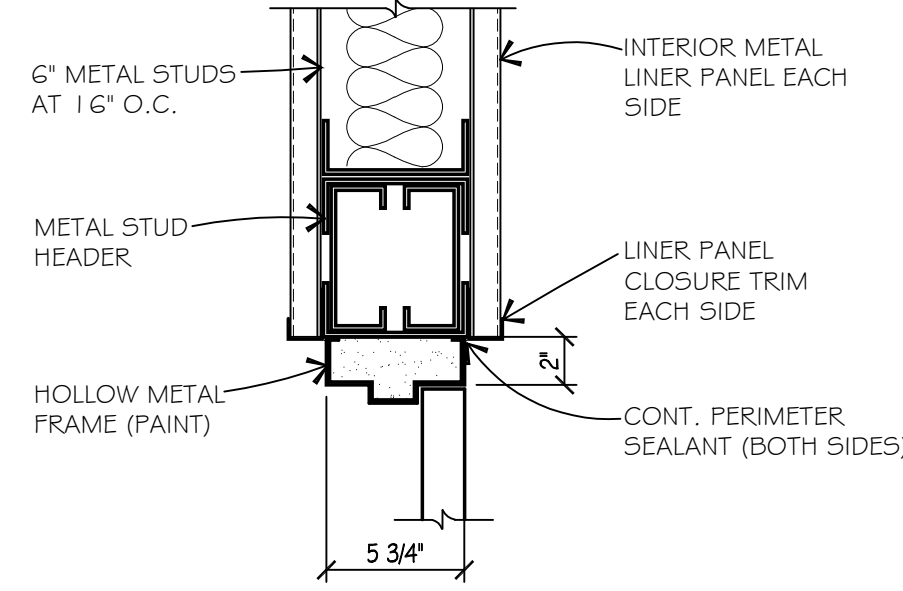


#### HEAD DETAIL H-9

SCALE: 1-1/2" = 1'-0"

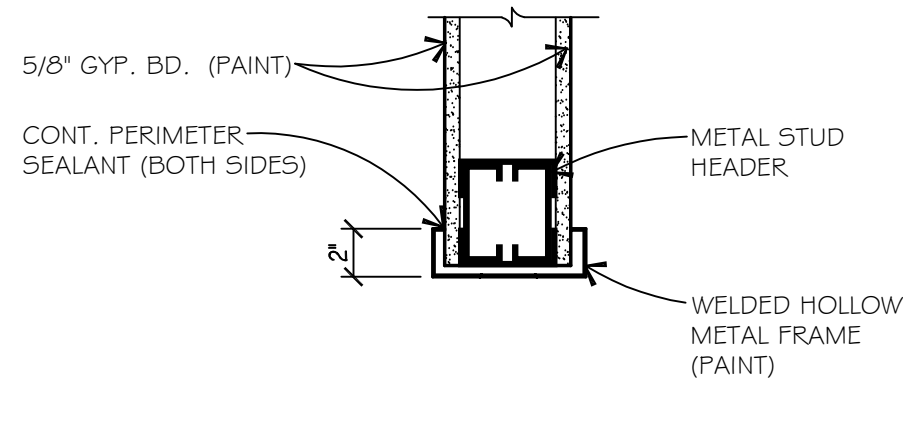


#### HEAD DETAIL H-8

SCALE: 1-1/2" = 1'-0"

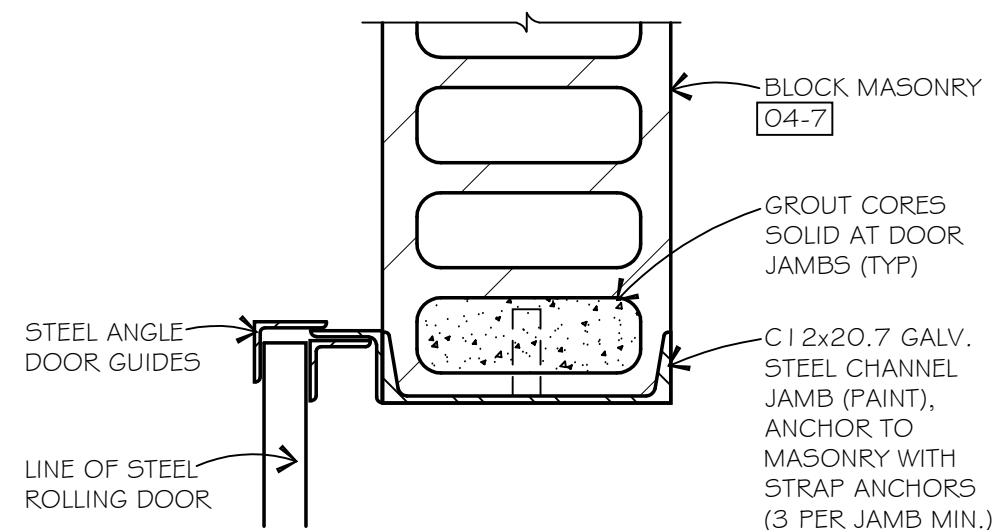


#### JAMB DETAIL J-10

SCALE: 1-1/2" = 1'-0"

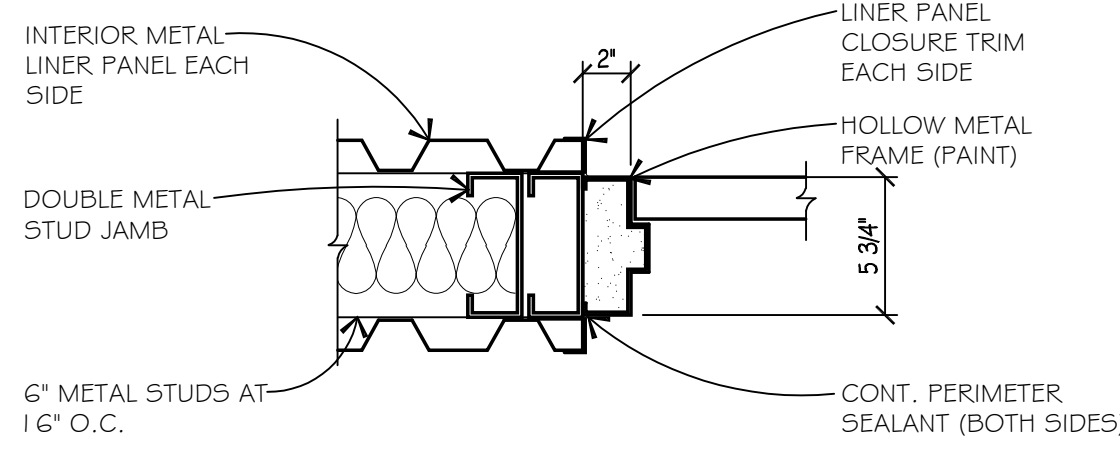


#### JAMB DETAIL J-9

SCALE: 1-1/2" = 1'-0"

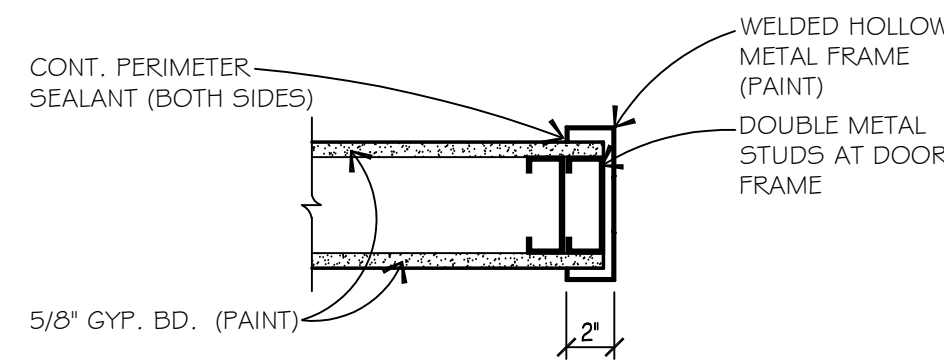


#### JAMB DETAIL J-8

SCALE: 1-1/2" = 1'-0"

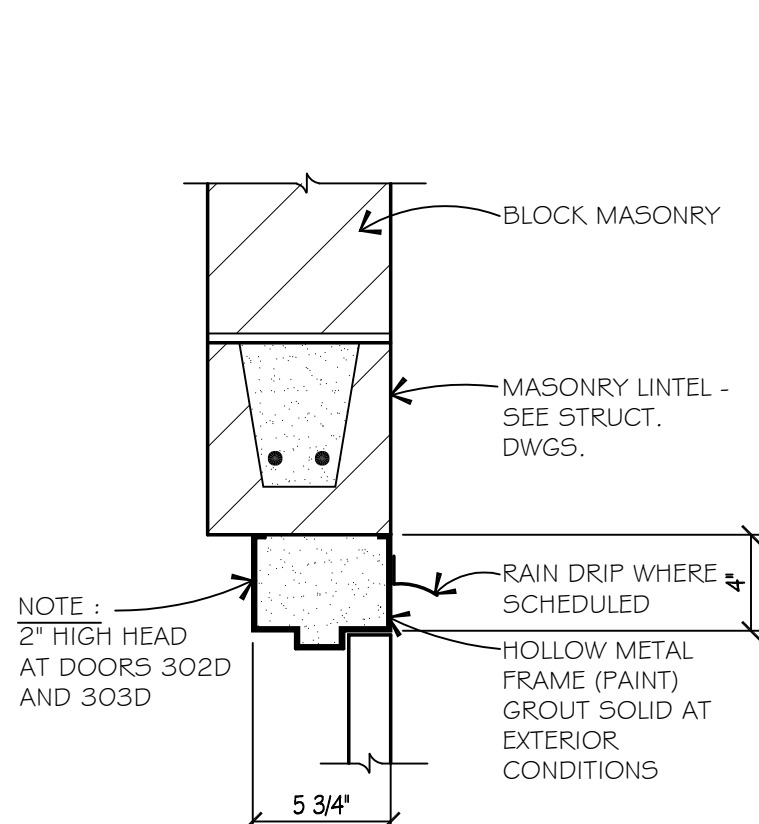


#### JAMB DETAIL H-7

SCALE: 1-1/2" = 1'-0"

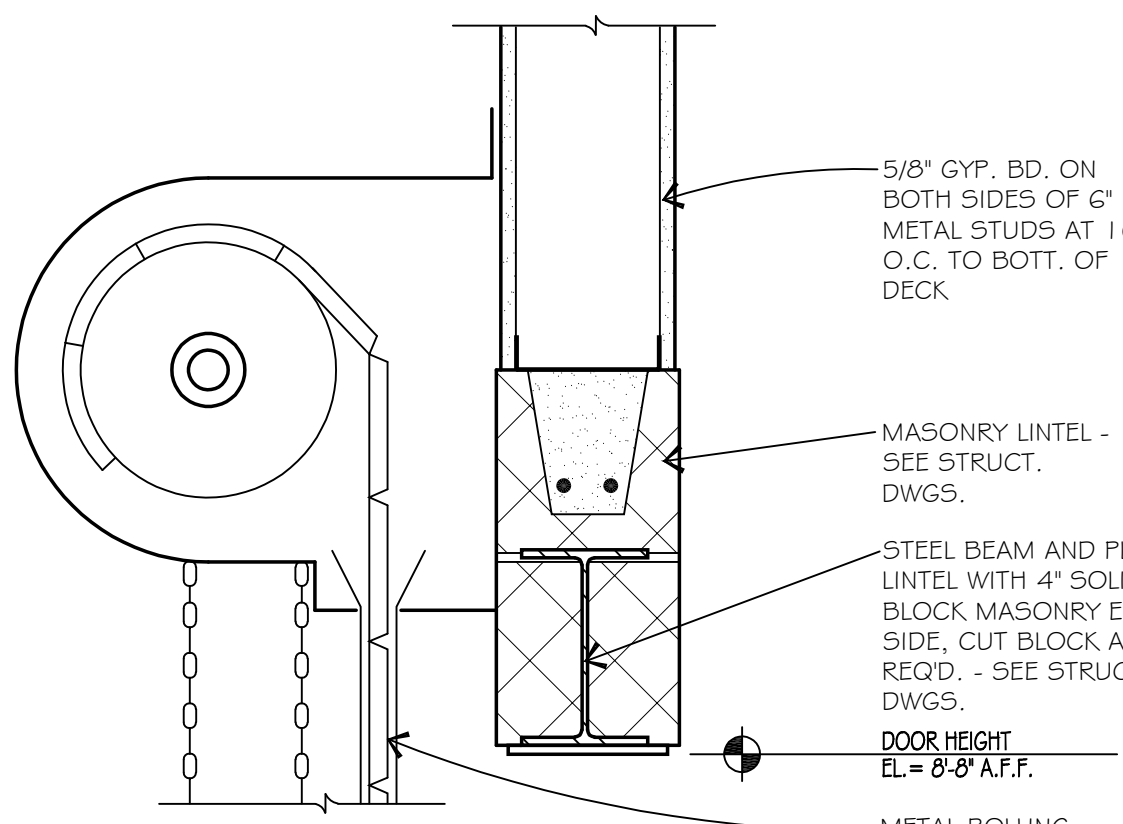


#### HEAD DETAIL H-6

SCALE: 1-1/2" = 1'-0"

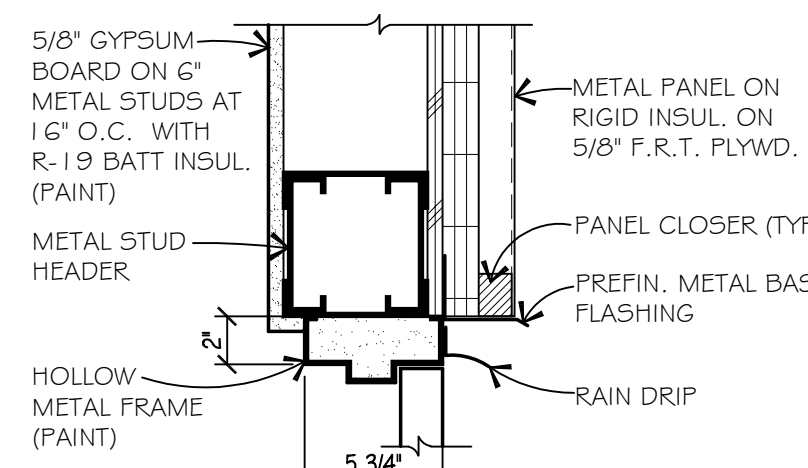


#### HEAD DETAIL H-5

SCALE: 1-1/2" = 1'-0"

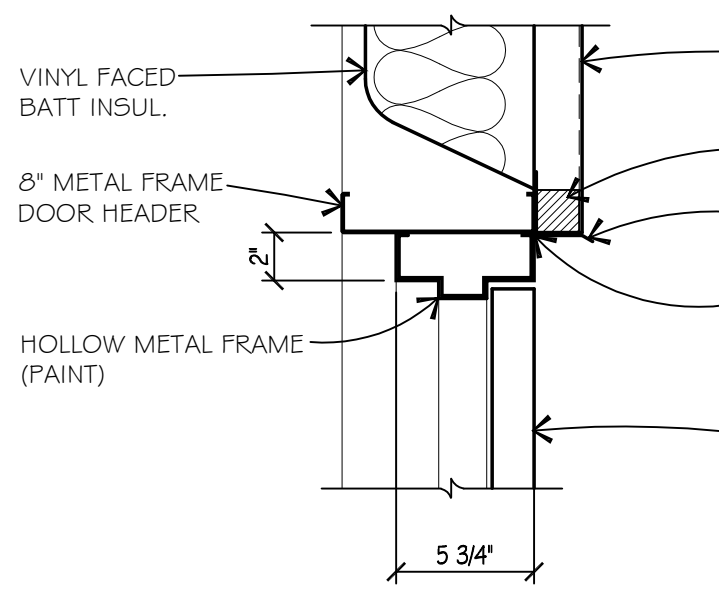


#### HEAD DETAIL H-4

SCALE: 1-1/2" = 1'-0"

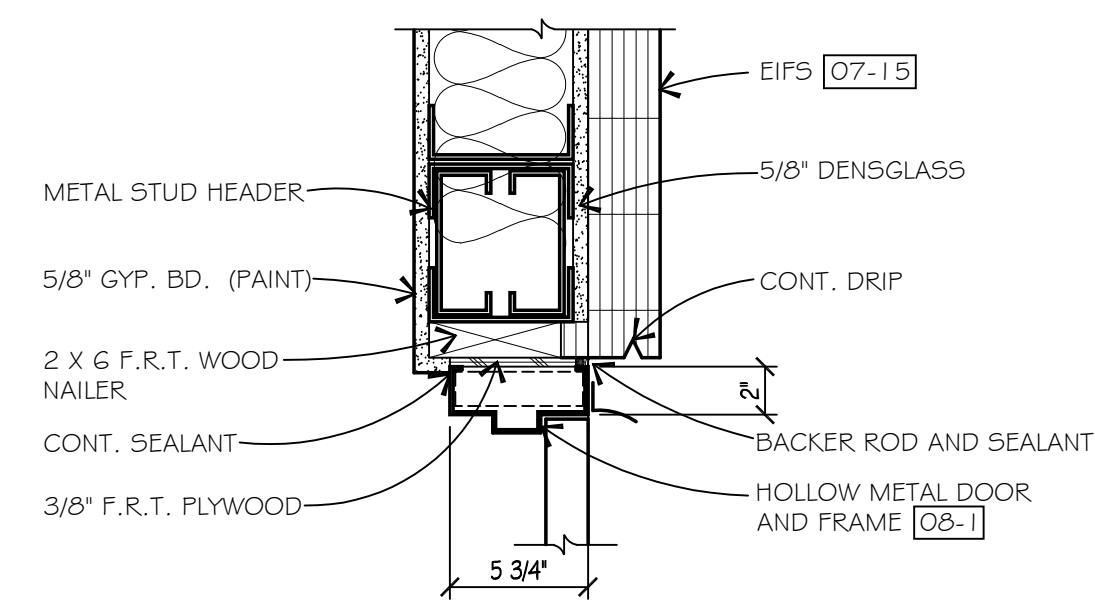


#### HEAD DETAIL H-3

SCALE: 1-1/2" = 1'-0"

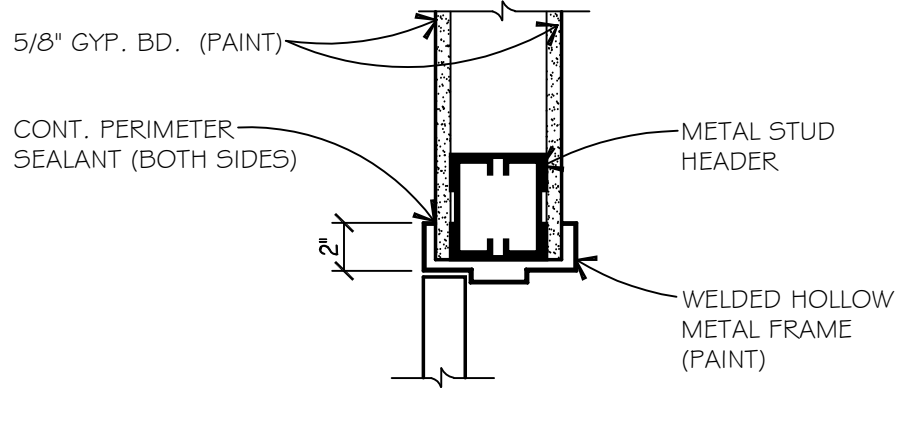


#### HEAD DETAIL H-2

SCALE: 1-1/2" = 1'-0"

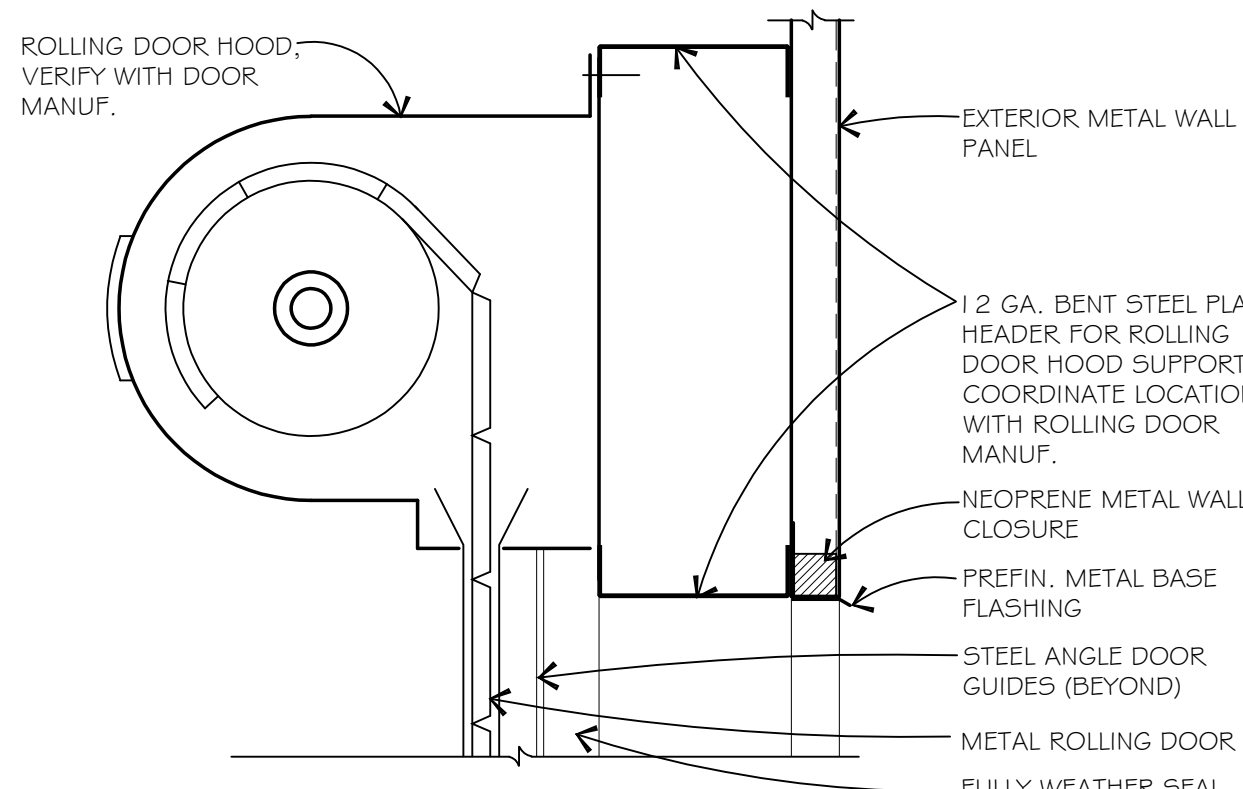


#### HEAD DETAIL H-1

SCALE: 1-1/2" = 1'-0"

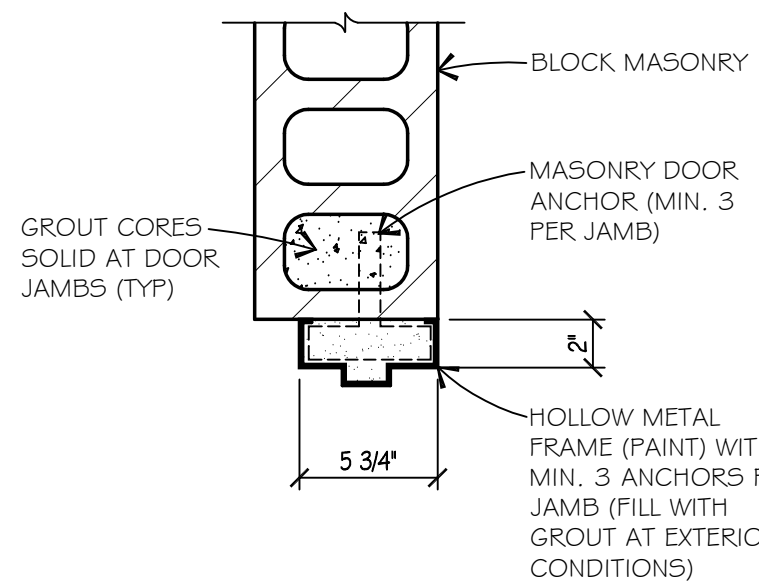


#### JAMB DETAIL J-7

SCALE: 1-1/2" = 1'-0"

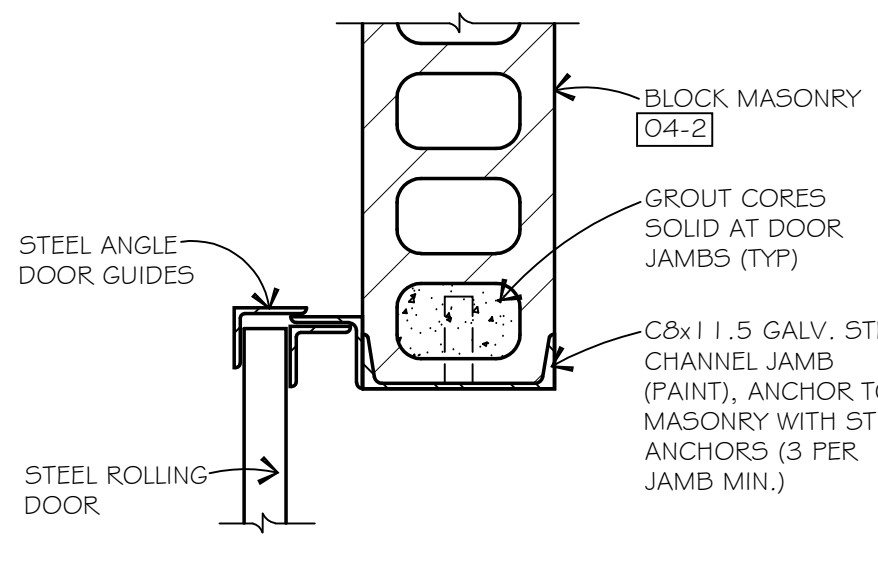


#### JAMB DETAIL J-6

SCALE: 1-1/2" = 1'-0"

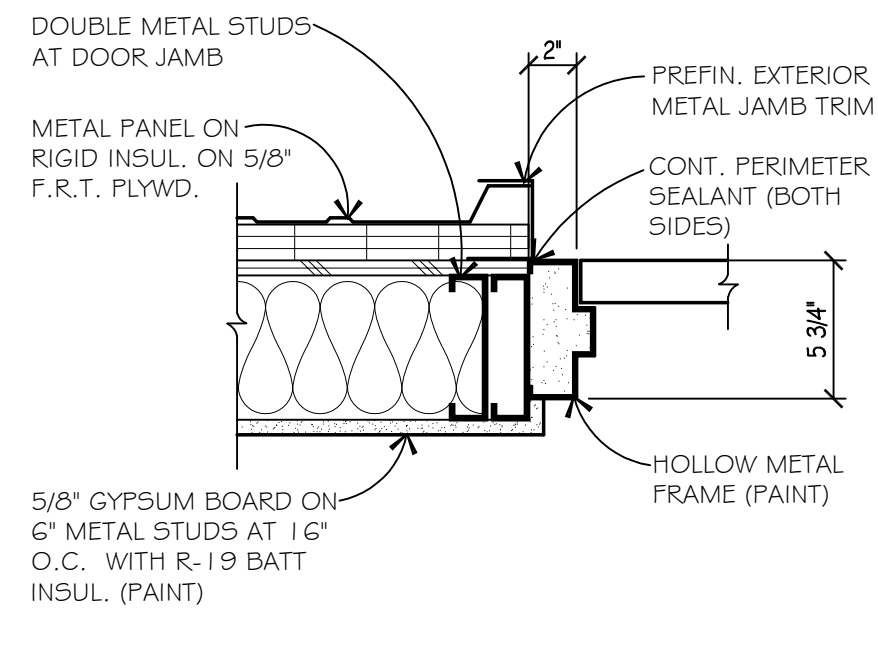


#### JAMB DETAIL J-5

SCALE: 1-1/2" = 1'-0"

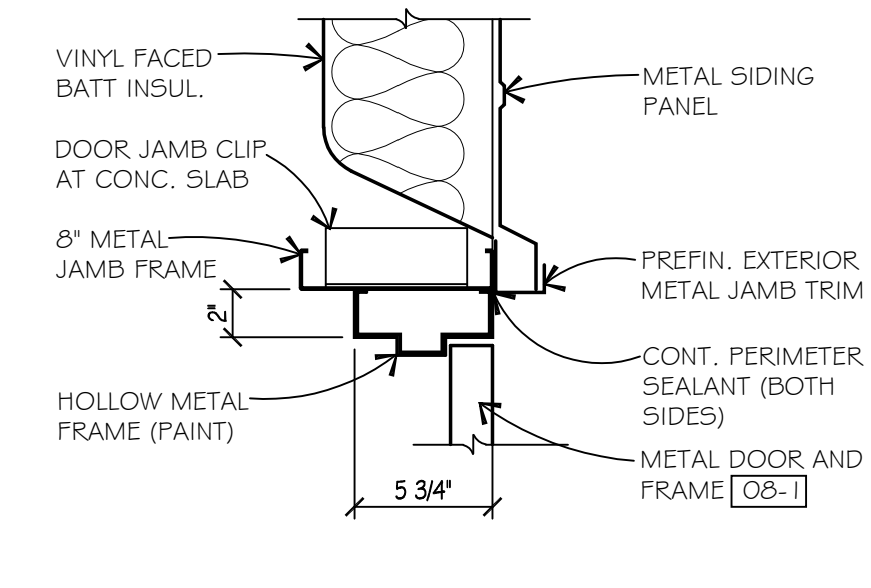


#### JAMB DETAIL J-4

SCALE: 1-1/2" = 1'-0"

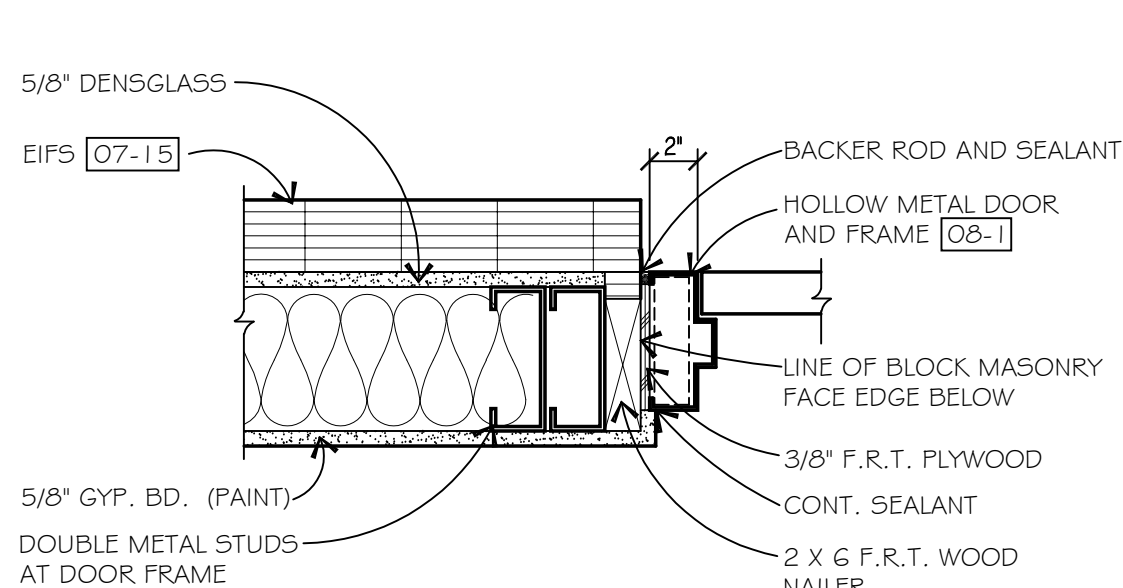


#### JAMB DETAIL J-3

SCALE: 1-1/2" = 1'-0"

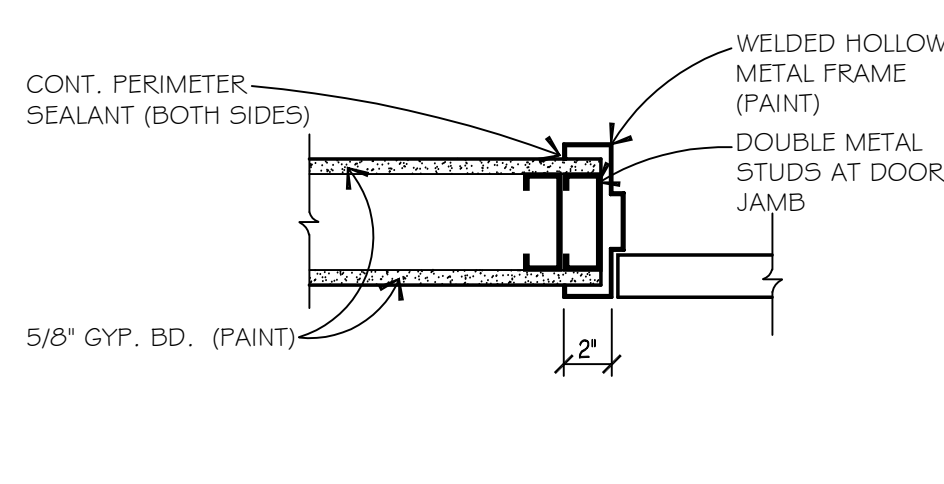


#### JAMB DETAIL J-2

SCALE: 1-1/2" = 1'-0"

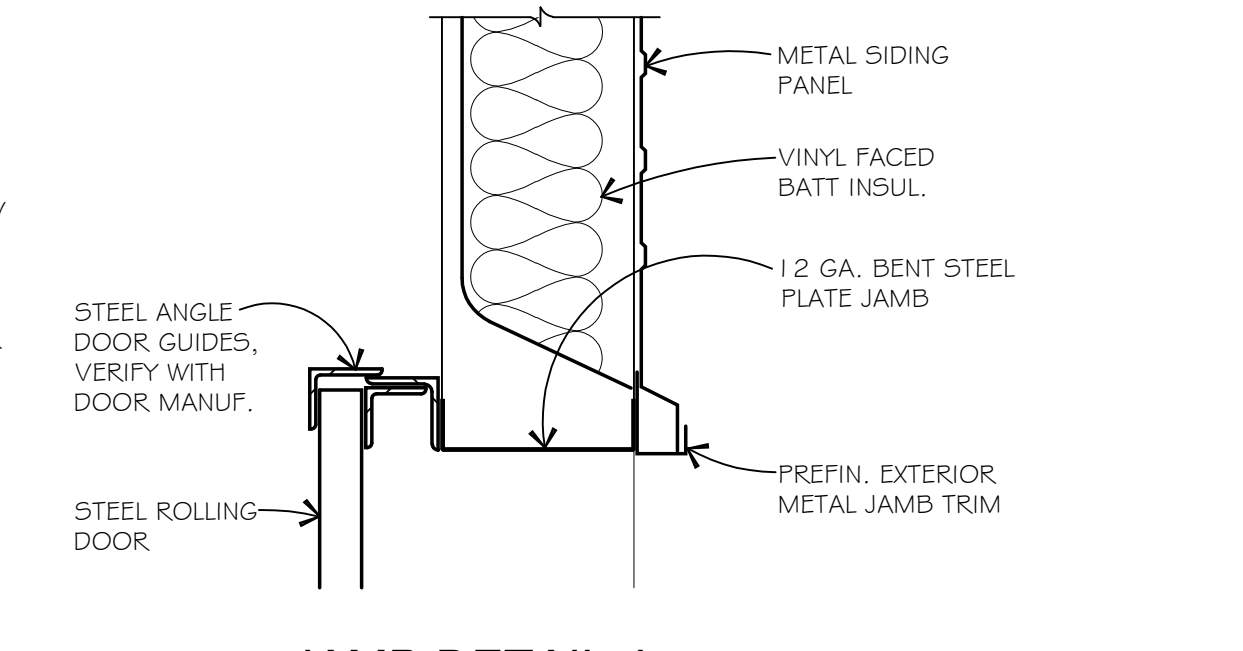


#### JAMB DETAIL J-1

SCALE: 1-1/2" = 1'-0"

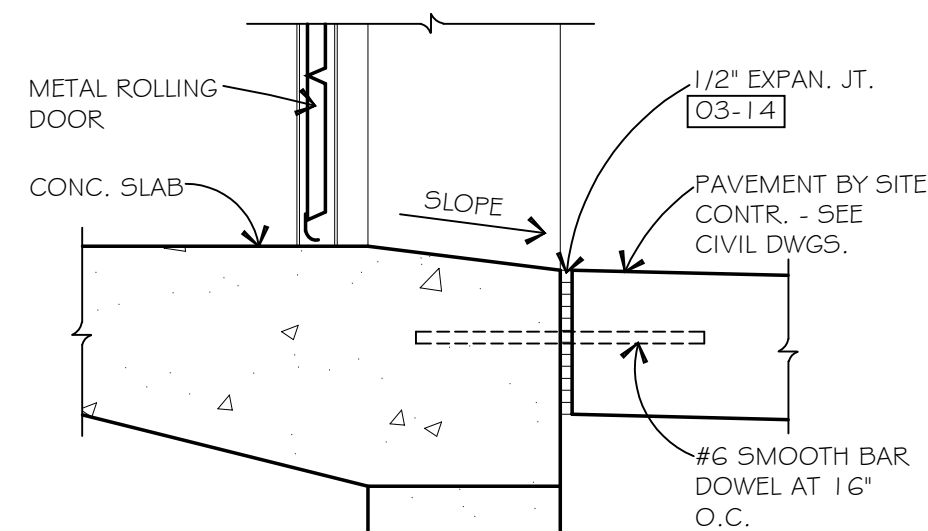


#### SILL DETAIL S-7

SCALE: 1-1/2" = 1'-0"

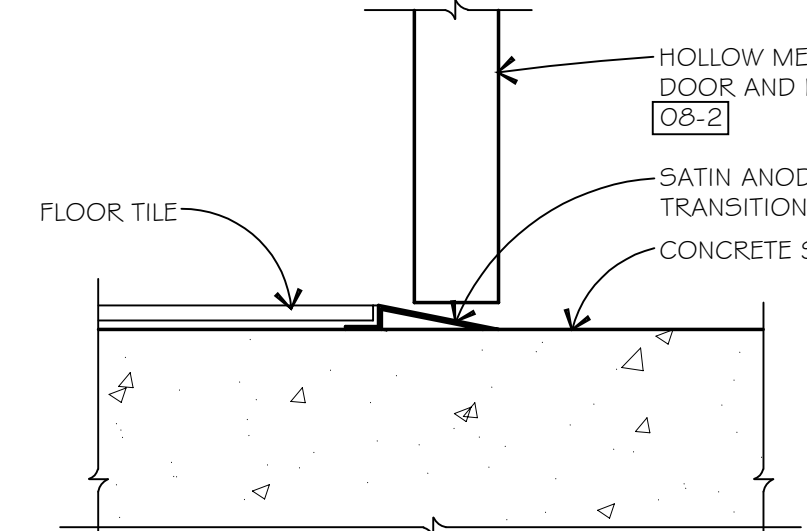


#### SILL DETAIL S-6

SCALE: 3" = 1'-0"

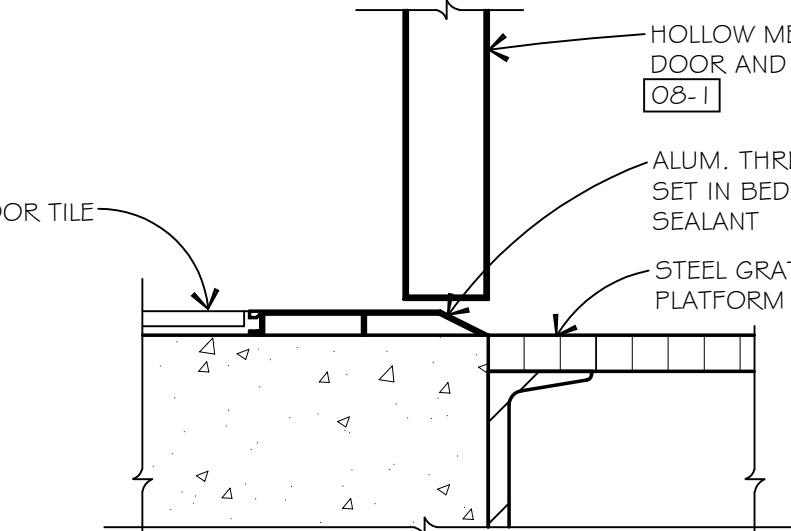


#### SILL DETAIL S-5

SCALE: 3" = 1'-0"

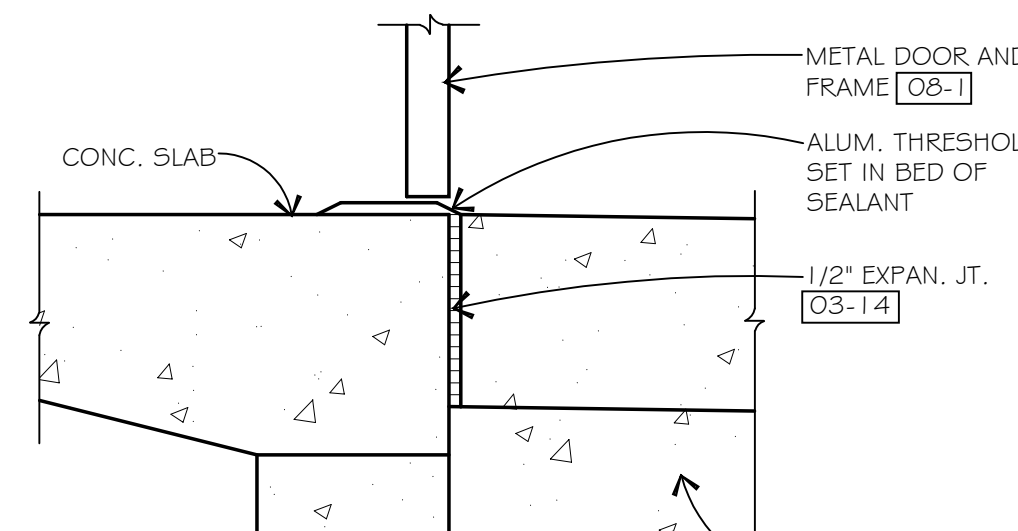


#### SILL DETAIL S-4

SCALE: 3" = 1'-0"

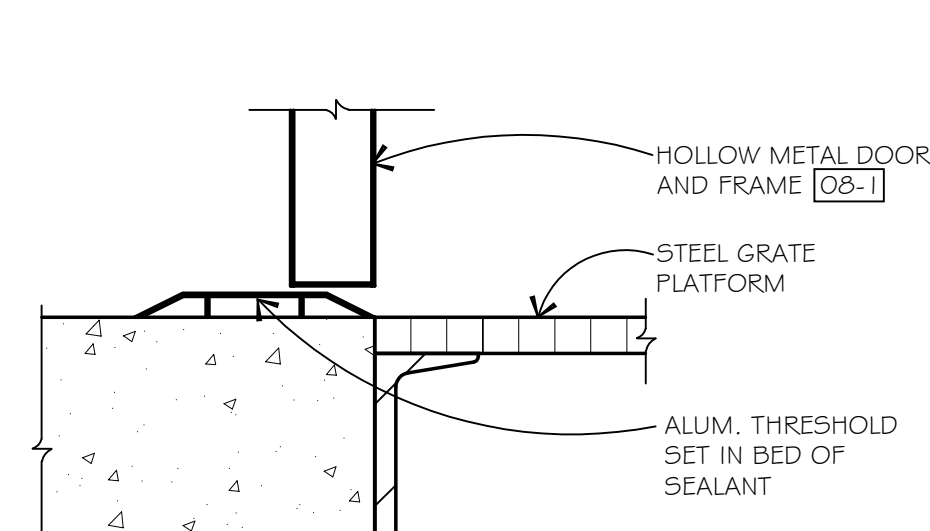


#### SILL DETAIL S-3

SCALE: 3" = 1'-0"

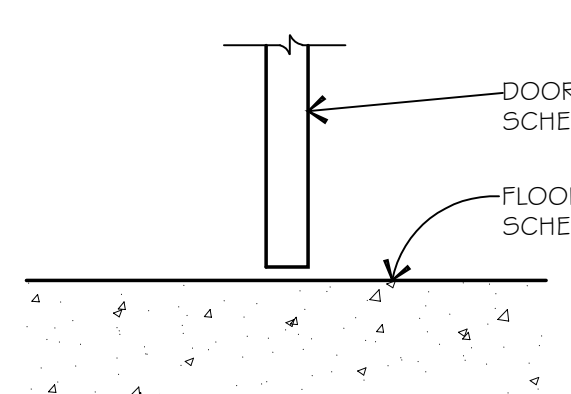

#### SILL DETAIL S-2

SCALE: 1-1/2" = 1'-0"

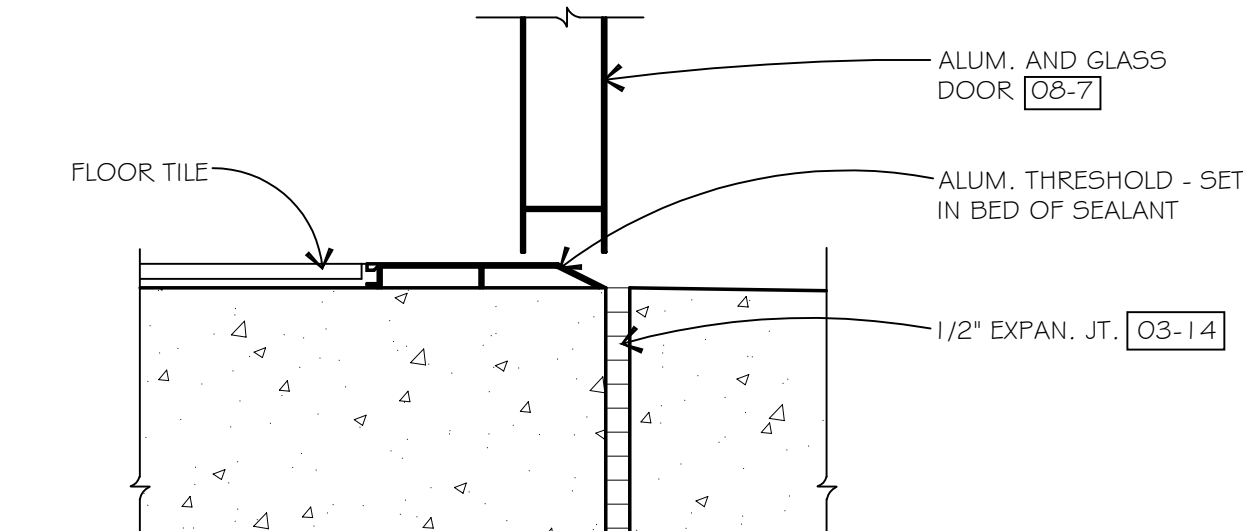


#### SILL DETAIL S-1

SCALE: 3" = 1'-0"


#### DOOR DETAILS



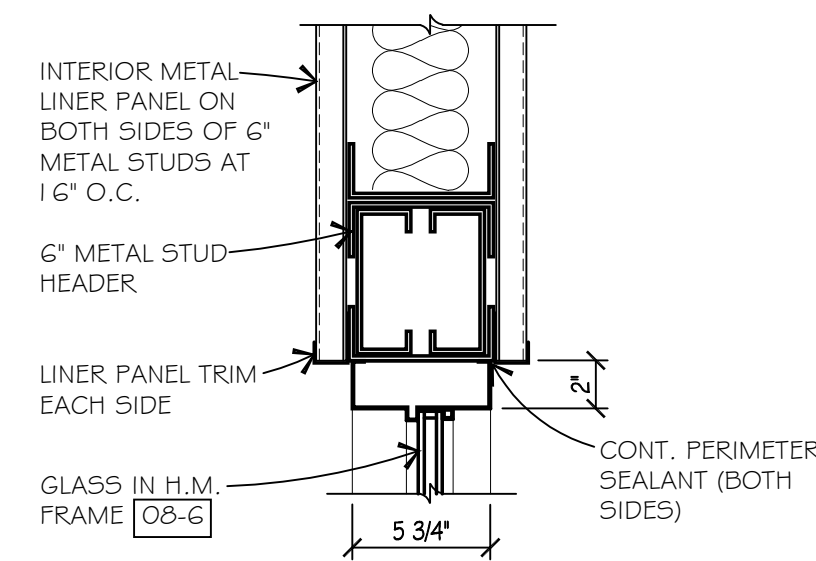


HEAD DETAIL H-9

SCALE: 1-1/2" = 1'-0"

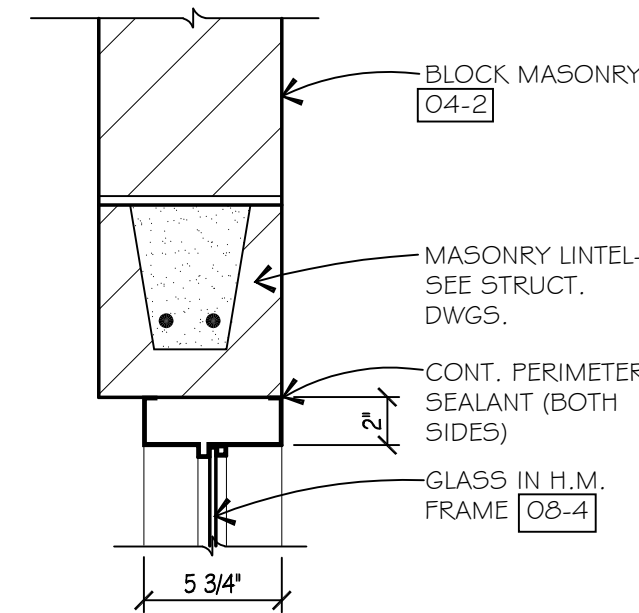


HEAD DETAIL H-8

SCALE: 1-1/2" = 1'-0"

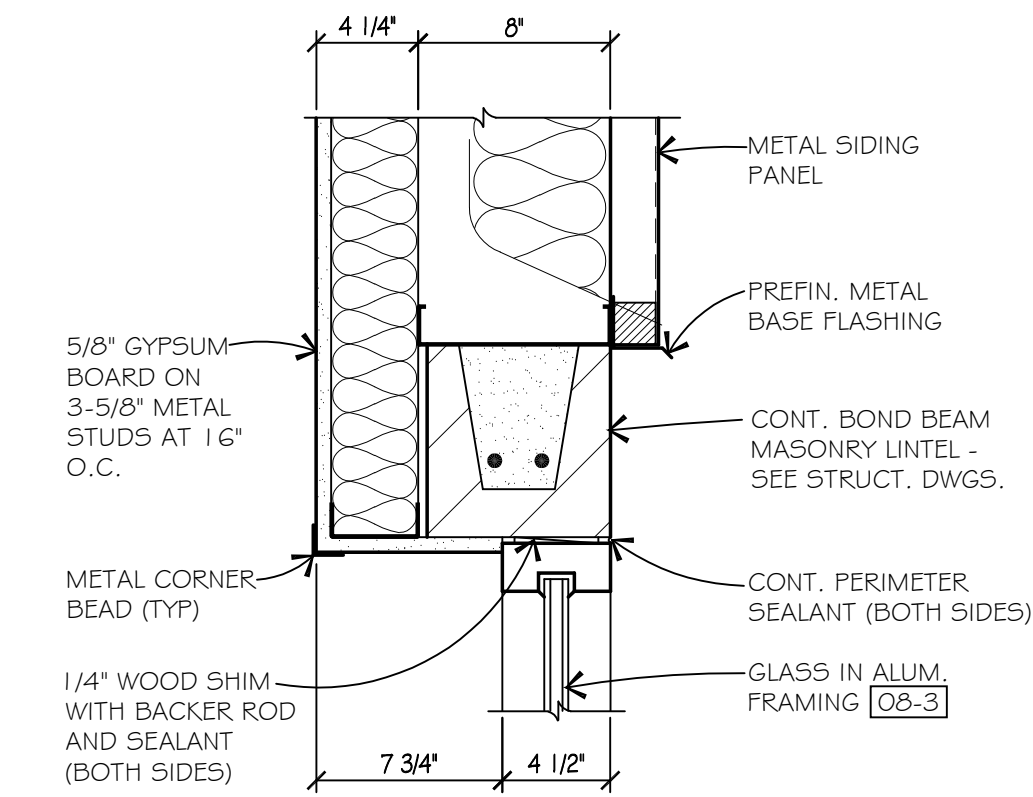


HEAD DETAIL H-7

SCALE: 1-1/2" = 1'-0"

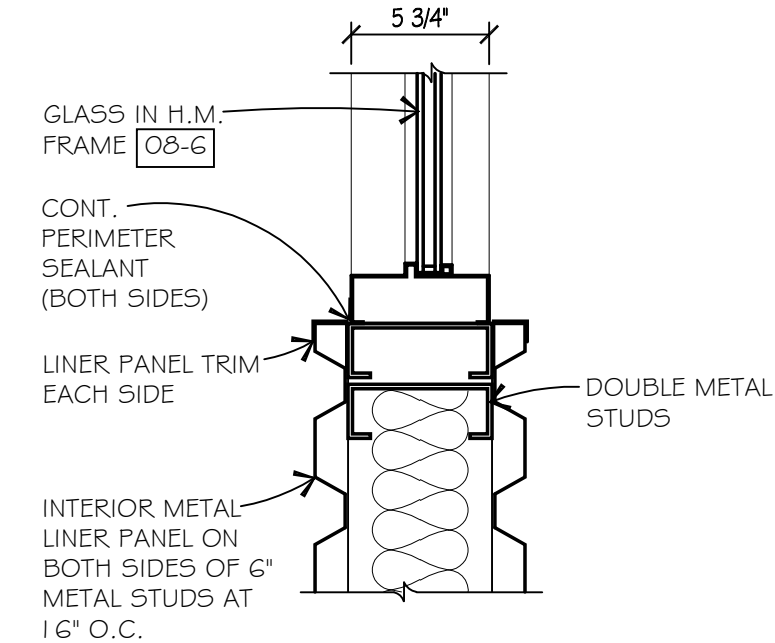


JAMB DETAIL J8

SCALE: 1-1/2" = 1'-0"

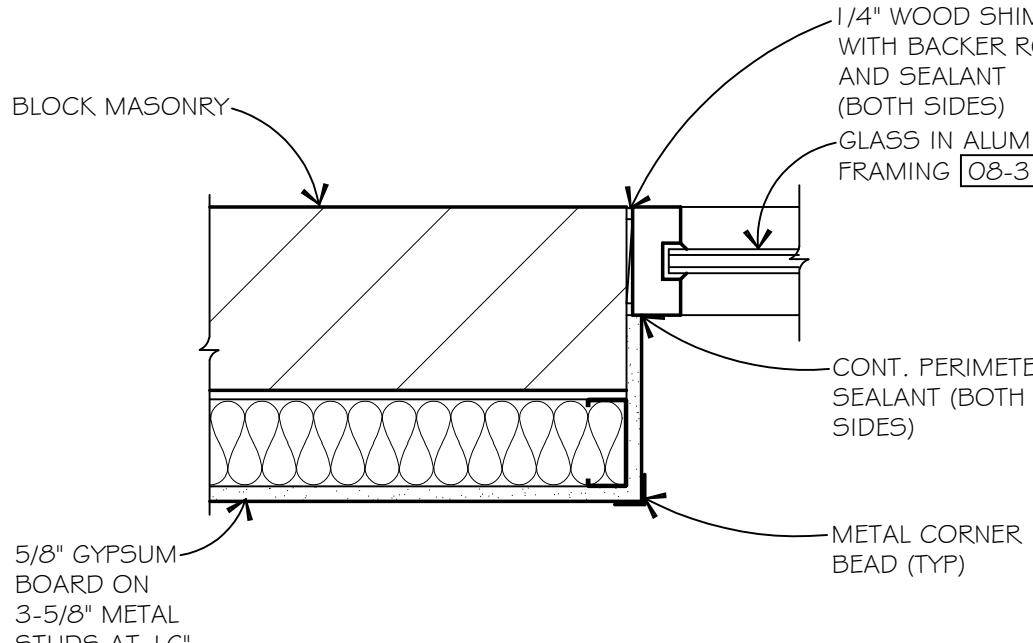


JAMB DETAIL J7

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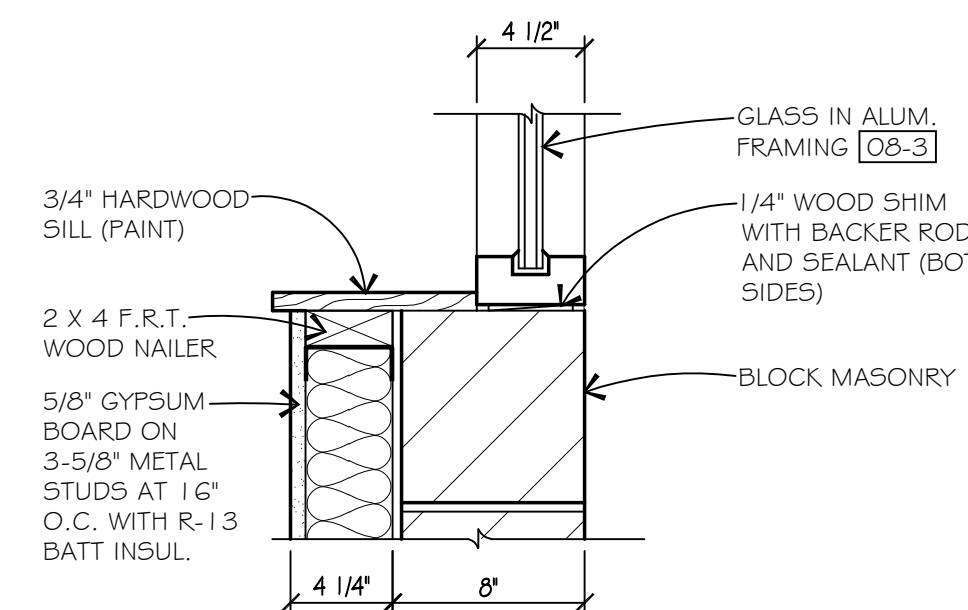
SILL DETAIL S-9

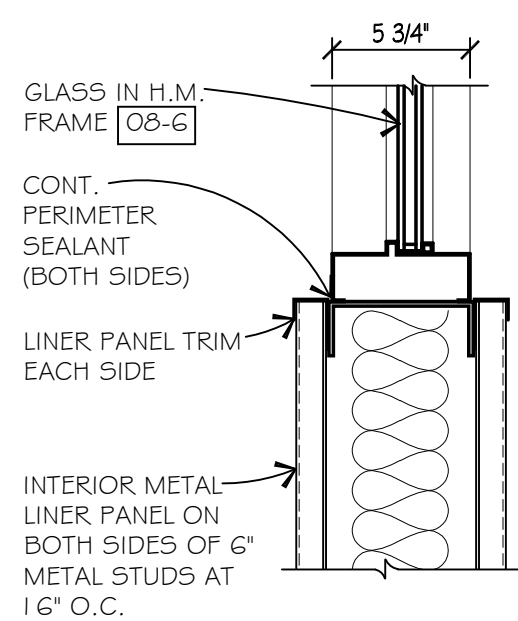SCALE: 1-1/2" = 1'-0"




SILL DETAIL S-8
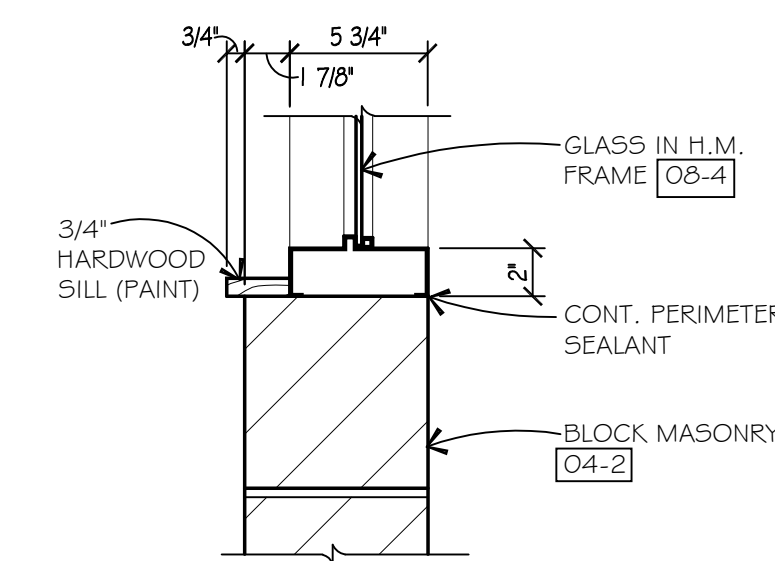
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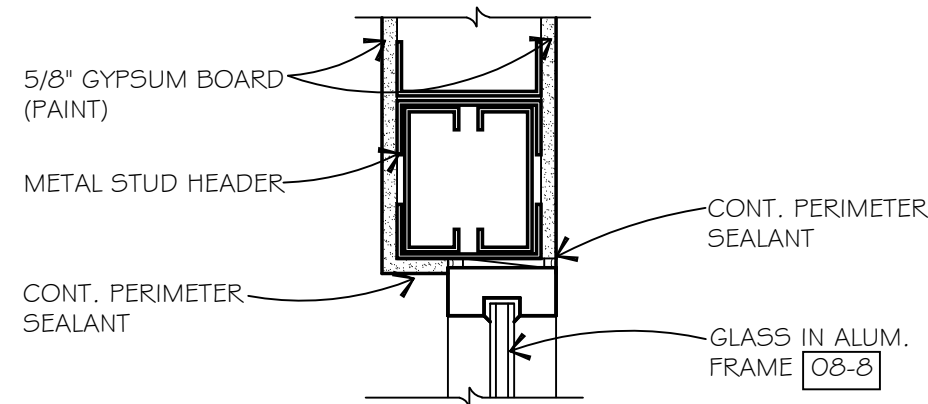
SILL DETAIL S-7

SCALE: 1-1/2" = 1'-0"




HEAD DETAIL H-6

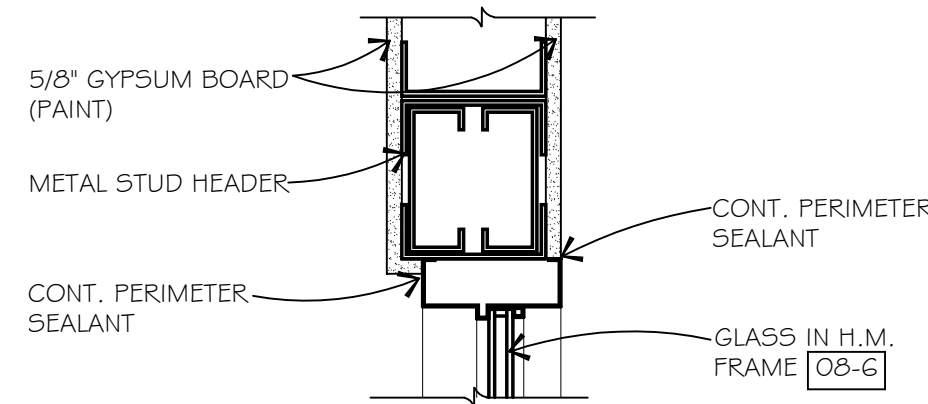SCALE: 1-1/2" = 1'-0"




HEAD DETAIL H-5

SCALE: 1-1/2" = 1'-0"

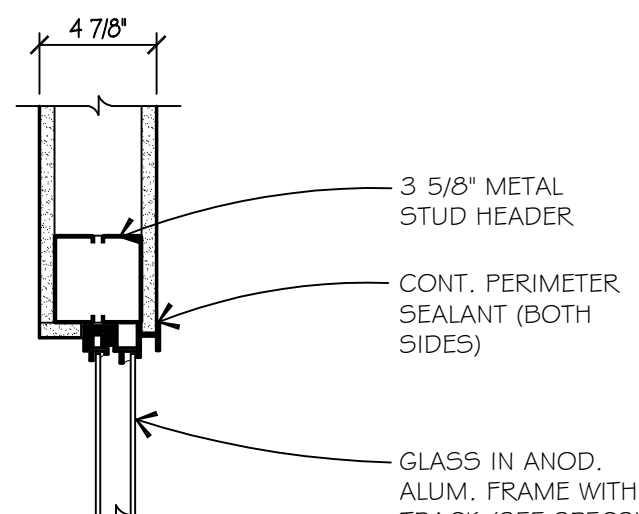


HEAD DETAIL H-4

SCALE: 1-1/2" = 1'-0"

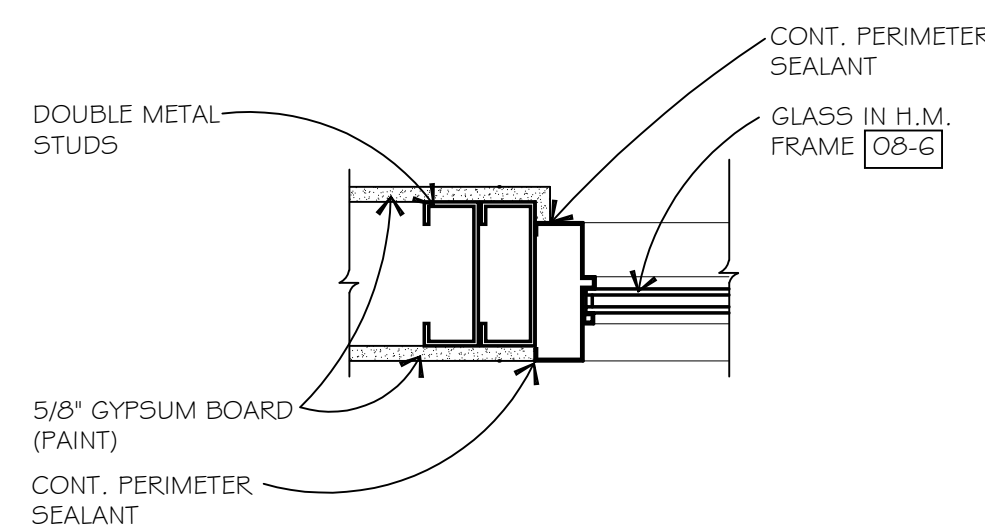


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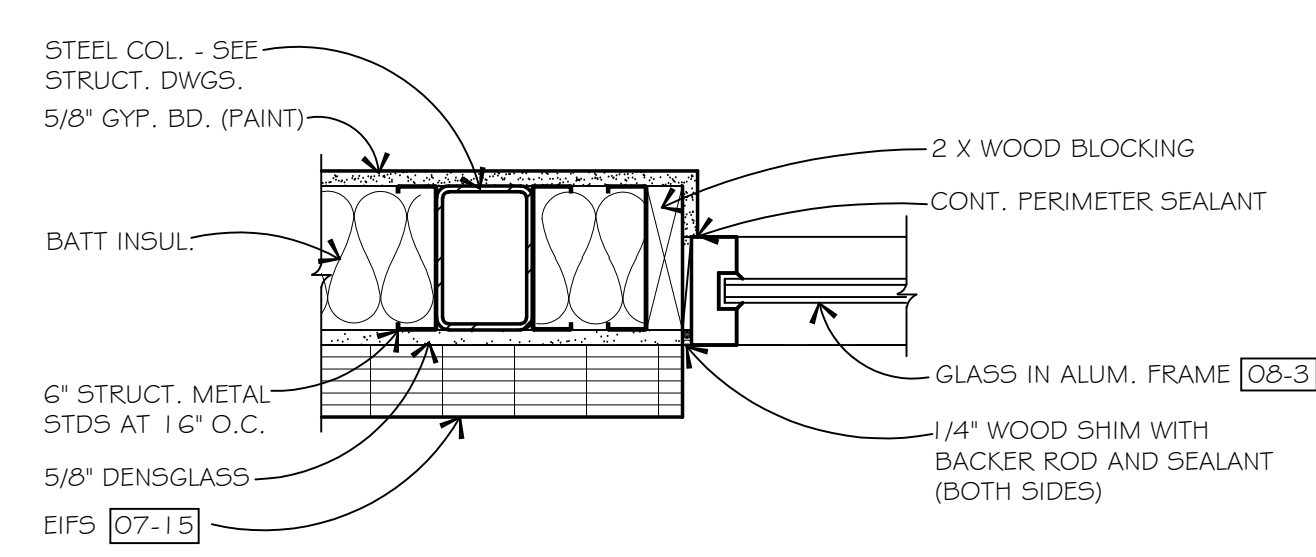
JAMB DETAIL J-5

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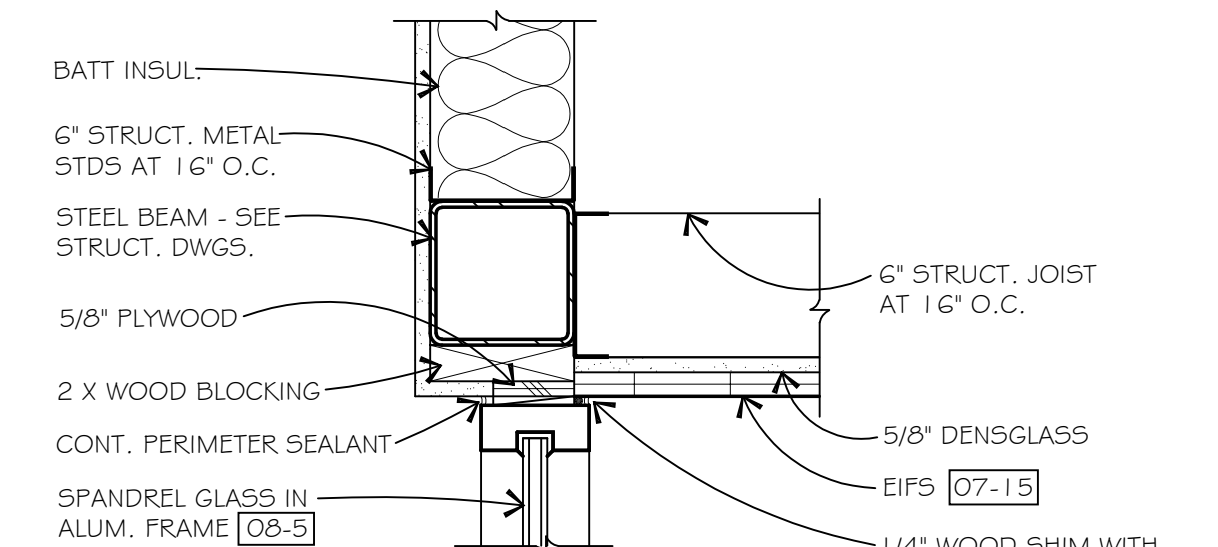
JAMB DETAIL J-4
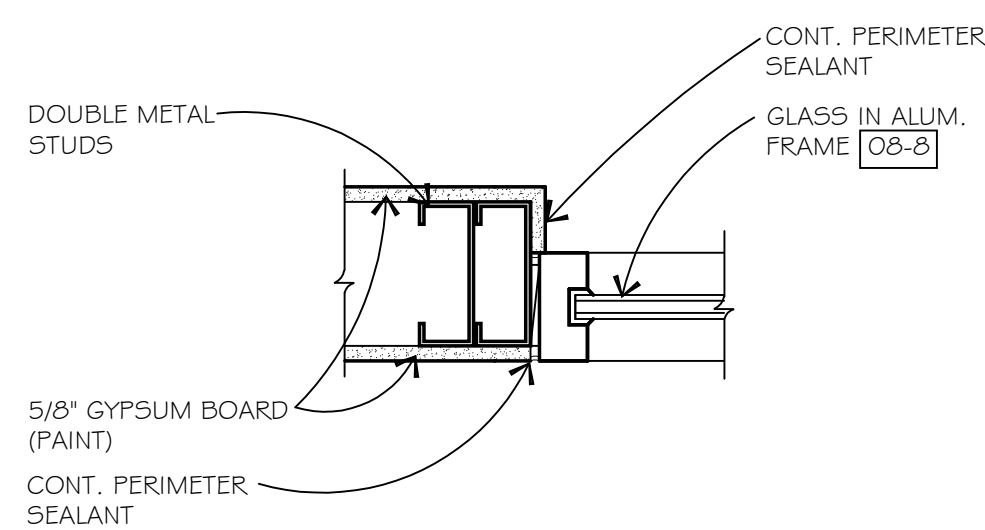
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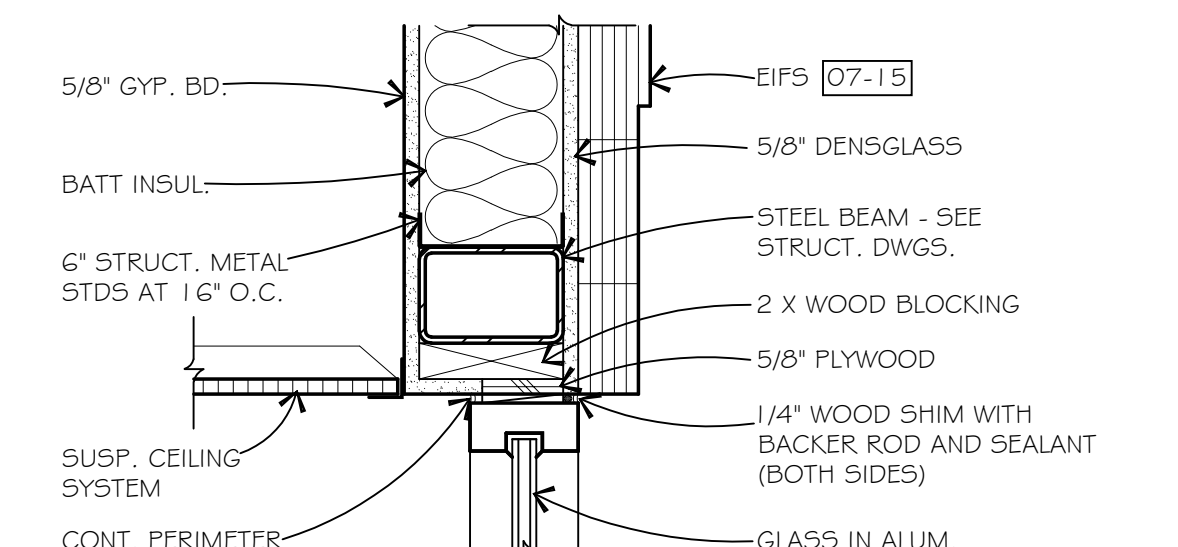
JAMB DETAIL J-3

SCALE: 1-1/2" = 1'-0"

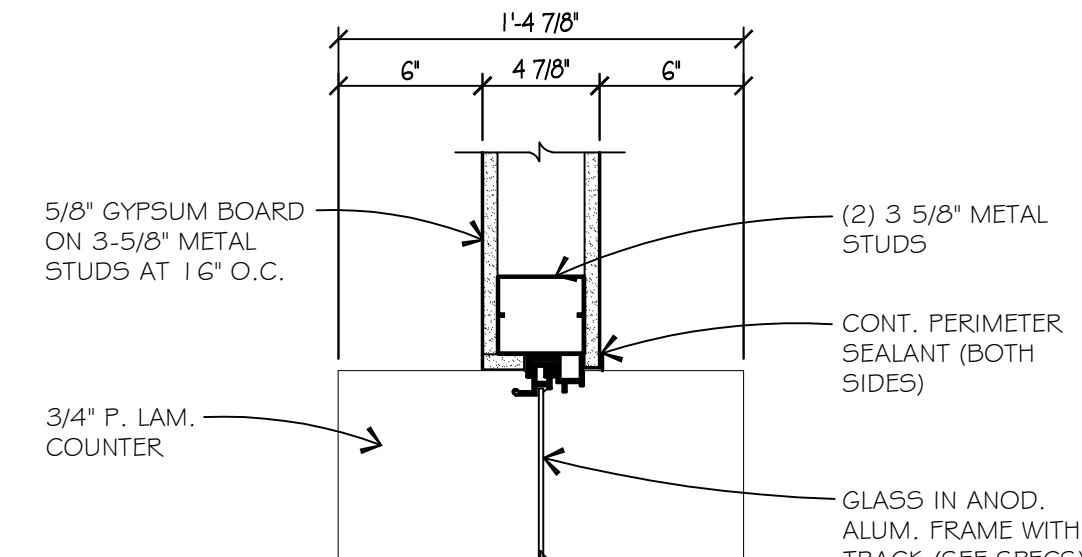


HEAD DETAIL H-2

SCALE: 1-1/2" = 1'-0"




HEAD DETAIL H-1

SCALE: 1-1/2" = 1'-0"

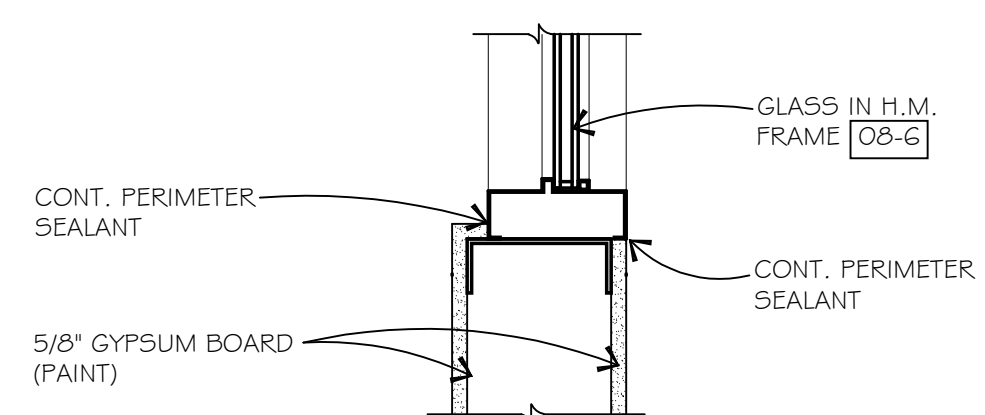


SILL DETAIL S-6

SCALE: 1-1/2" = 1'-0"

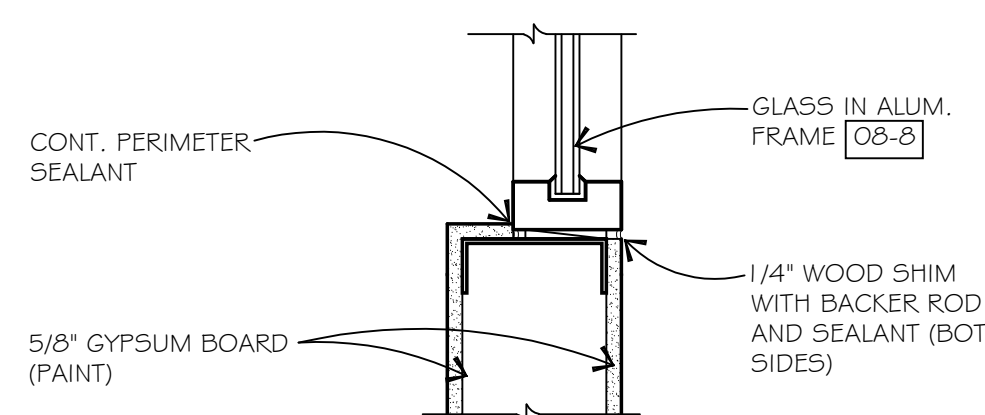


SILL DETAIL S-5

SCALE: 1-1/2" = 1'-0"

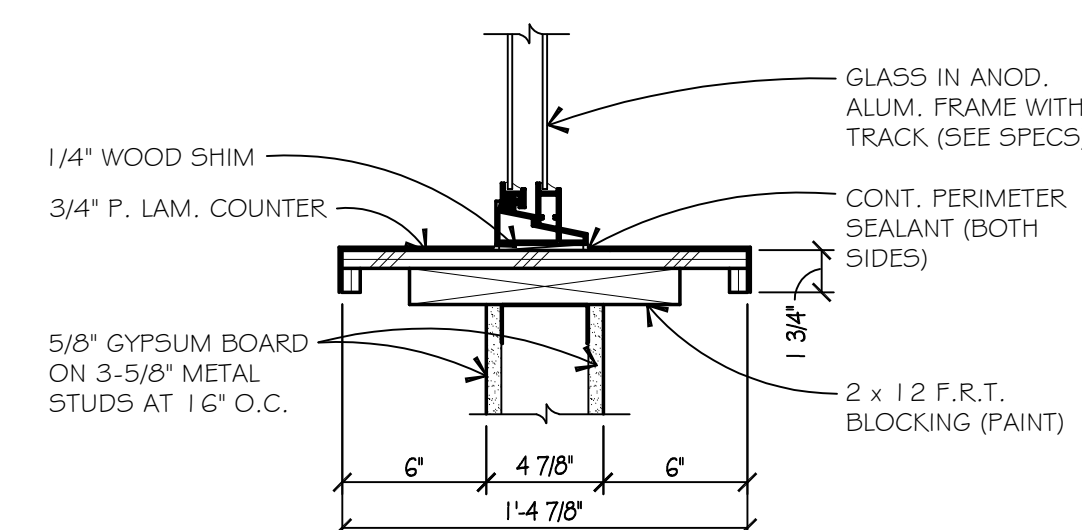


SILL DETAIL S-4

SCALE: 1-1/2" = 1'-0"

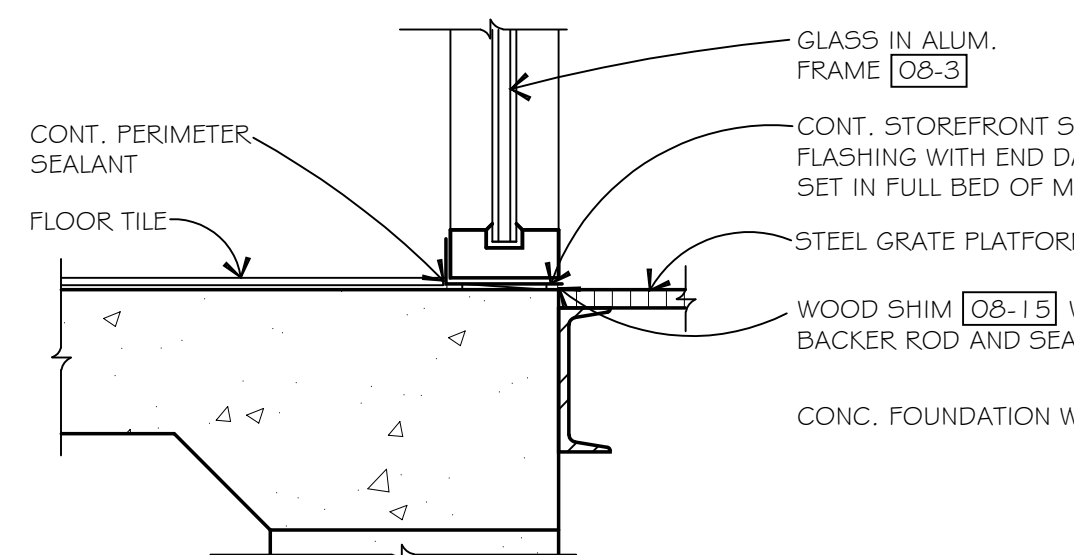


SILL DETAIL S-3

SCALE: 3" = 1'-0"

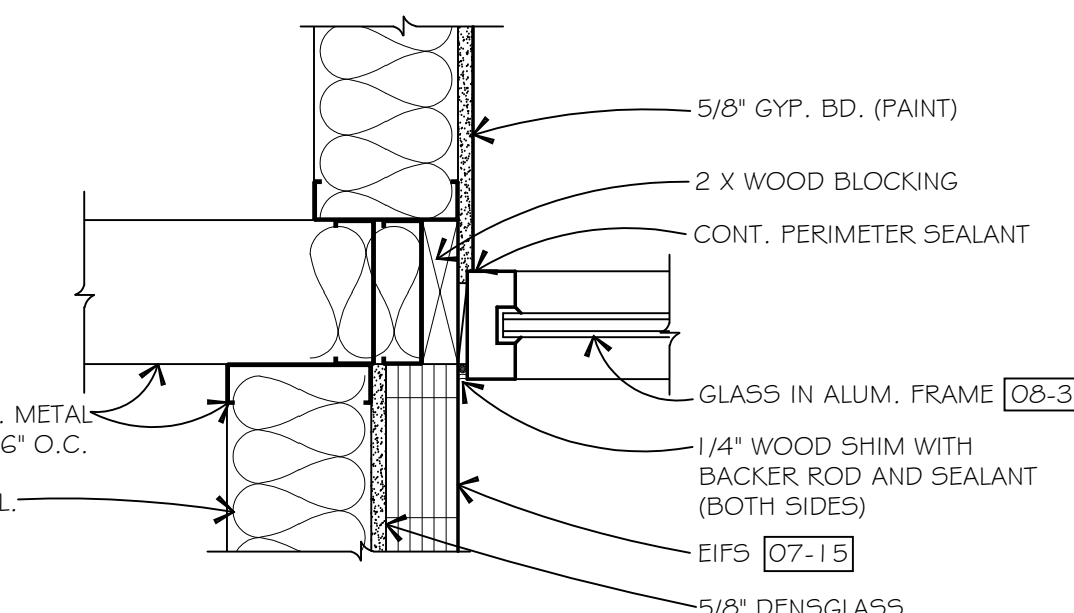


JAMB DETAIL J-2

SCALE: 1-1/2" = 1'-0"

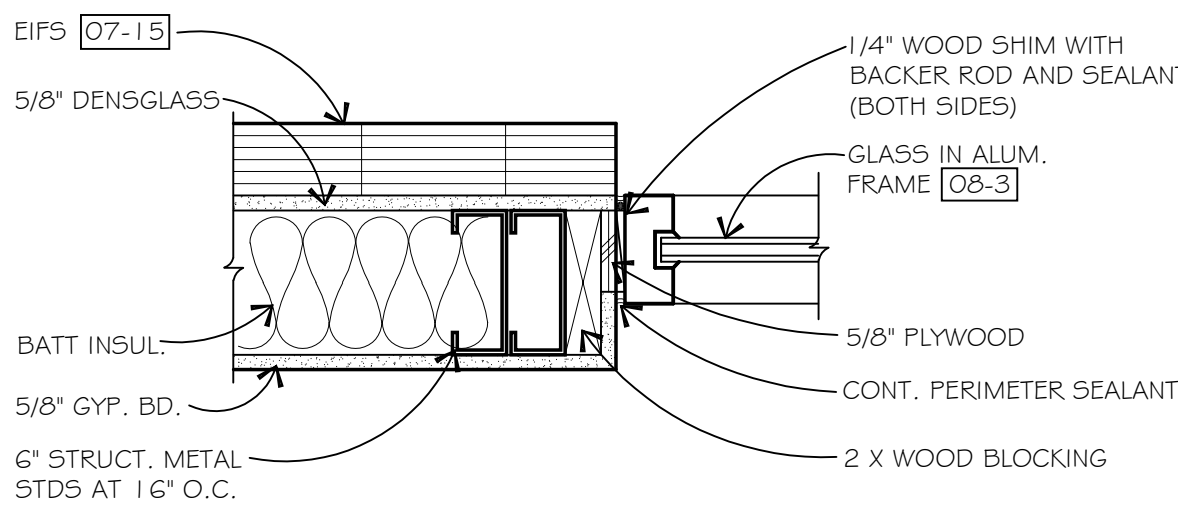


JAMB DETAIL J-1

SCALE: 1-1/2" = 1'-0"

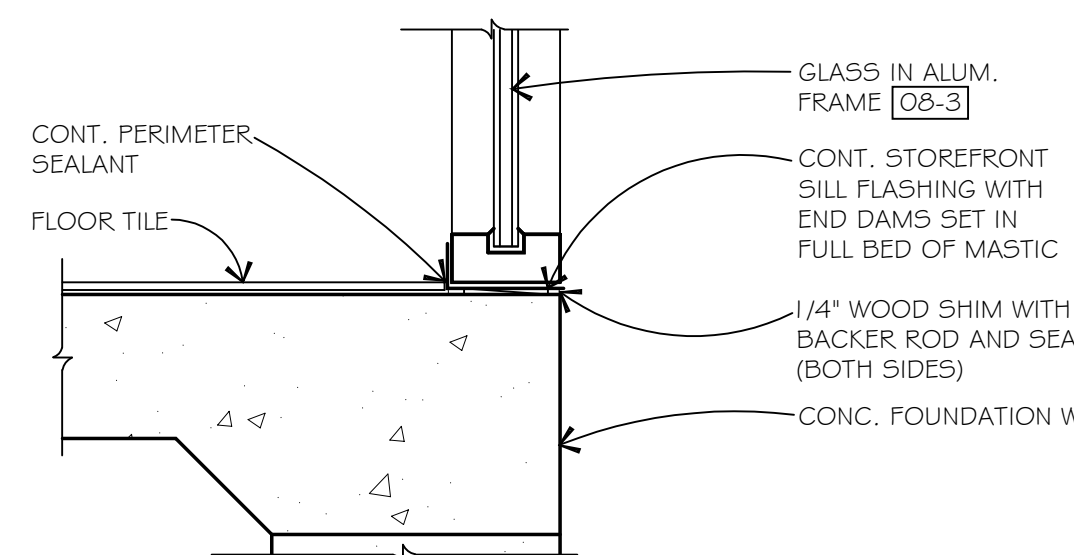

SILL DETAIL S-2

SCALE: 3" = 1'-0"

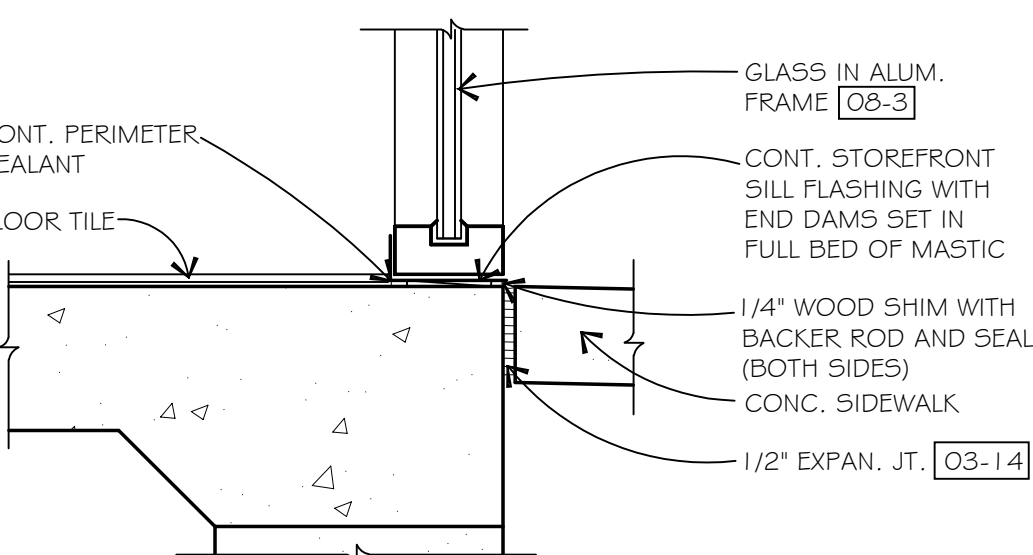


SILL DETAIL S-1

SCALE: 3" = 1'-0"

WINDOW DETAILS

Woh Yee Associates  
Architects & Planners  
1400 GRANDVIEW AVENUE, SUITE 200  
EDMONTON, ALBERTA T6G 1K7  
PHONE 248 489 9160

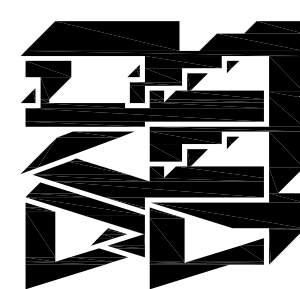

PROJECT  
**R + L CARRIERS**  
EDMONTON, ALBERTA

Date Issued

Bids & Permit Oct. 8, 2021

Job Number

5147

SHEET TITLE


WINDOW

DETAILS


Sheet Number

A8.3


Do not scale drawings - Use figured dimensions CAD DWG S147A8.DWG

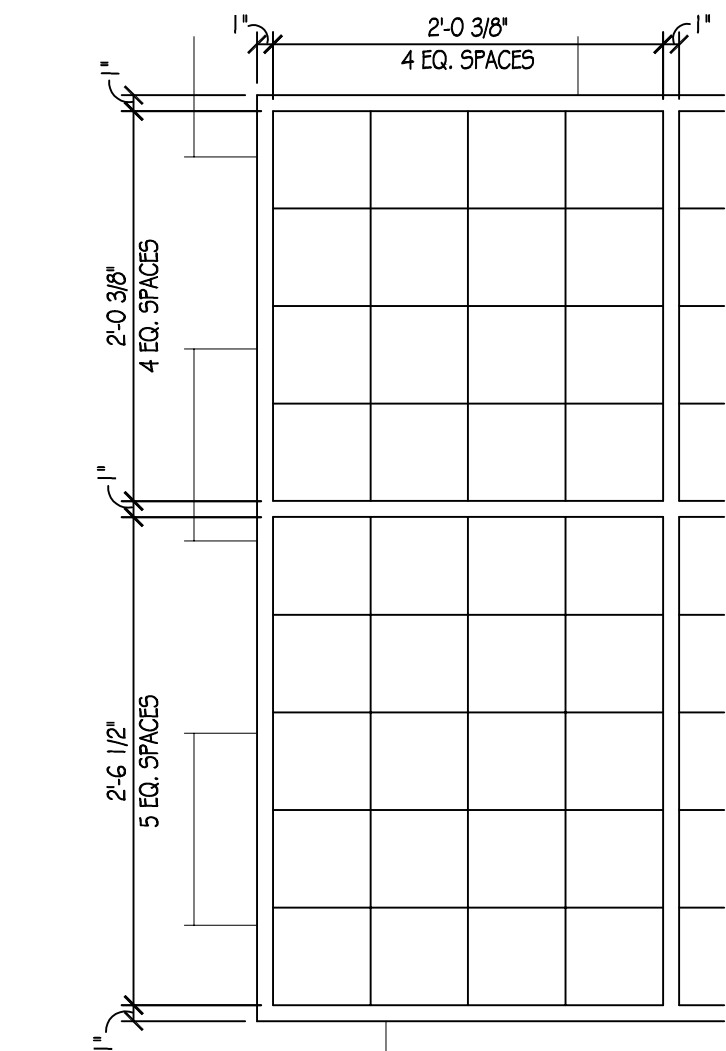


ENLARGED MAIL SLOT DETAIL  
SCALE: 1" = 1'-0"

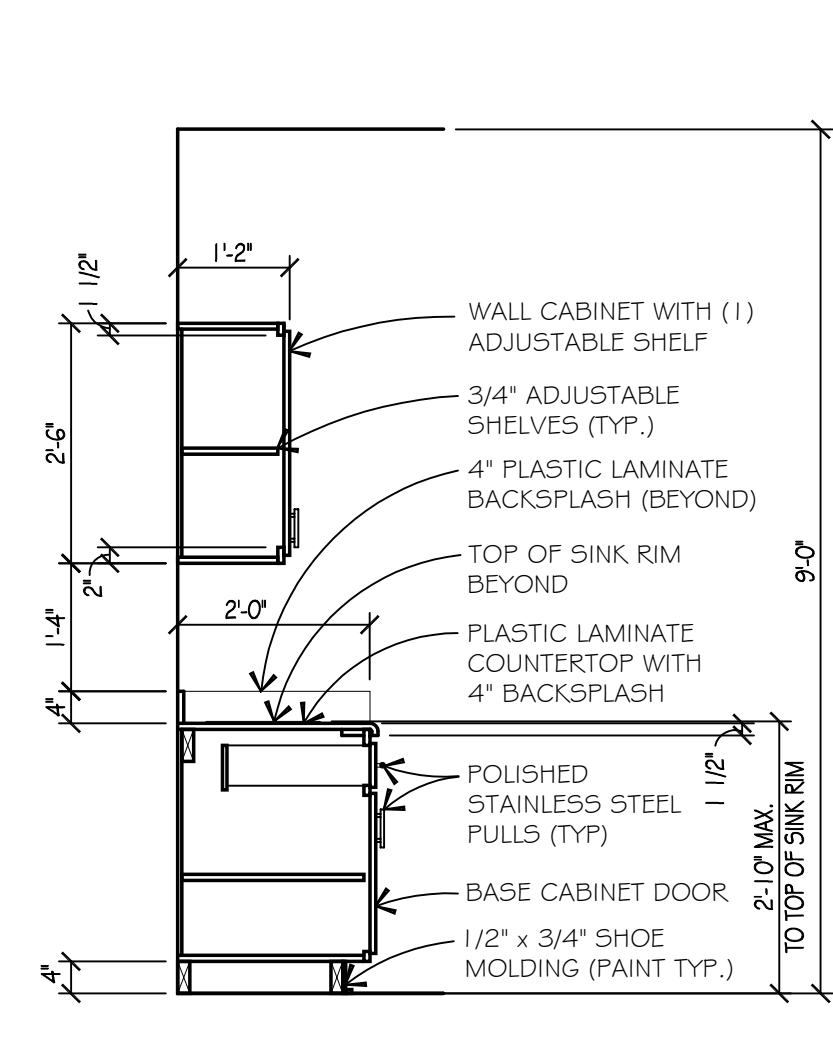


CABINET SECTION  
SCALE: 1/2" = 1'-0"

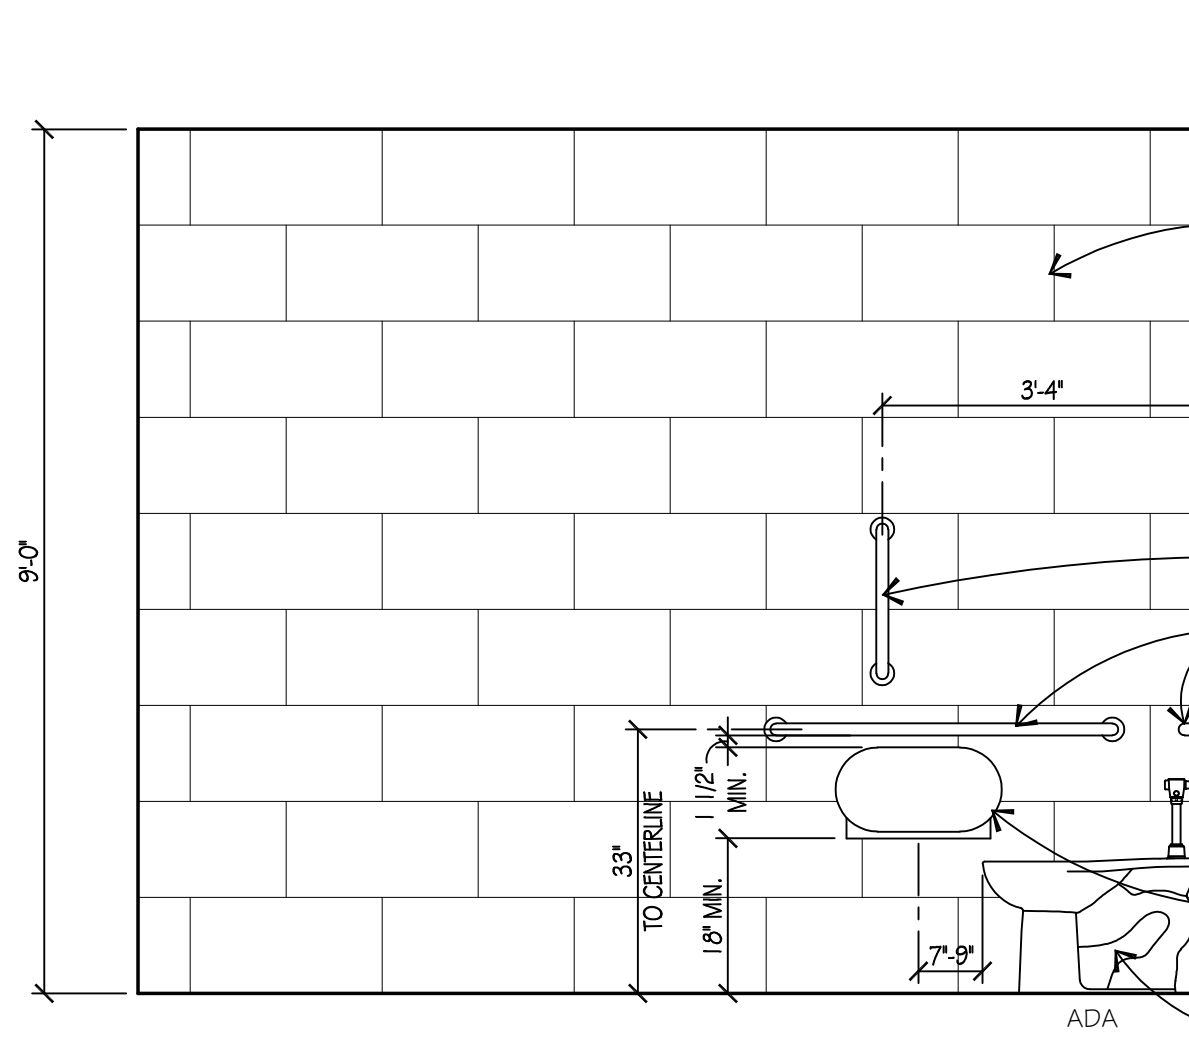


MENS TOILET ROOM ELEVATION  
SCALE: 1/2" = 1'-0"

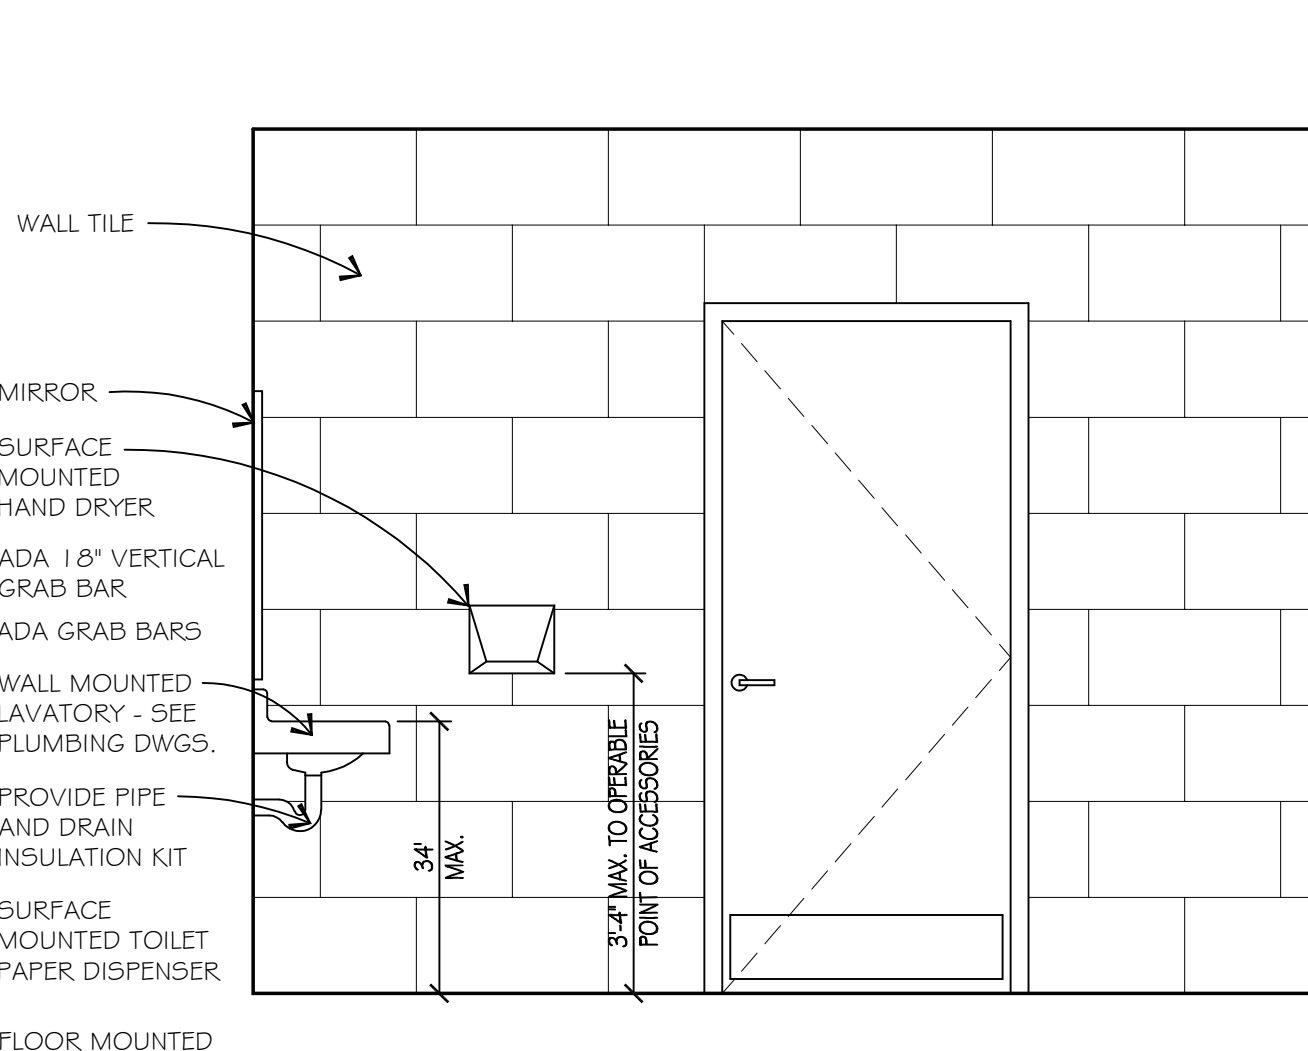


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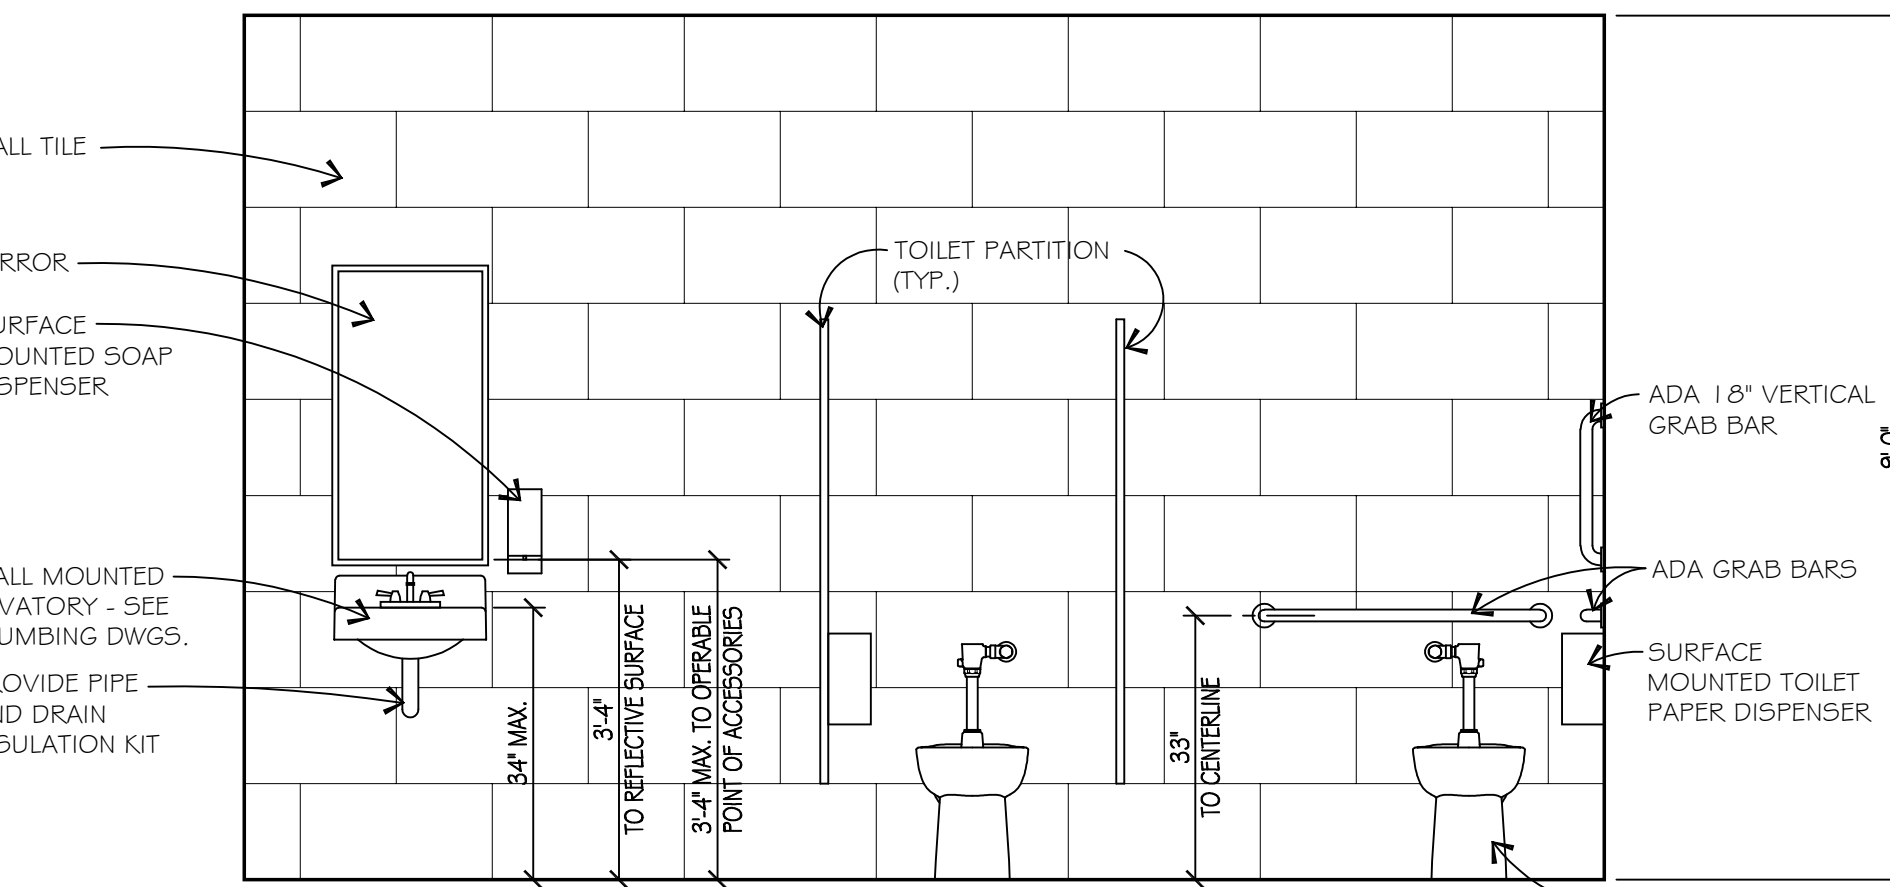
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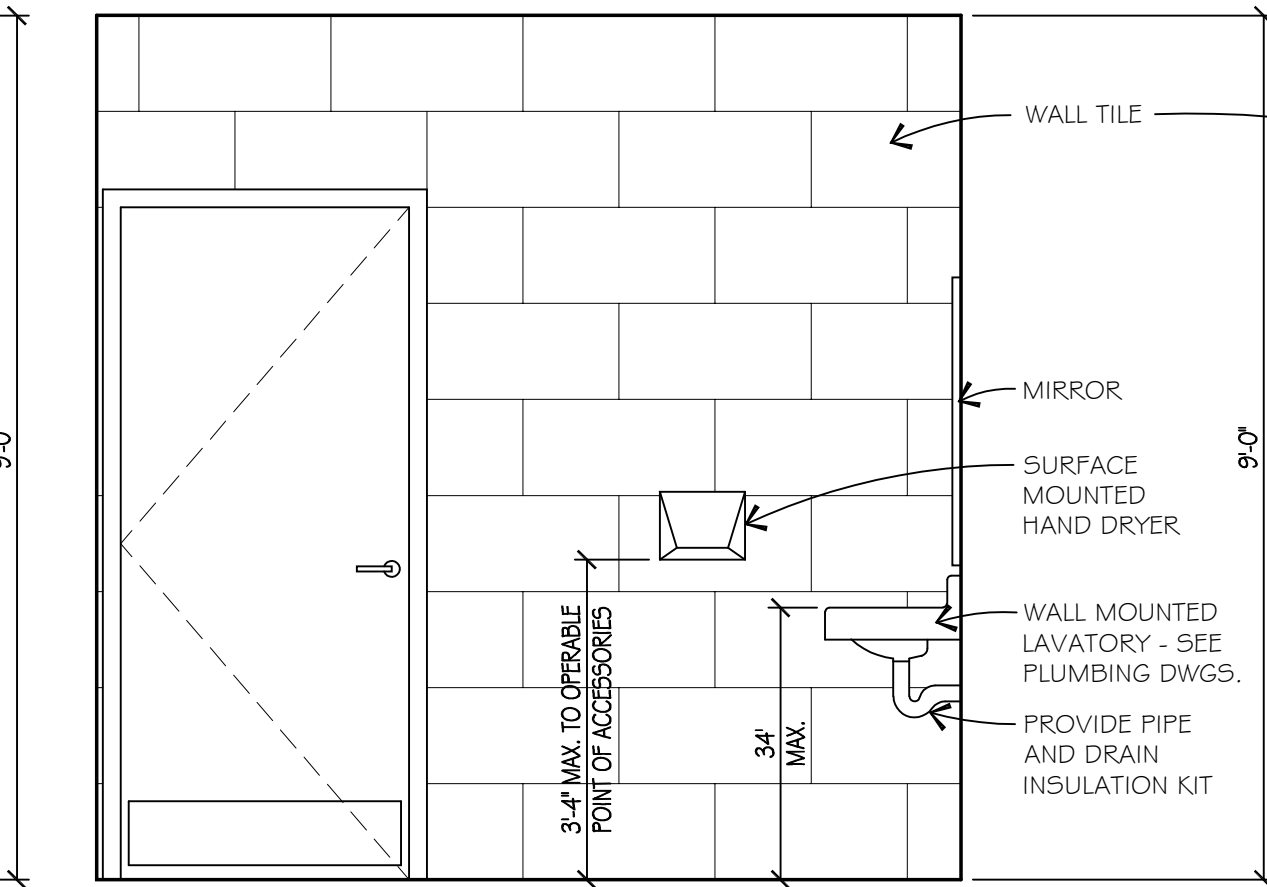
SHOWER ELEVATION  
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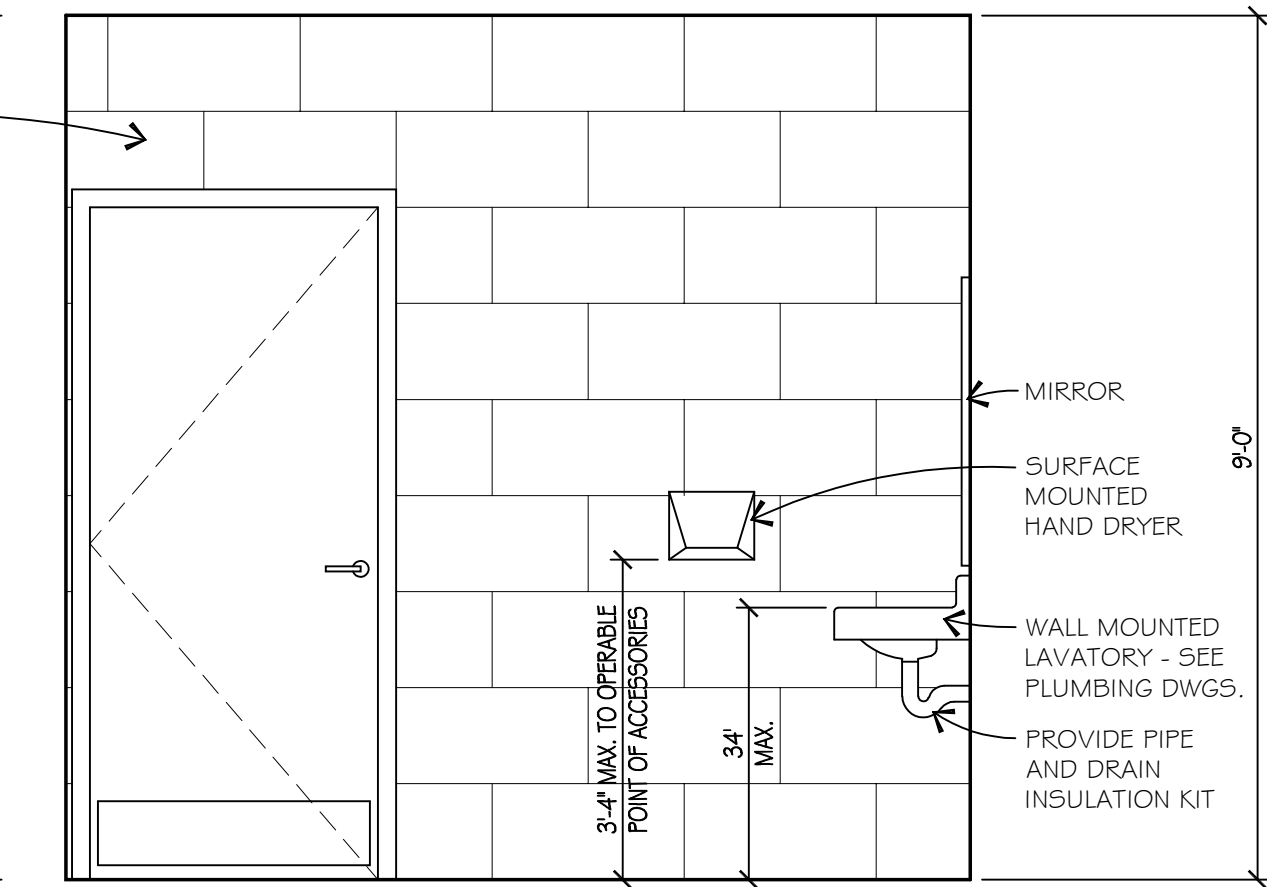
WOMENS TOILET ROOM ELEVATION  
SCALE: 1/2" = 1'-0"

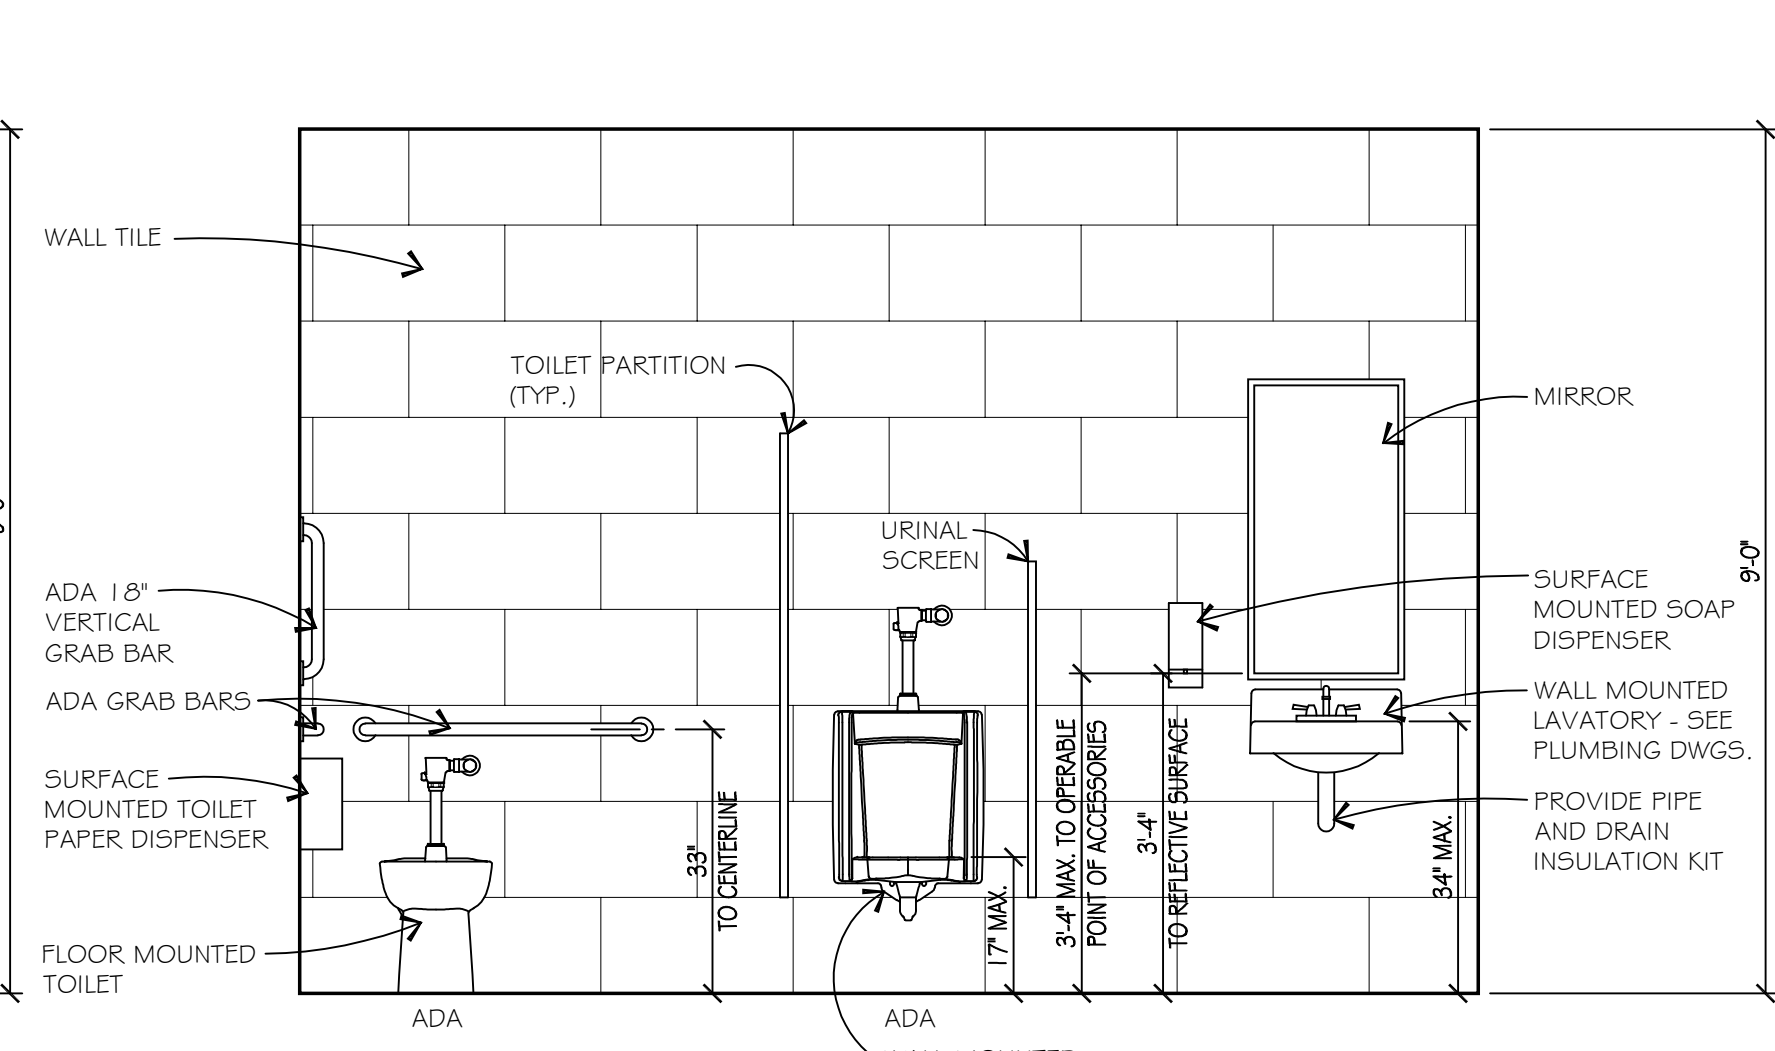


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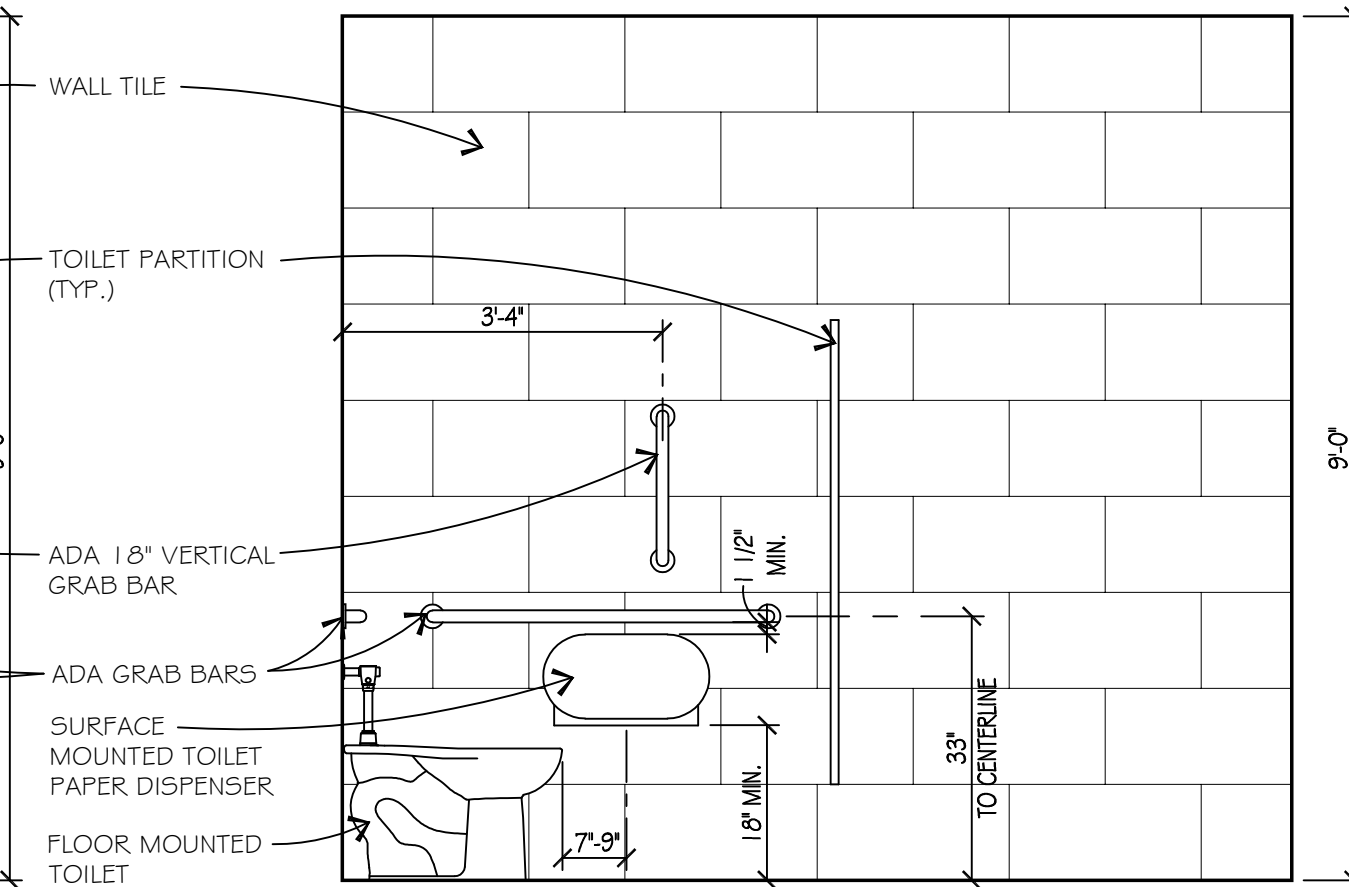
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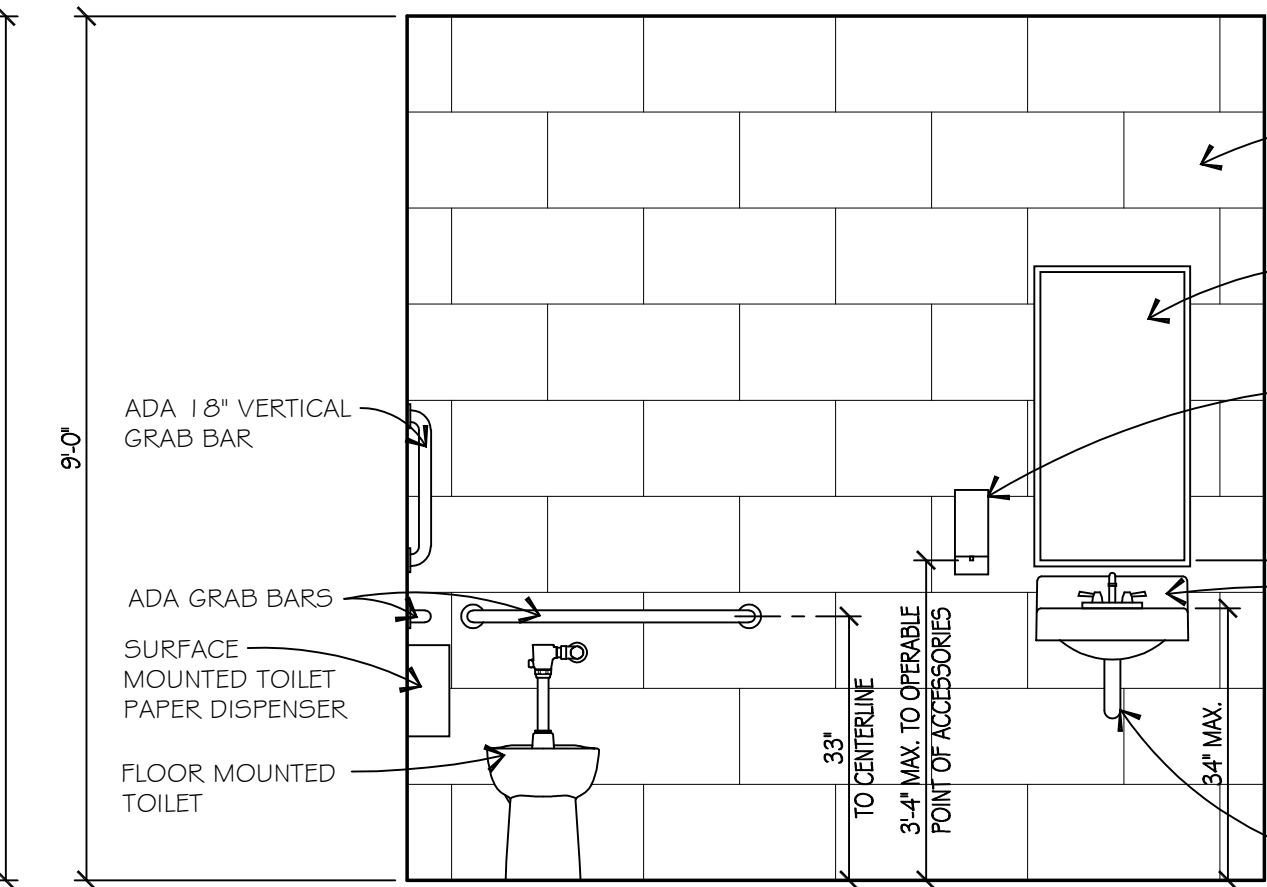
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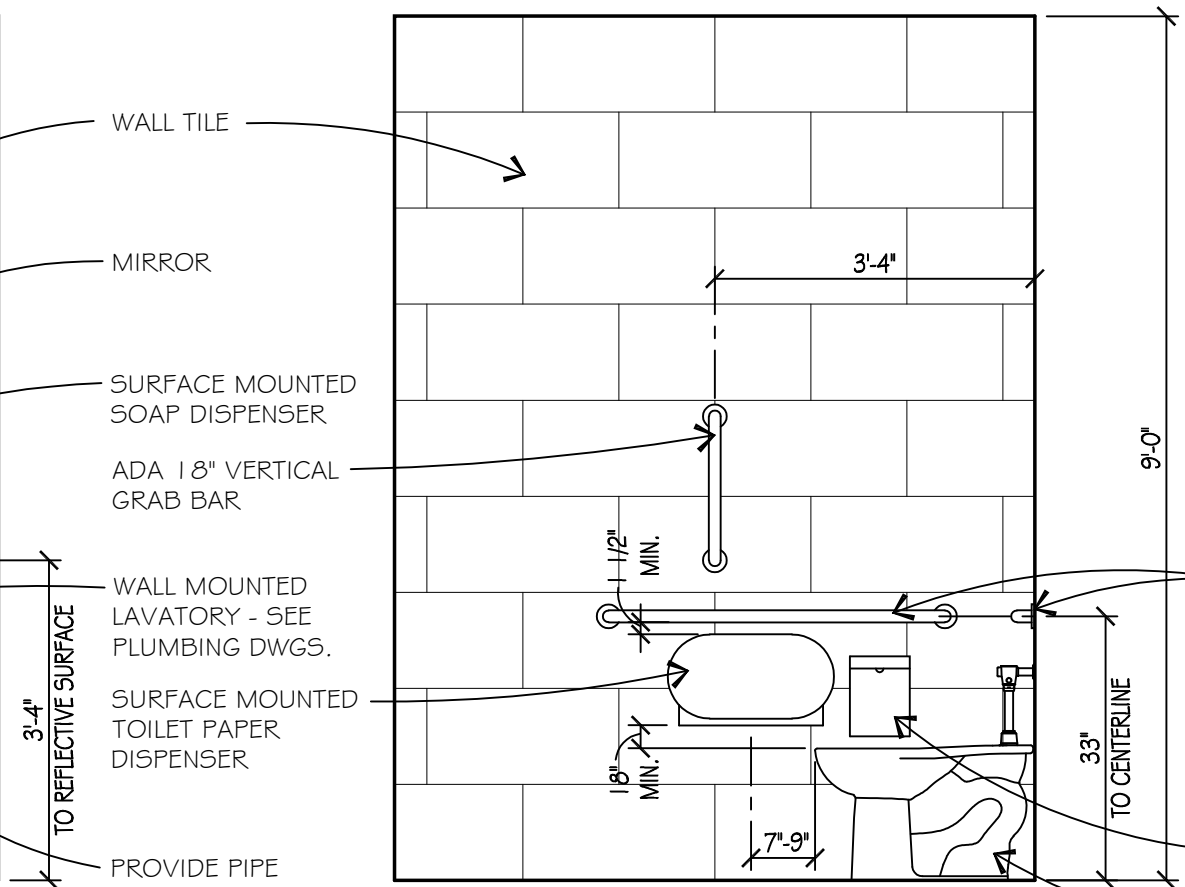
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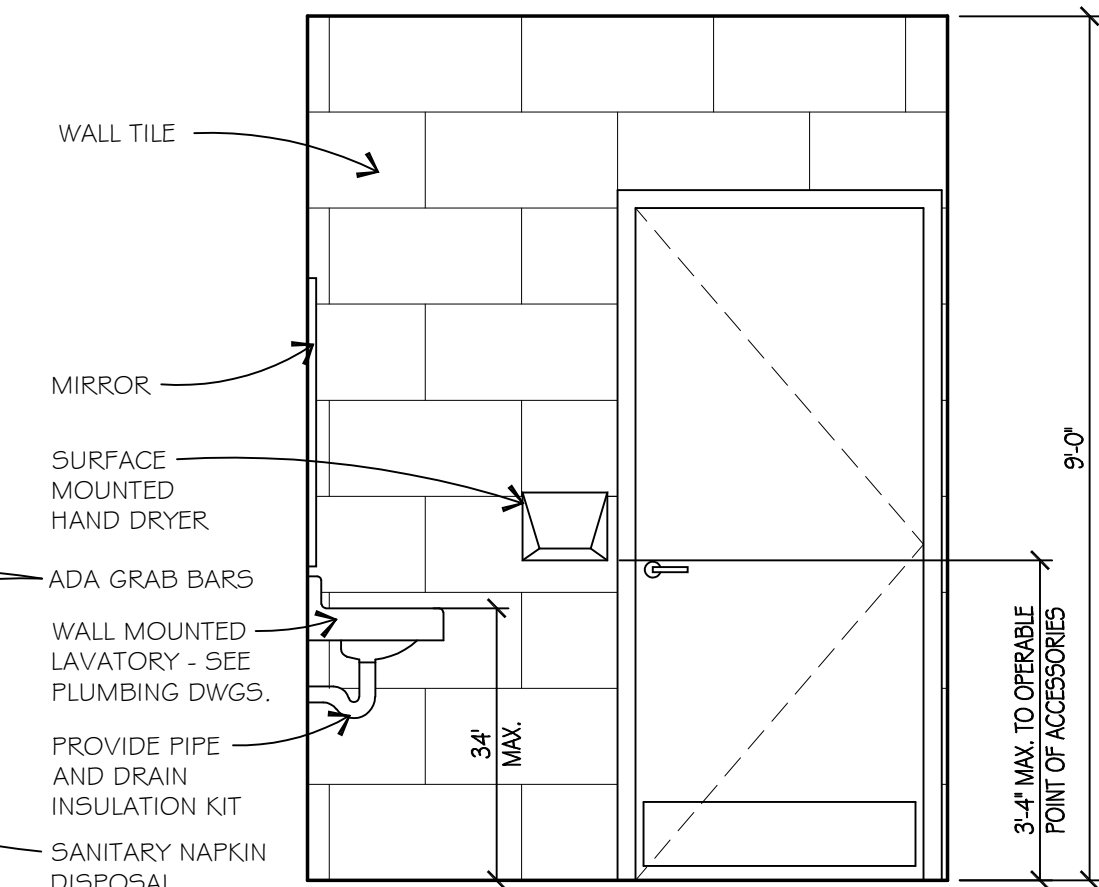
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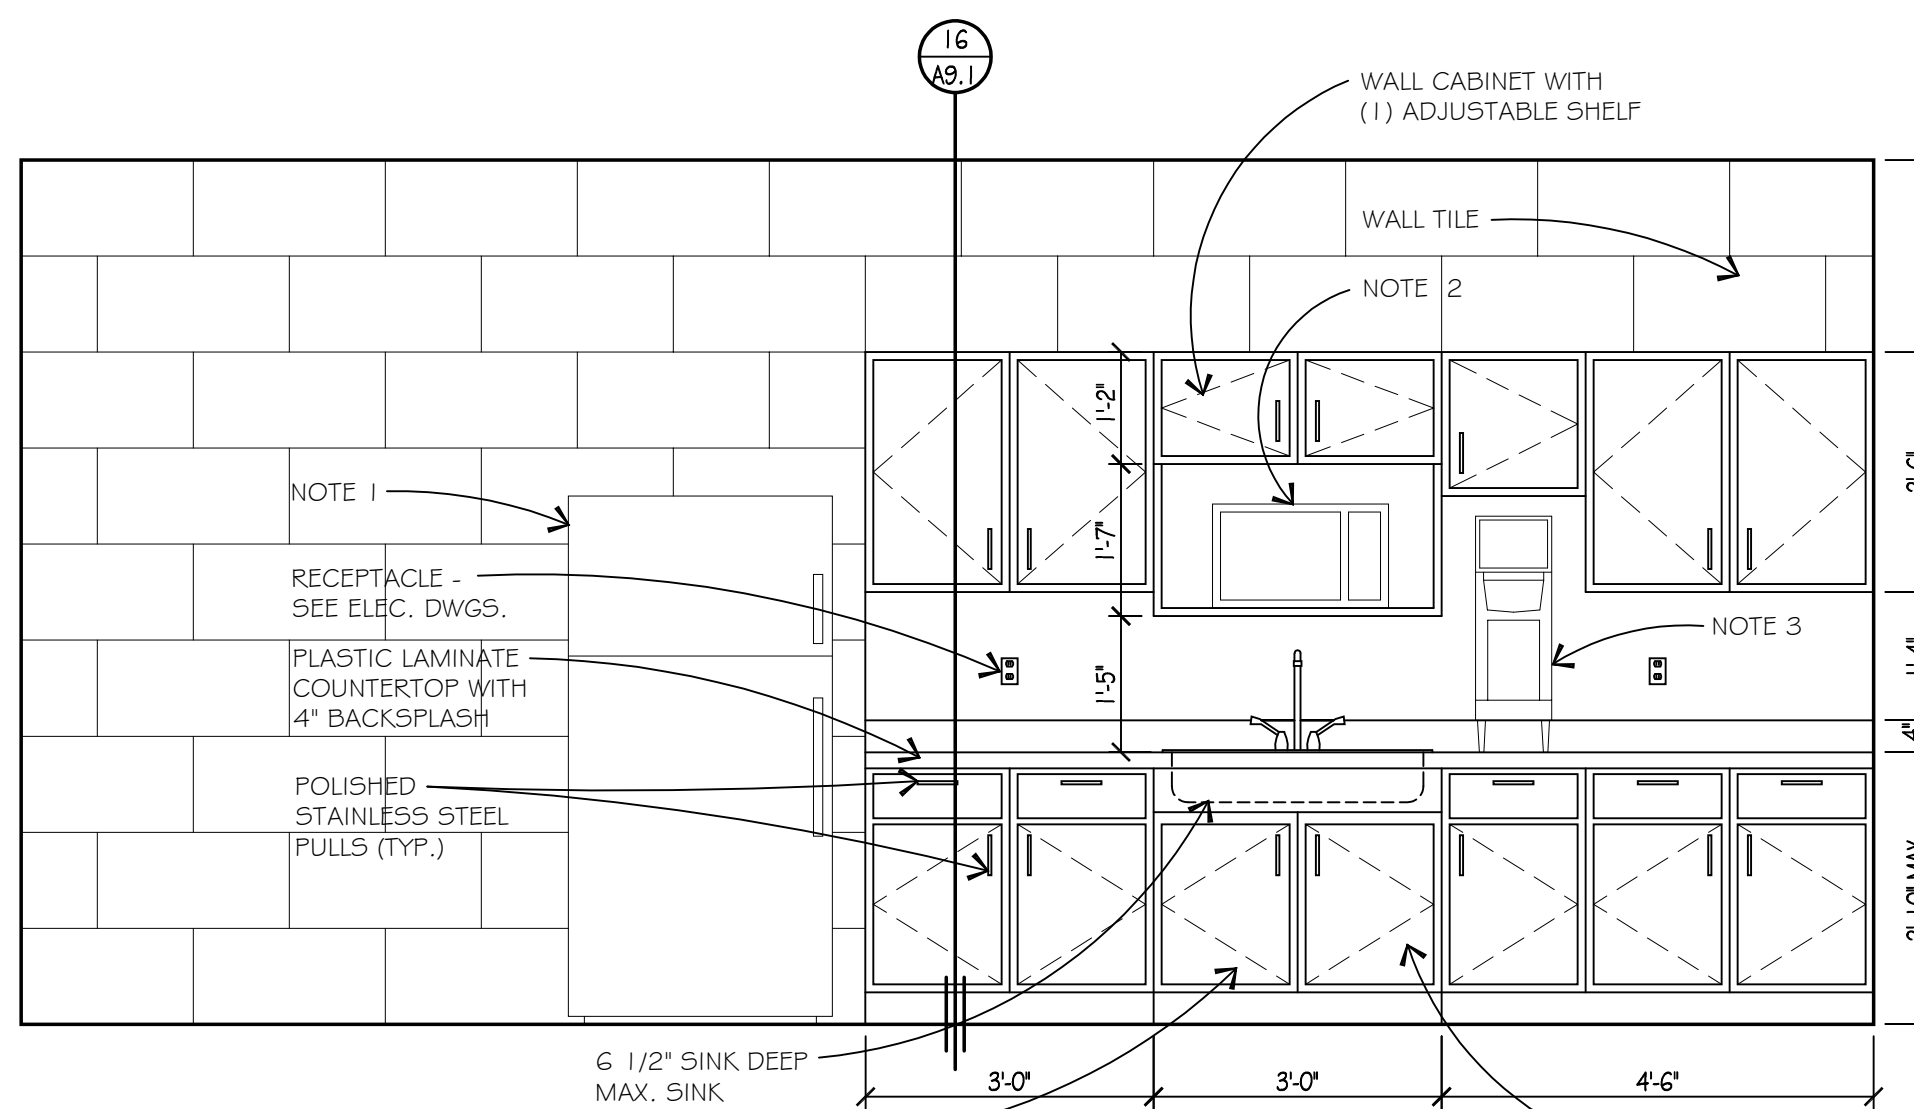
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SCALE: 1/2" = 1'-0"

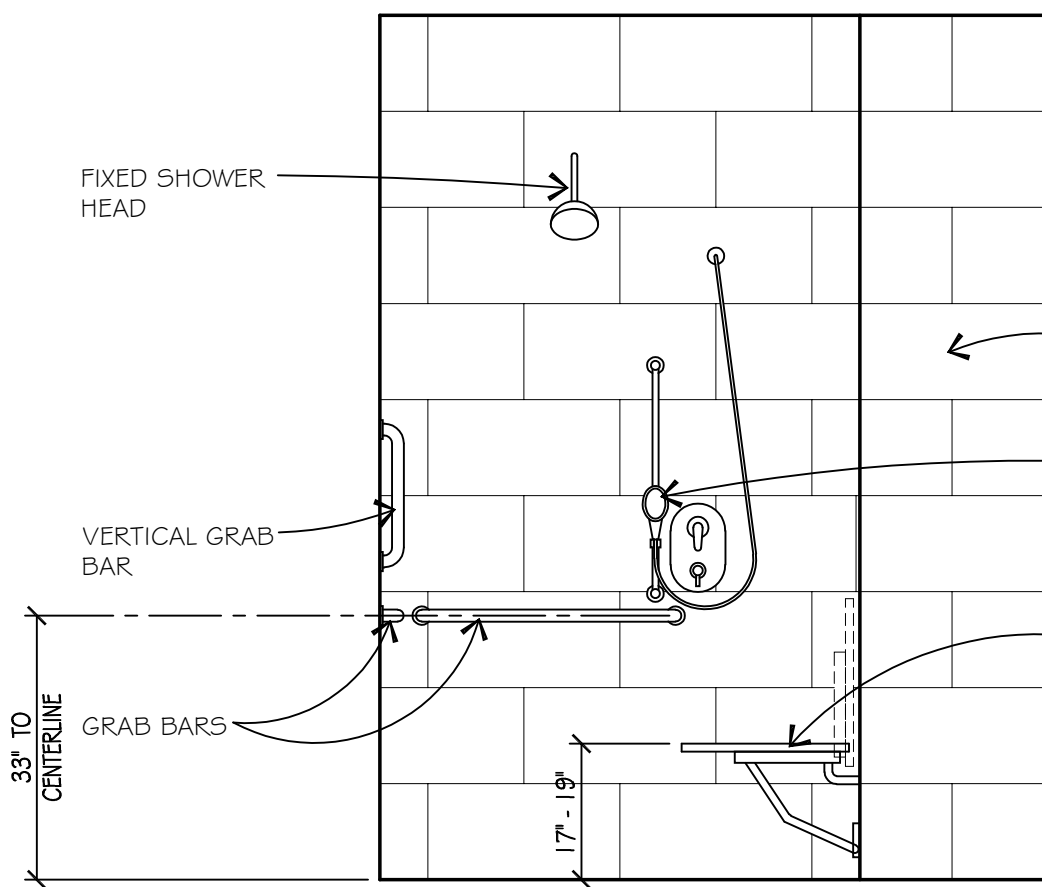


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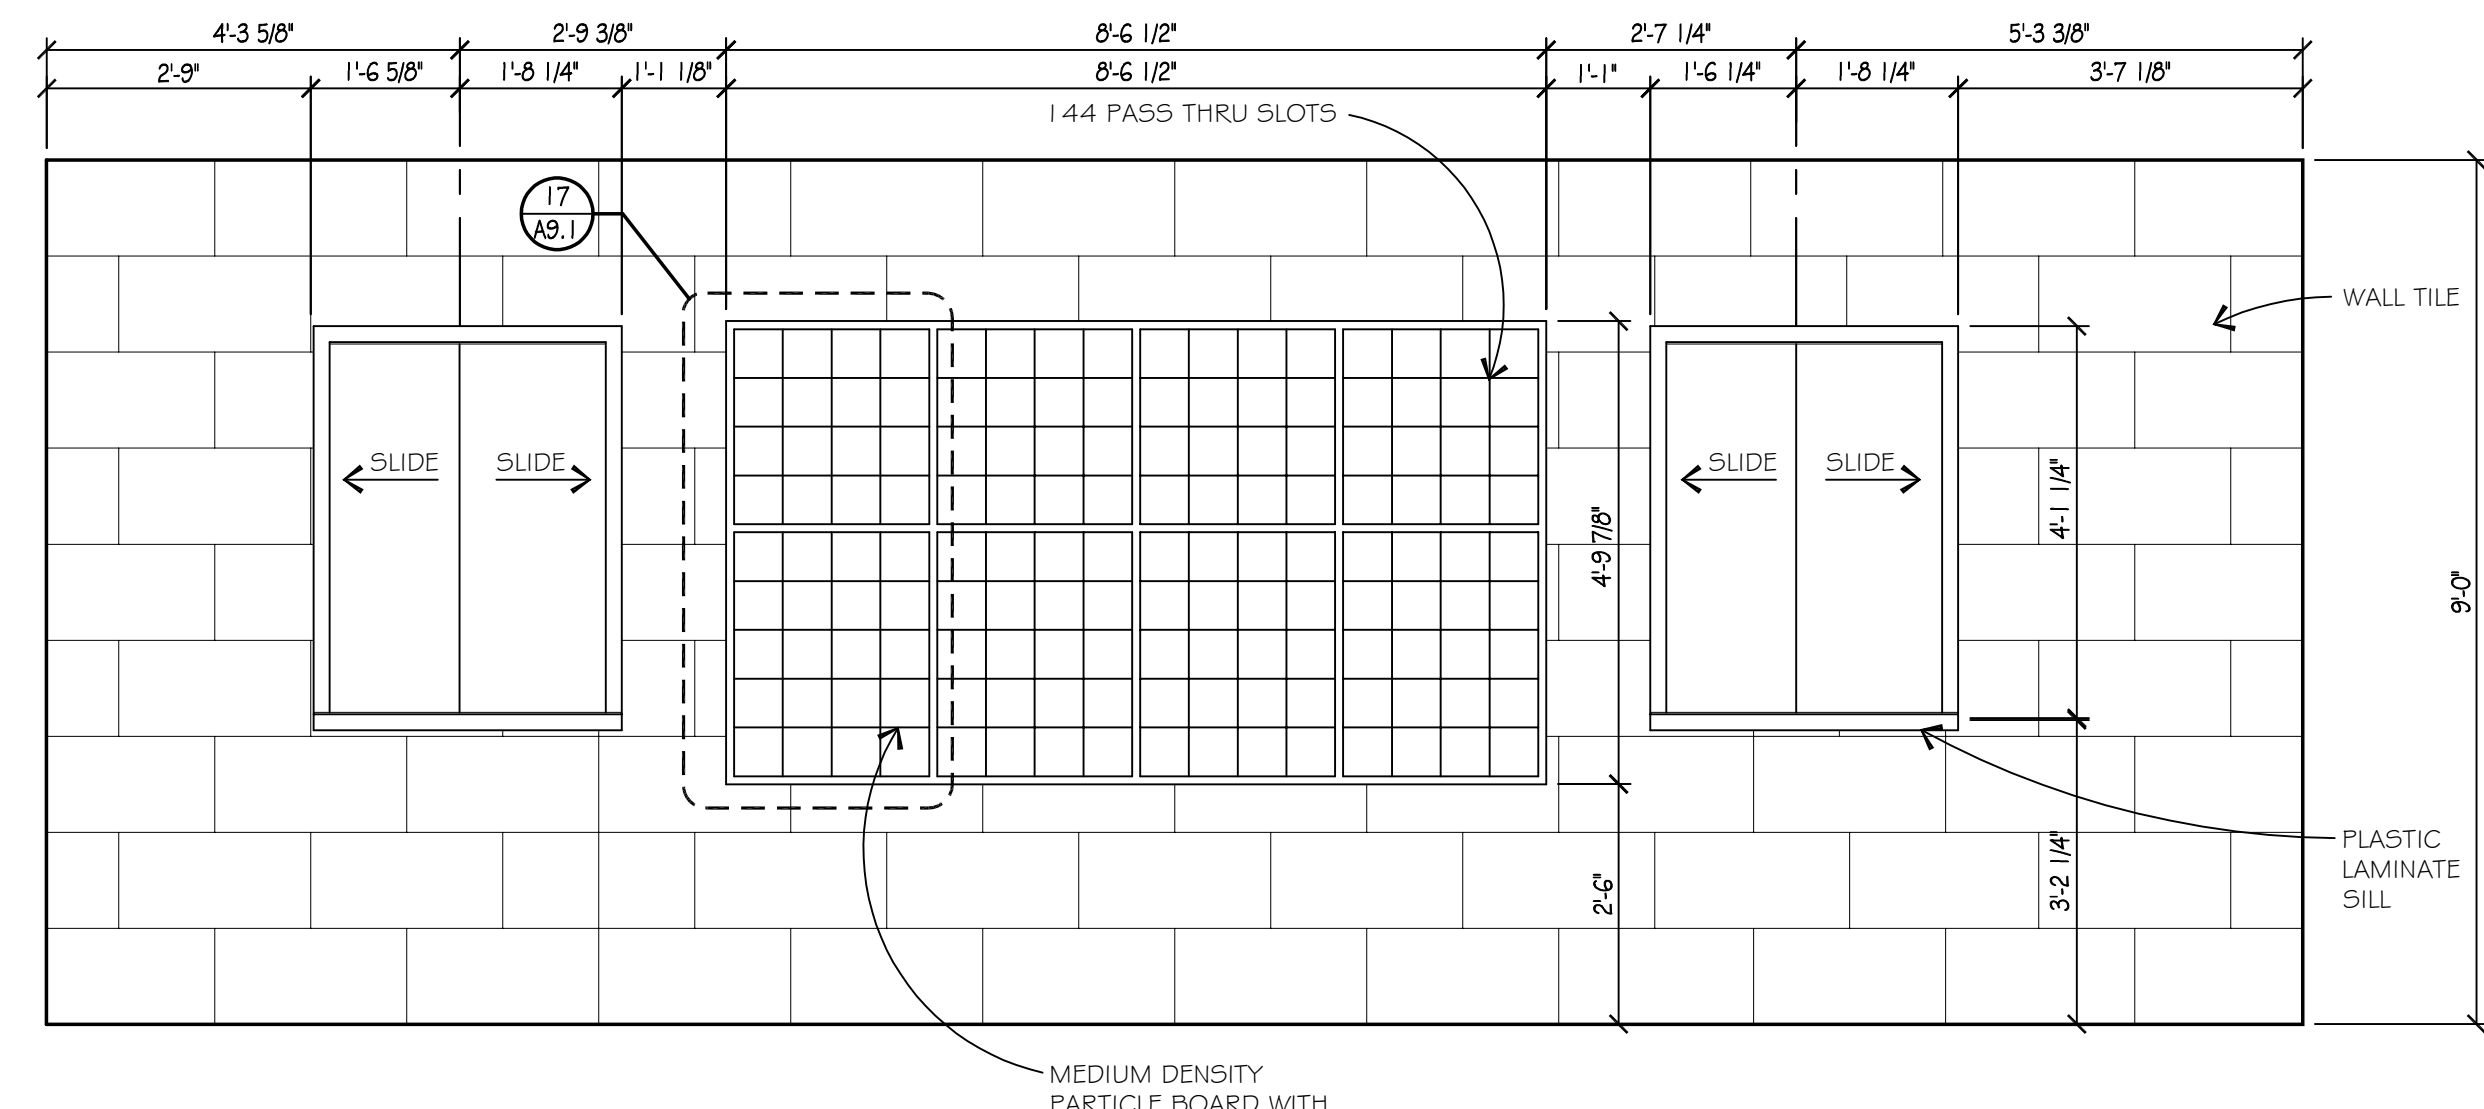
WOMENS TOILET ROOM ELEVATION  
SCALE: 1/2" = 1'-0"

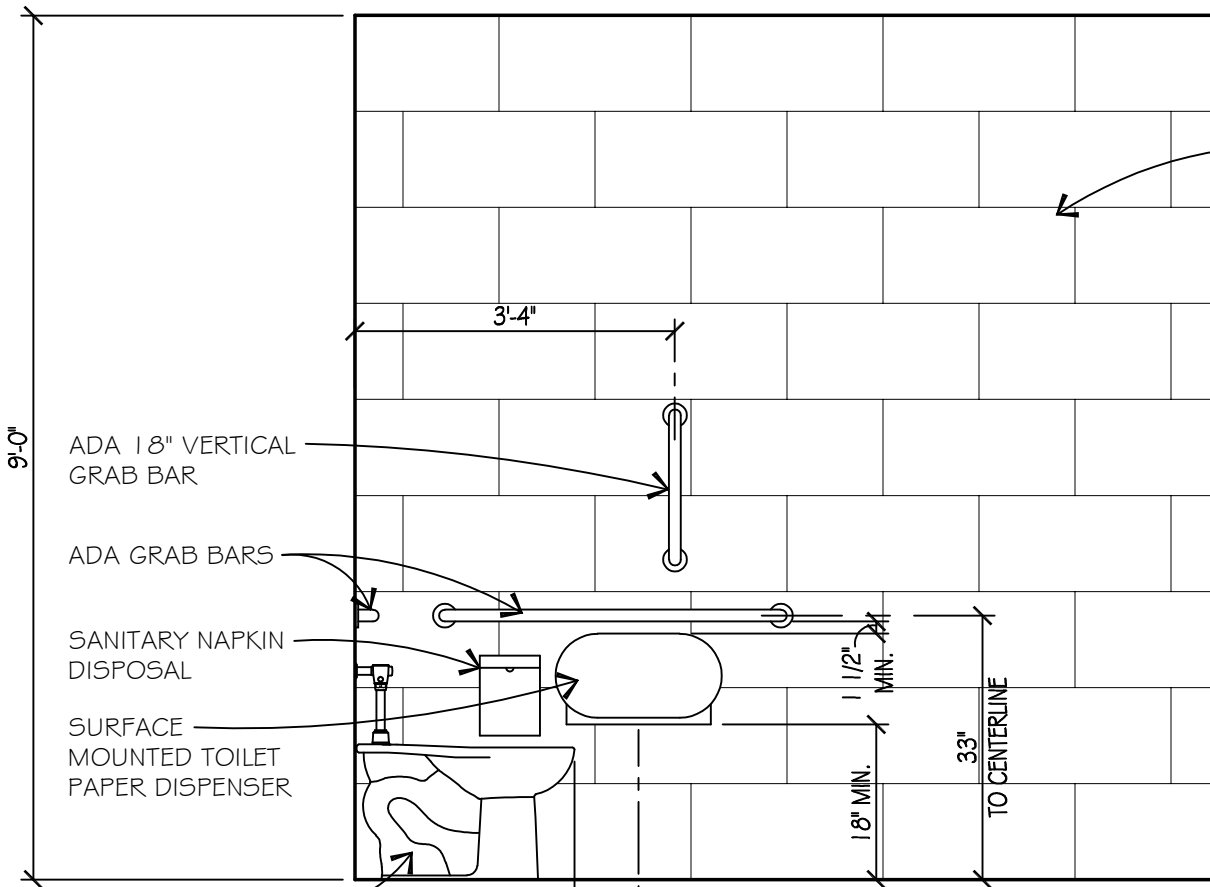

BREAK ROOM ELEVATION  
SCALE: 1/2" = 1'-0"

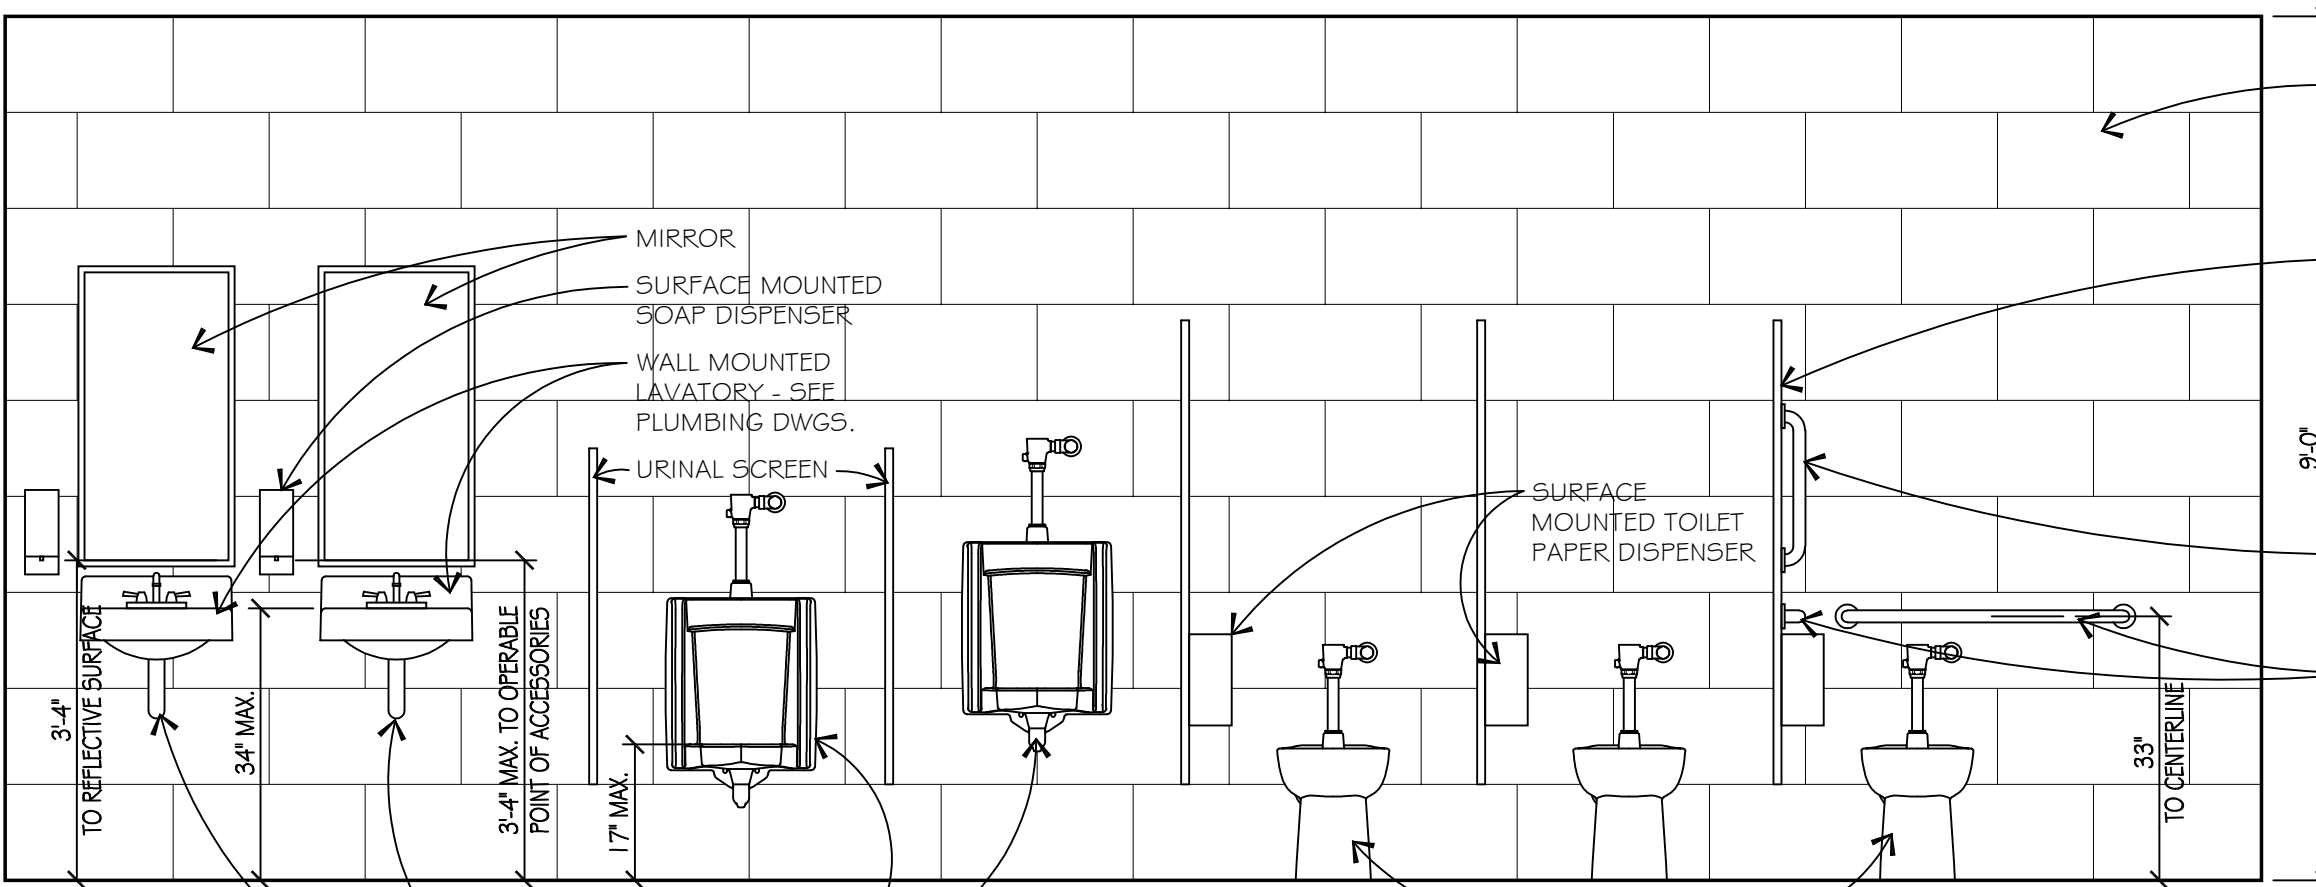


DRIVER ROOM ELEVATION  
SCALE: 1/2" = 1'-0"

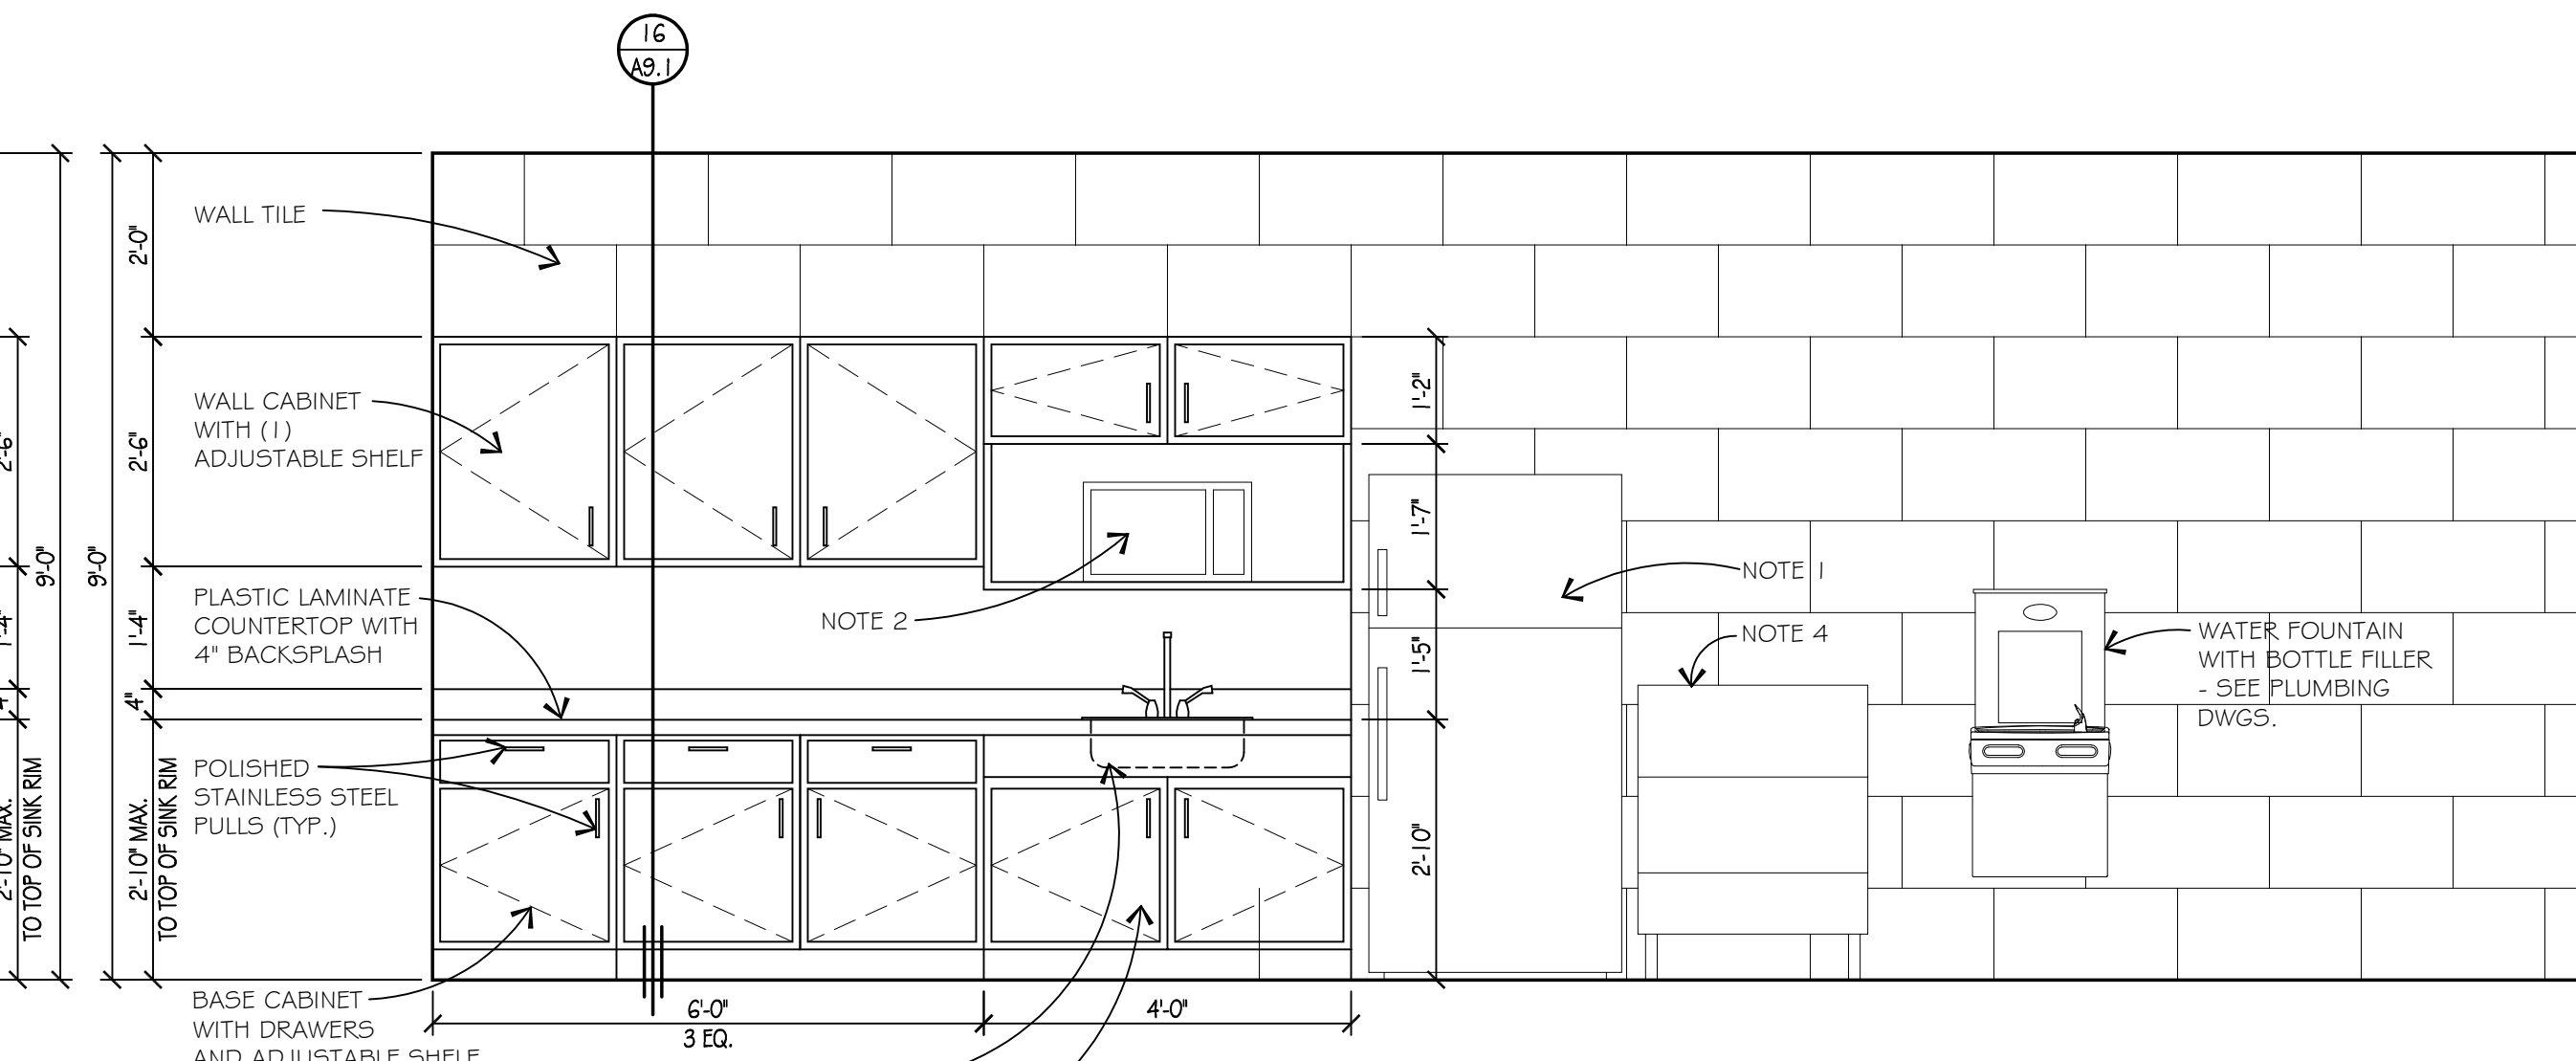


DRIVER ROOM ELEVATION  
SCALE: 1/2" = 1'-0"




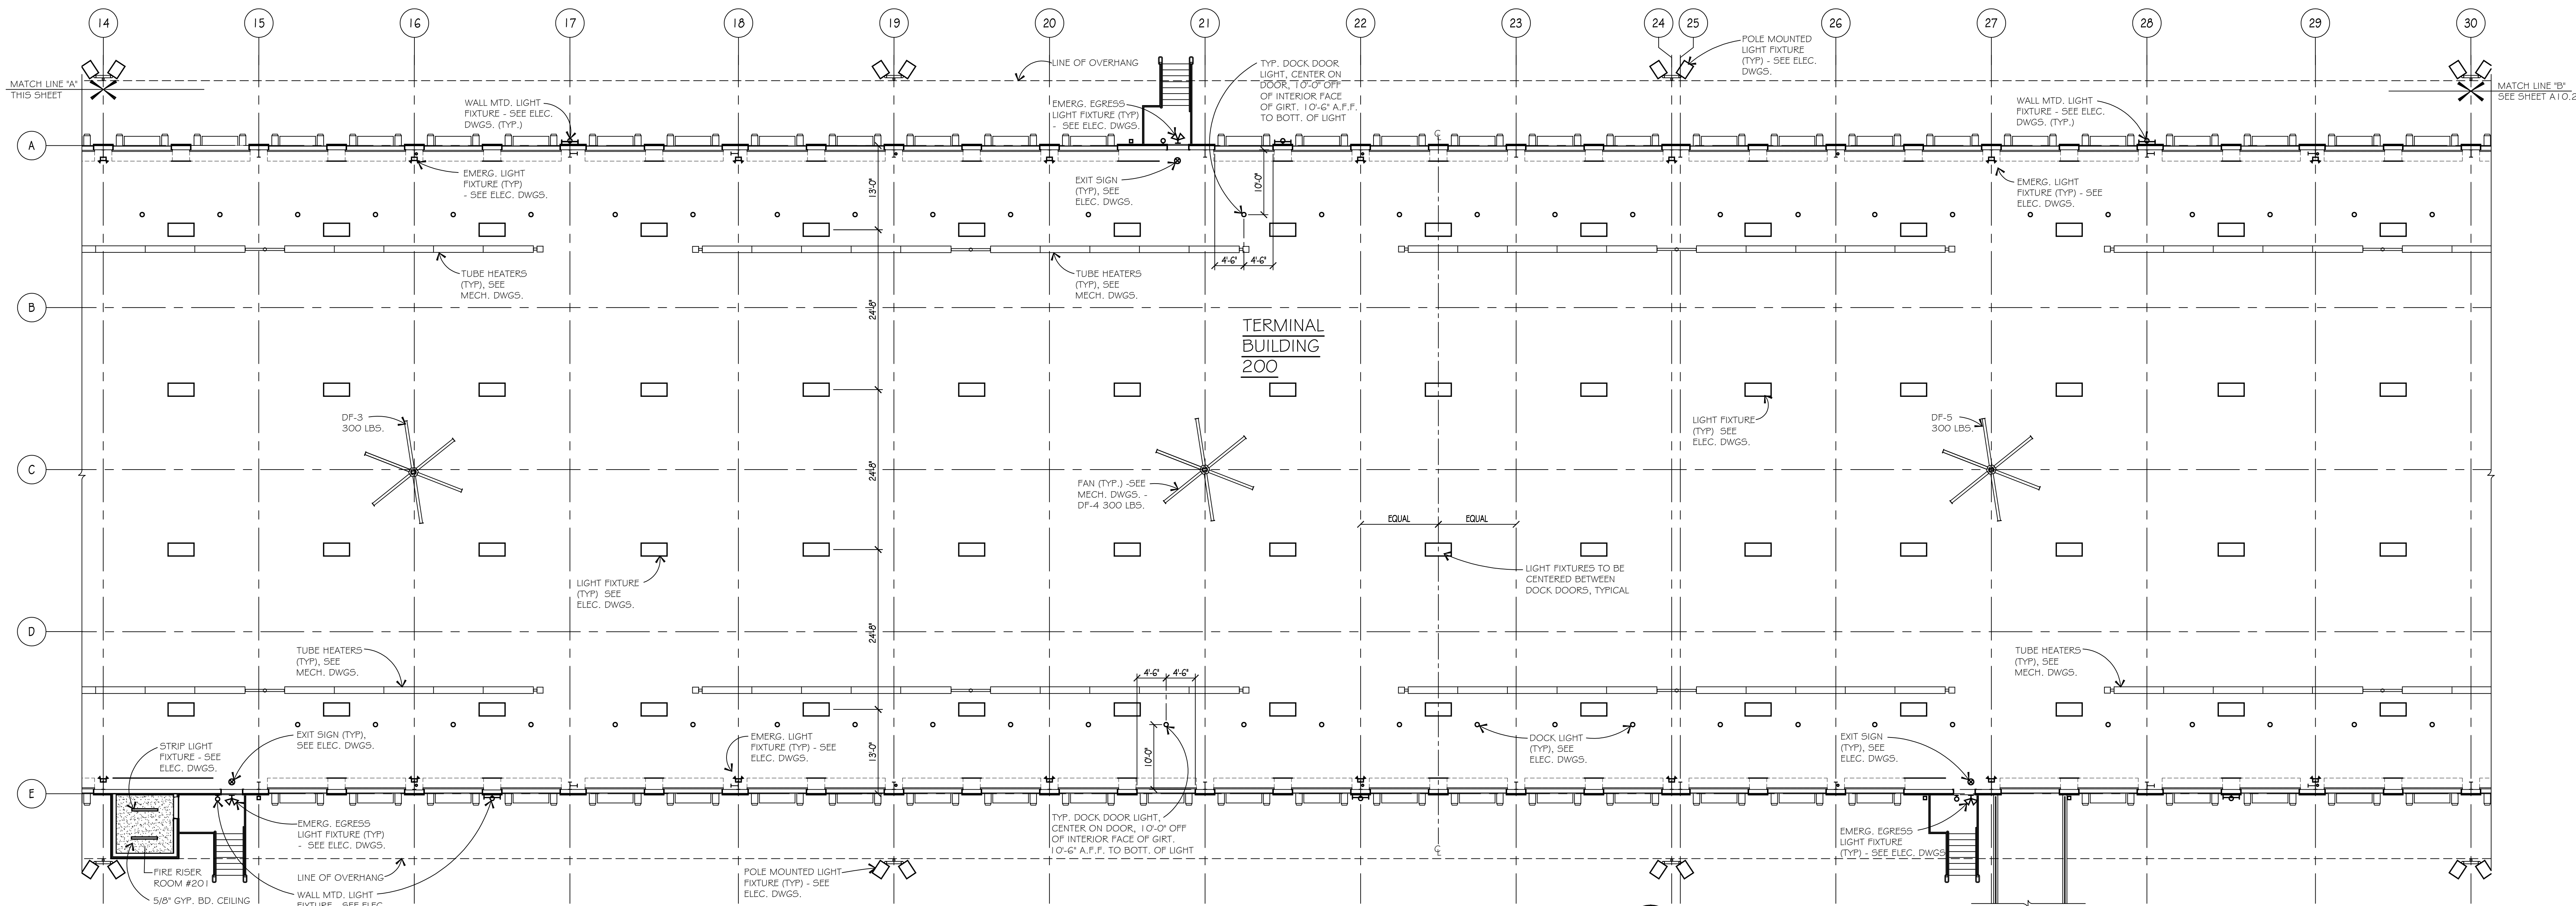


TERMINAL BUILDING #200 PARTIAL REFLECTED CEILING PLAN  
SCALE: 3/32" = 1'-0"

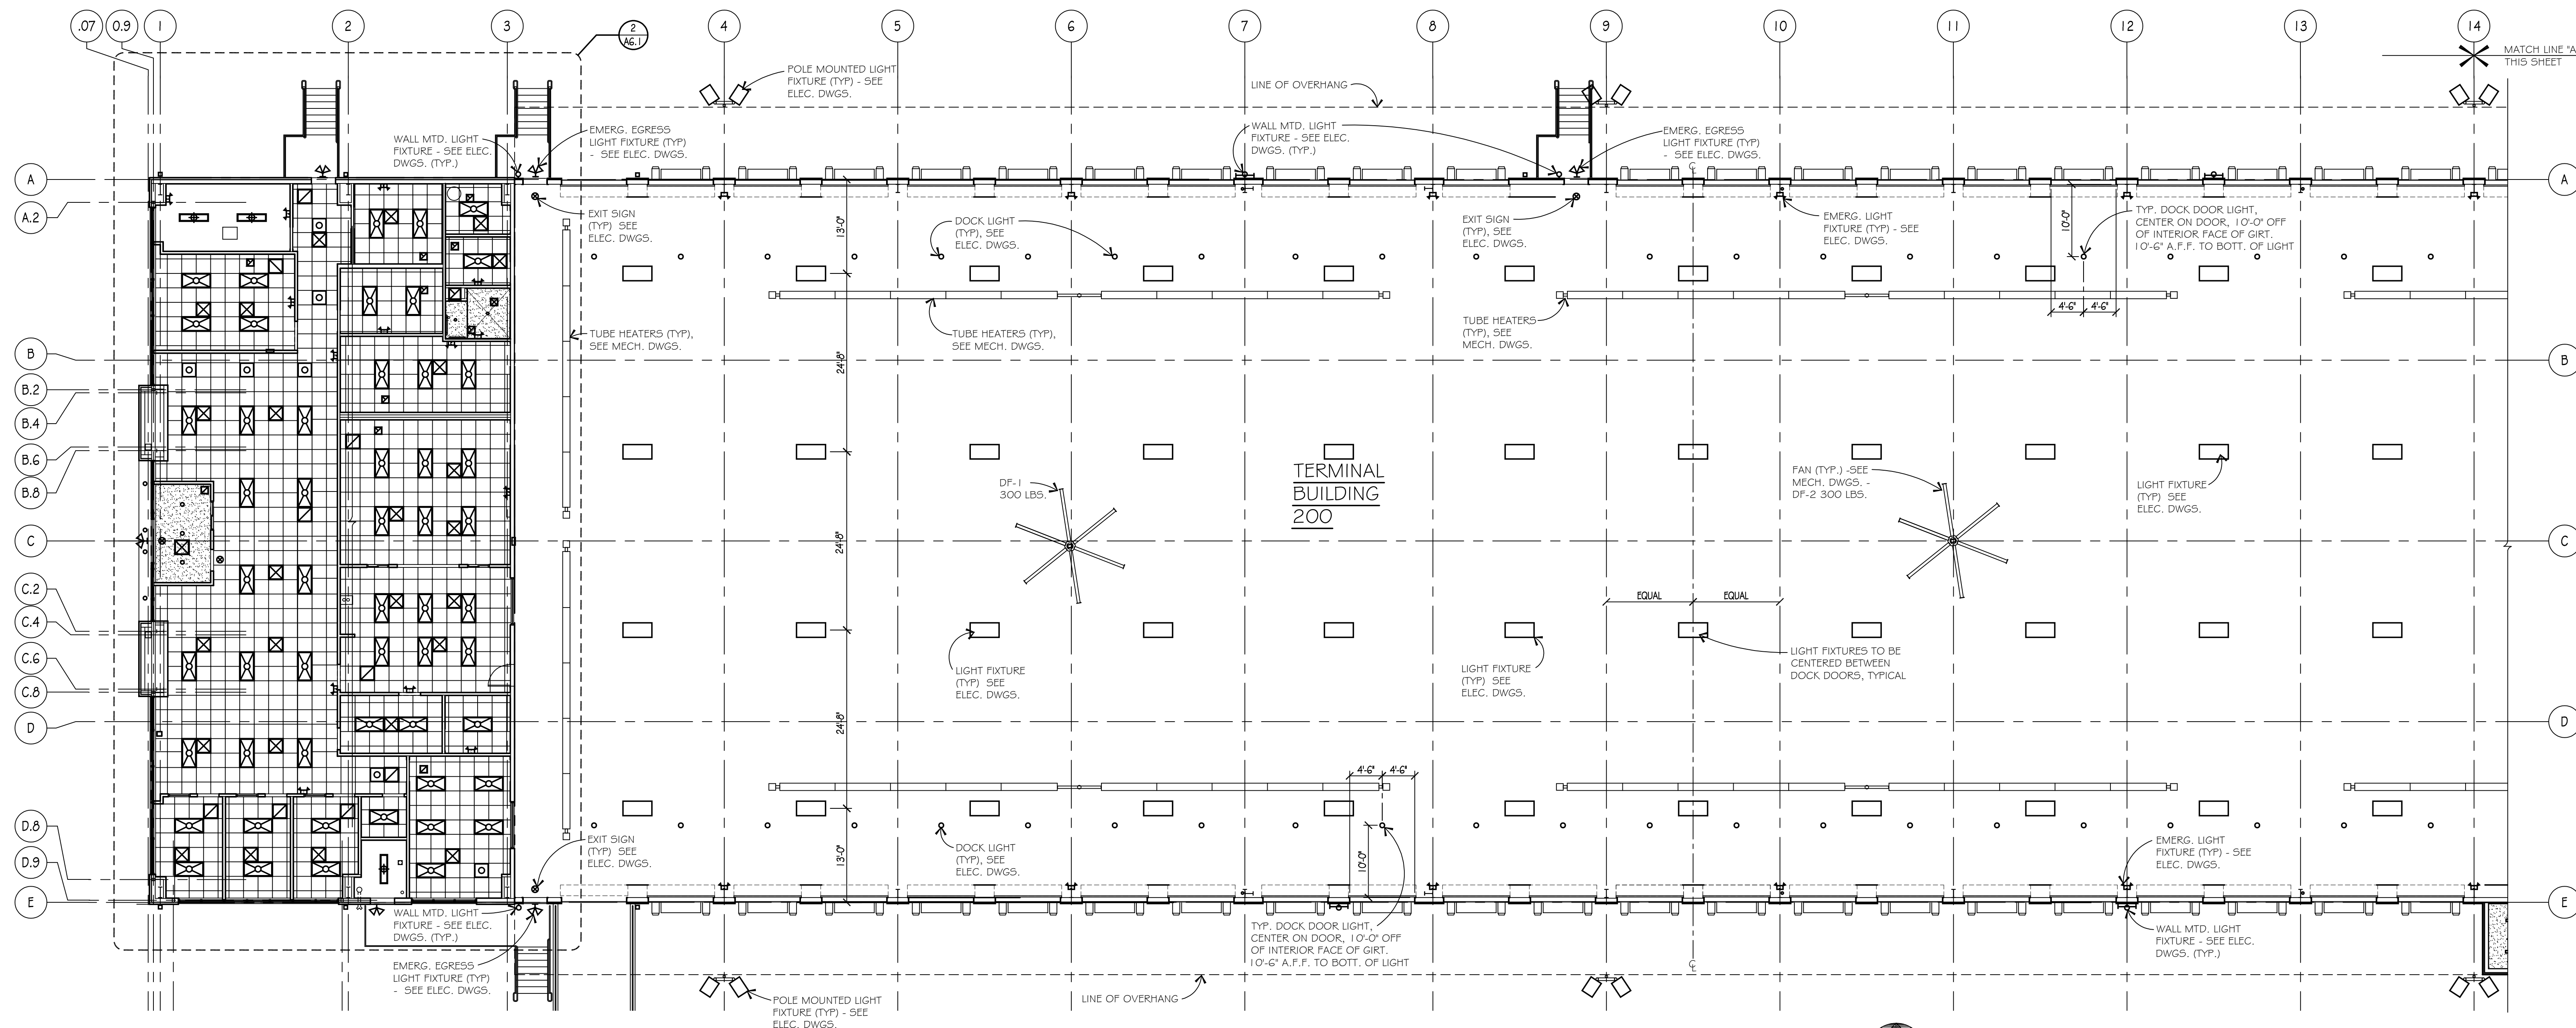


TERMINAL BUILDING #200 PARTIAL REFLECTED CEILING PLAN  
SCALE: 3/32" = 1'-0"

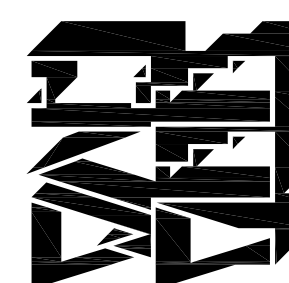

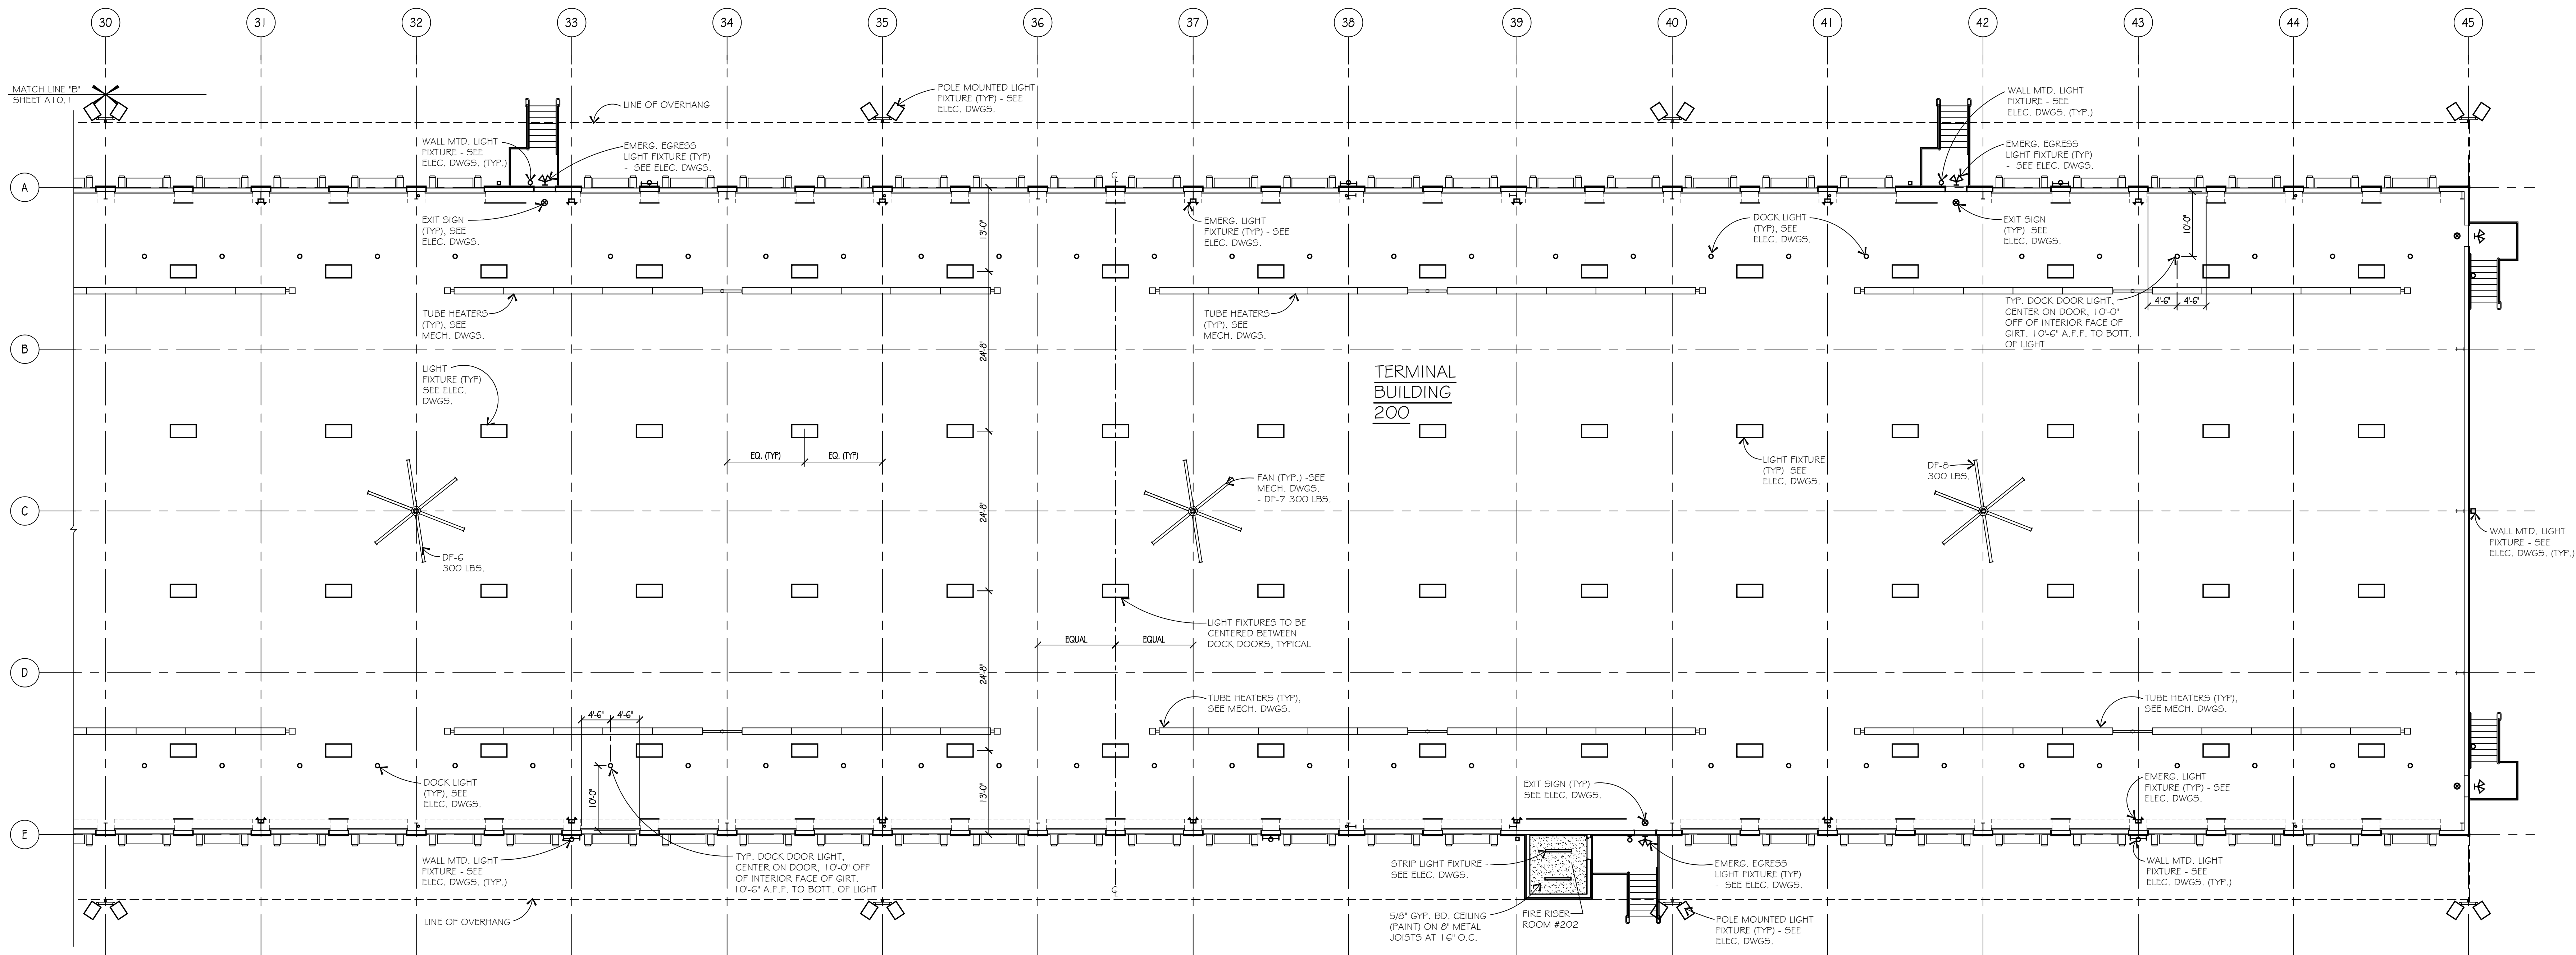


TERMINAL BUILDING #200 PARTIAL REFLECTED CEILING PLAN



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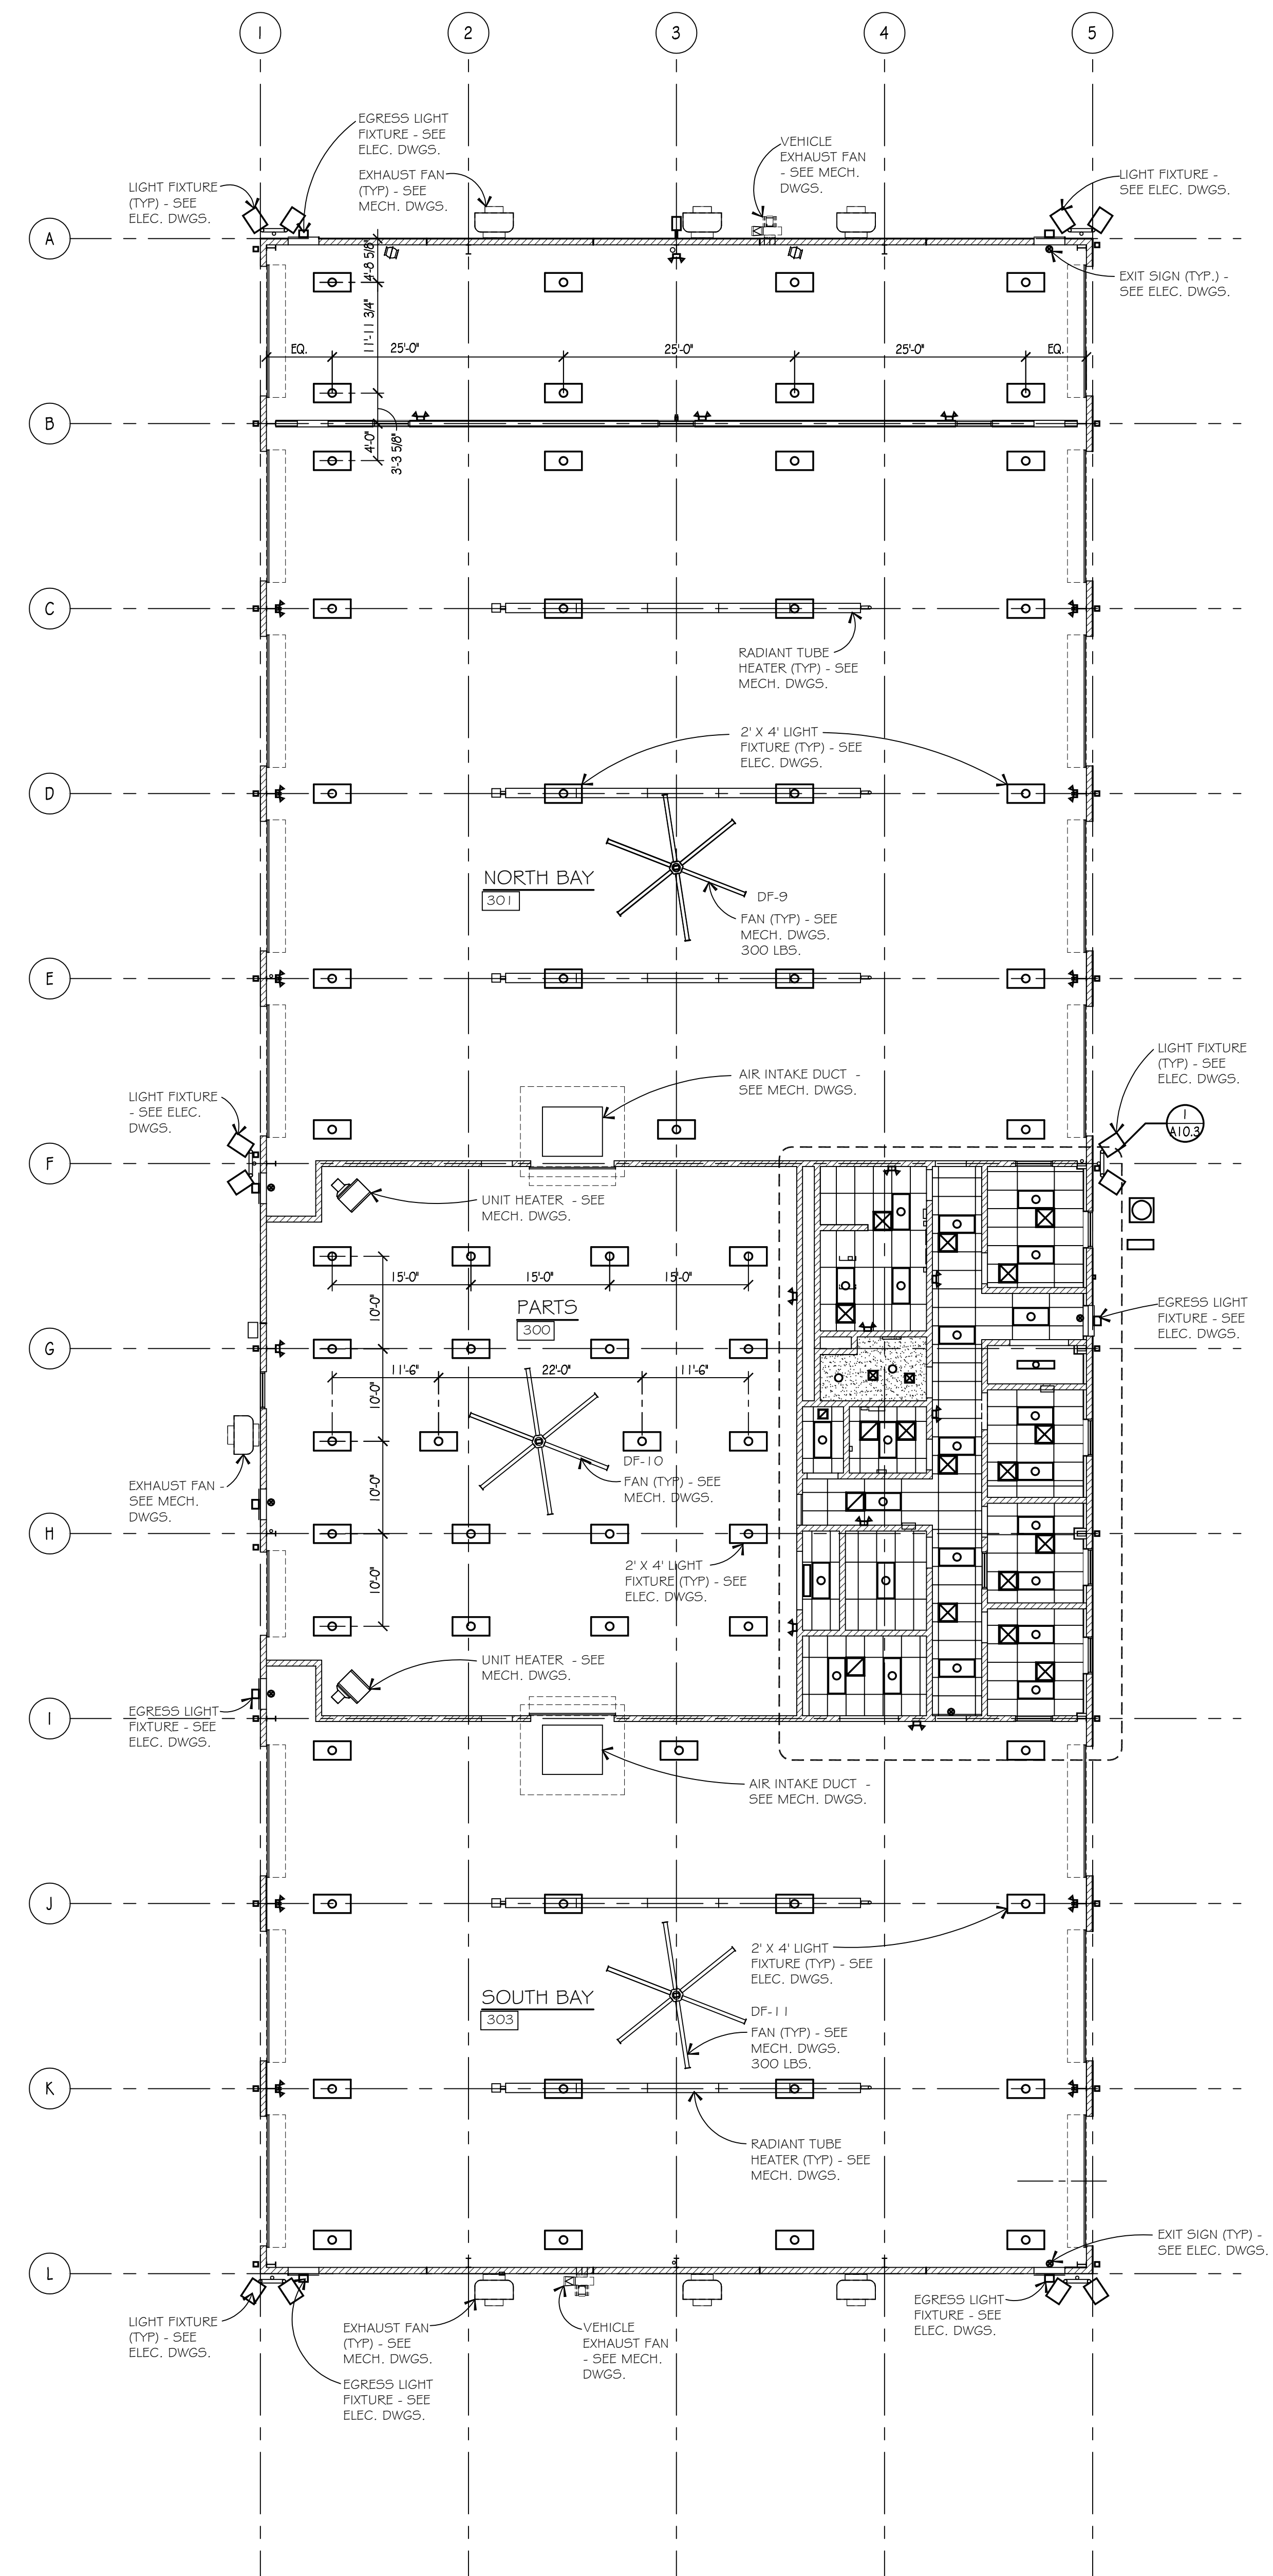


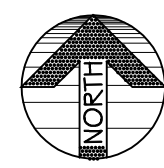

TRUCK WASH 400 REFLECTED CEILING  
SCALE: 1/8" = 1'-0"

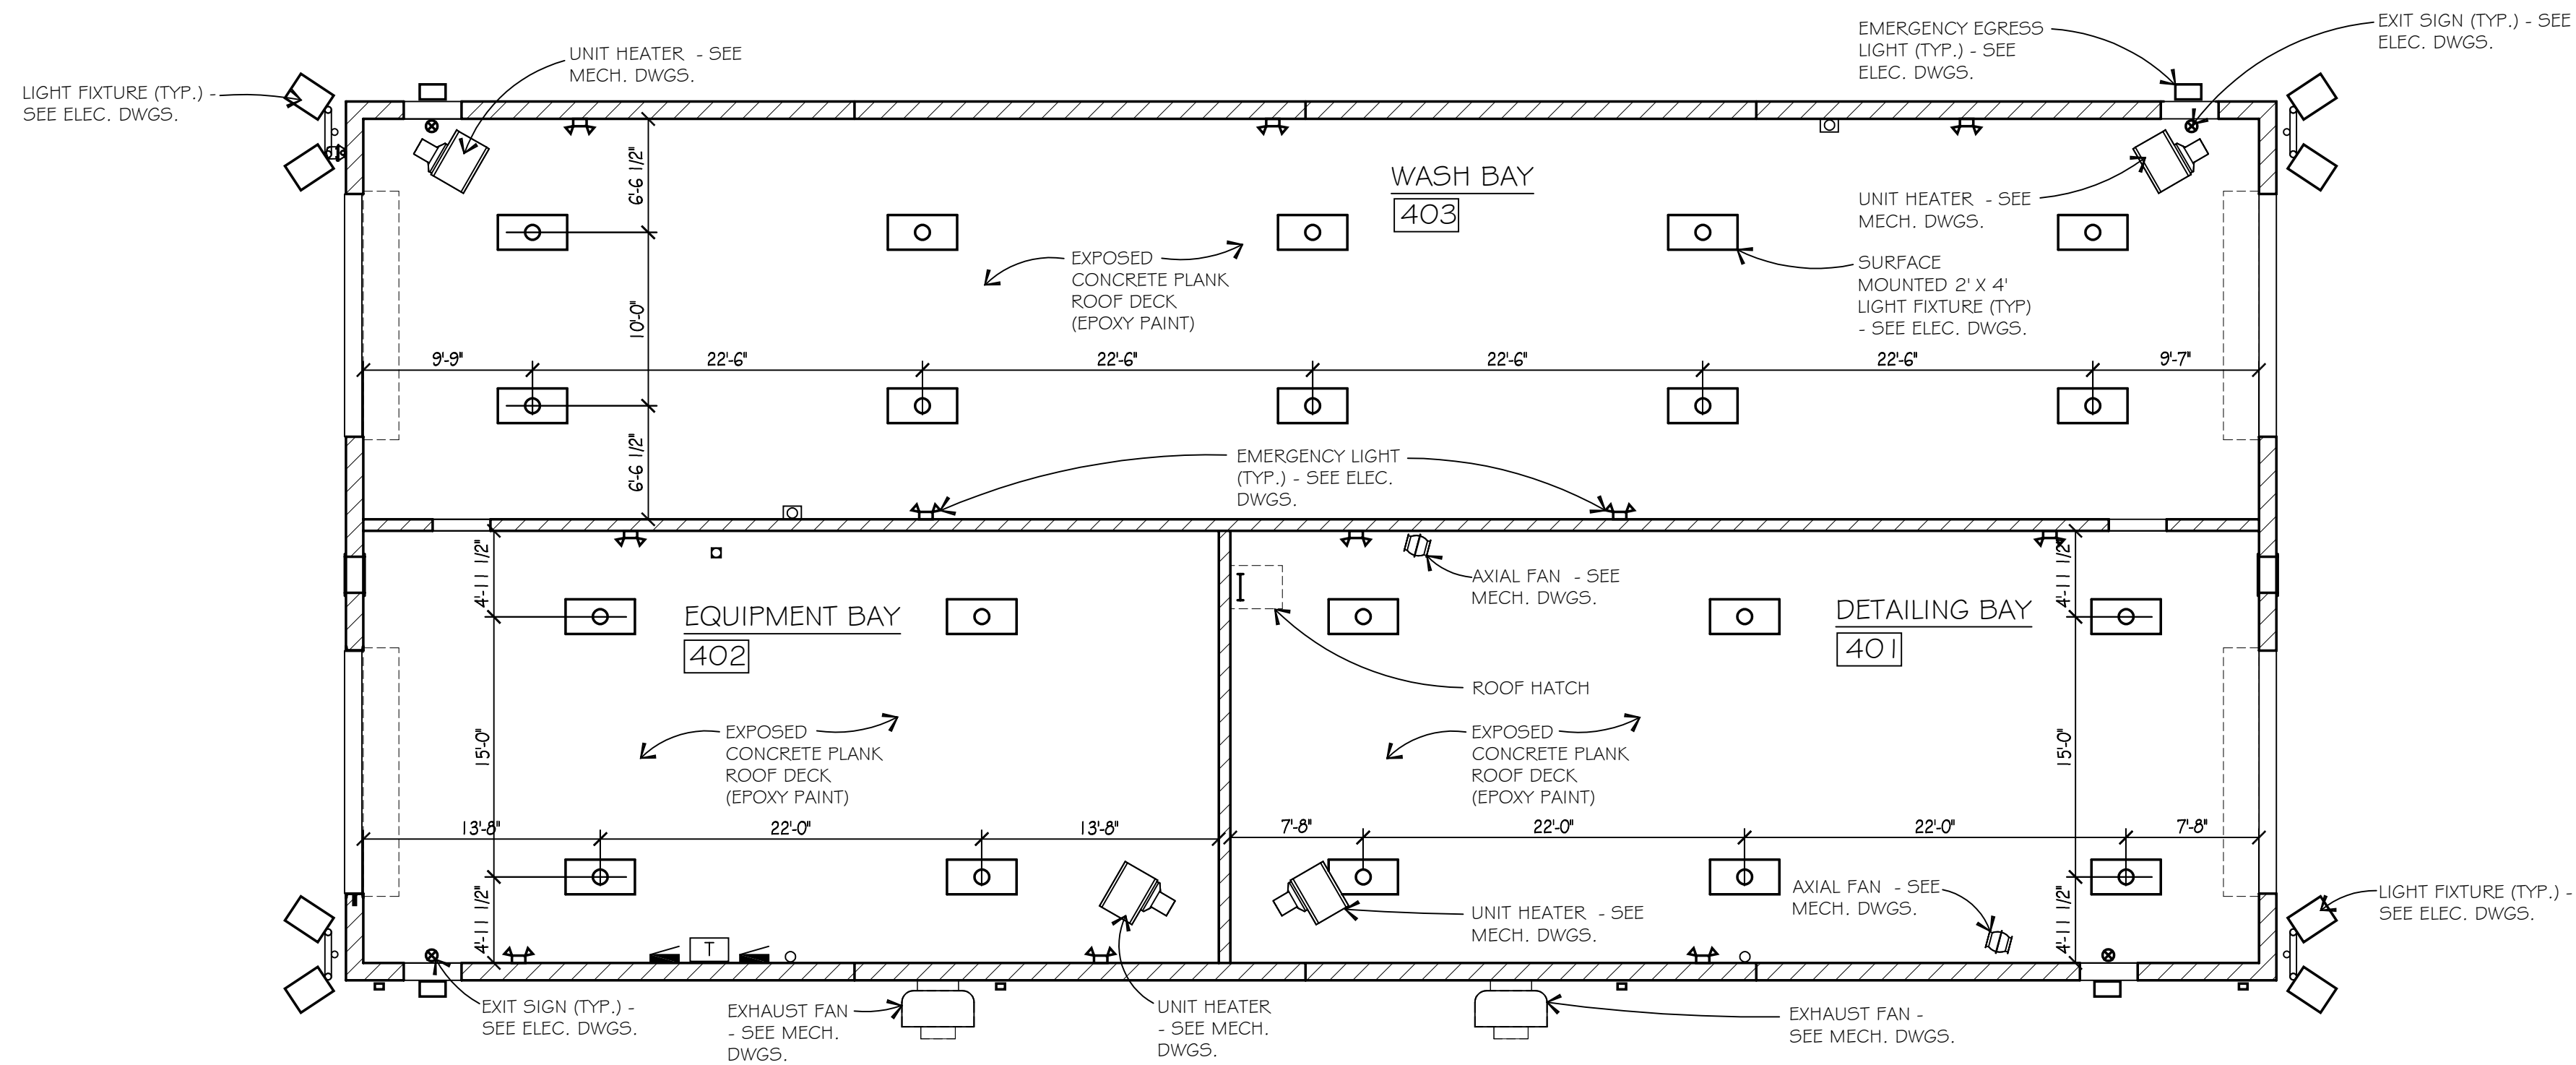

ENLARGED MAINTENANCE BUILDING OFFICE REFLECTED CEILING PLAN  
SCALE: 1/4" = 1'-0"

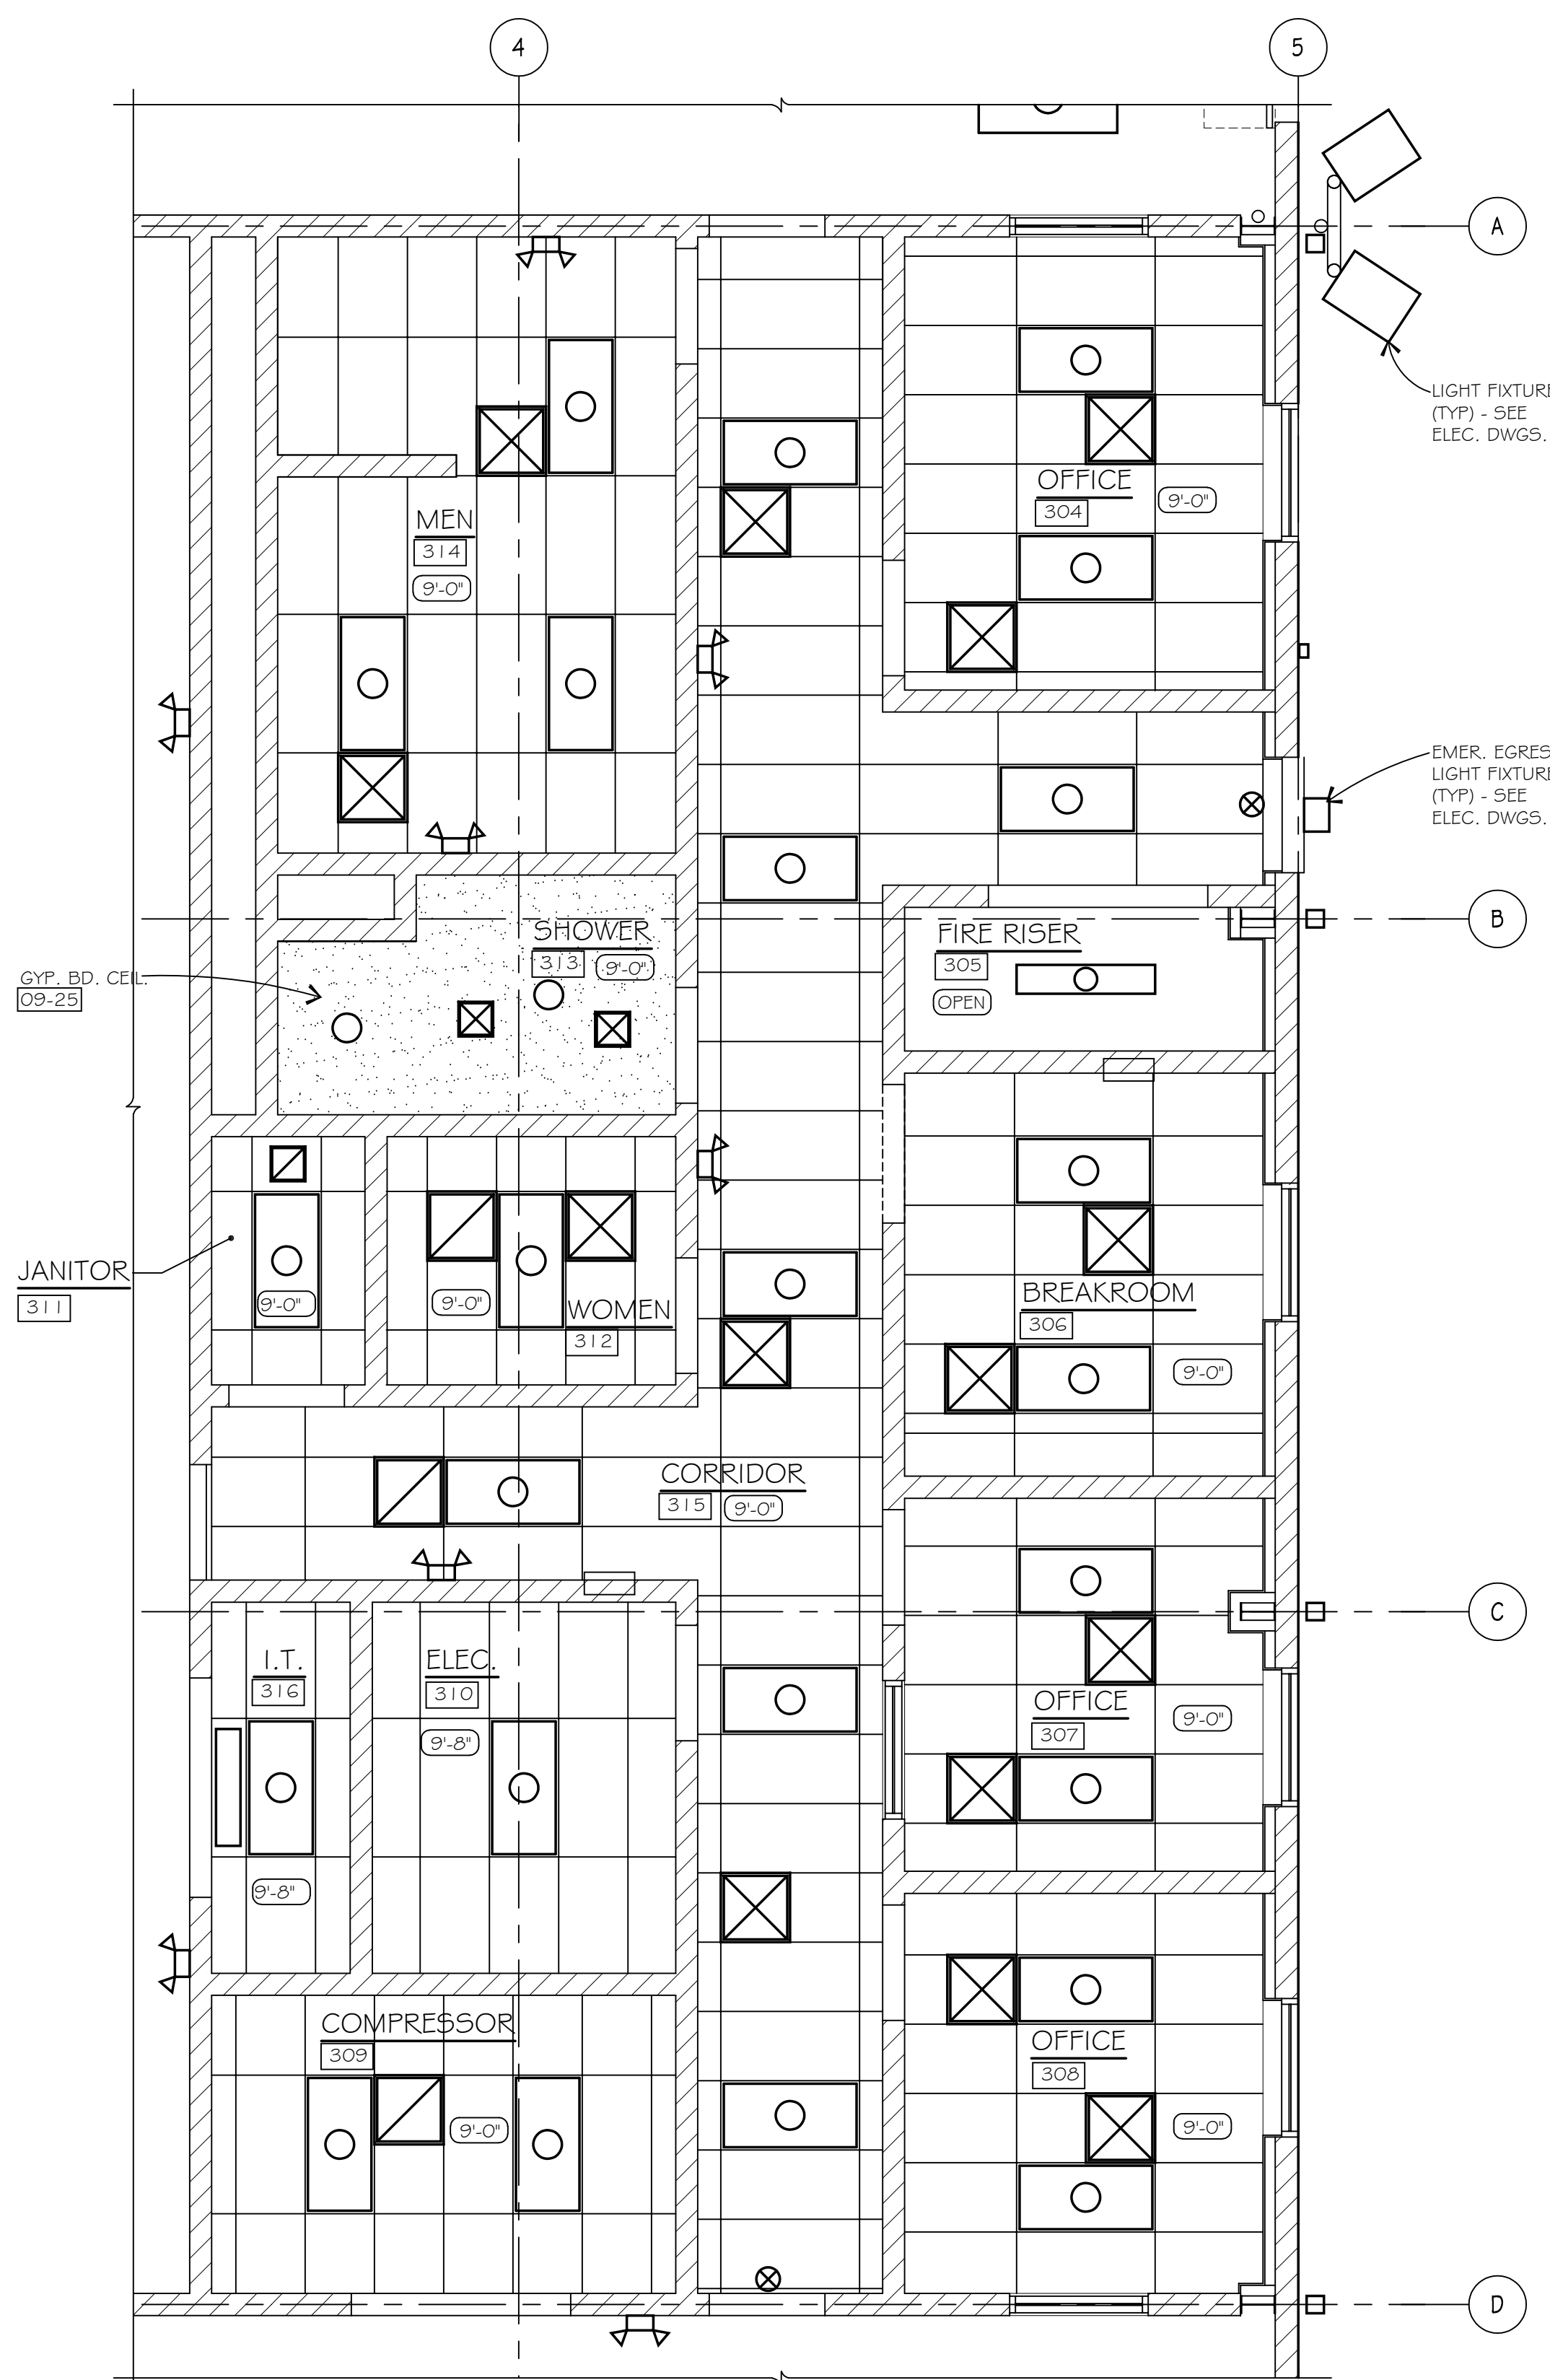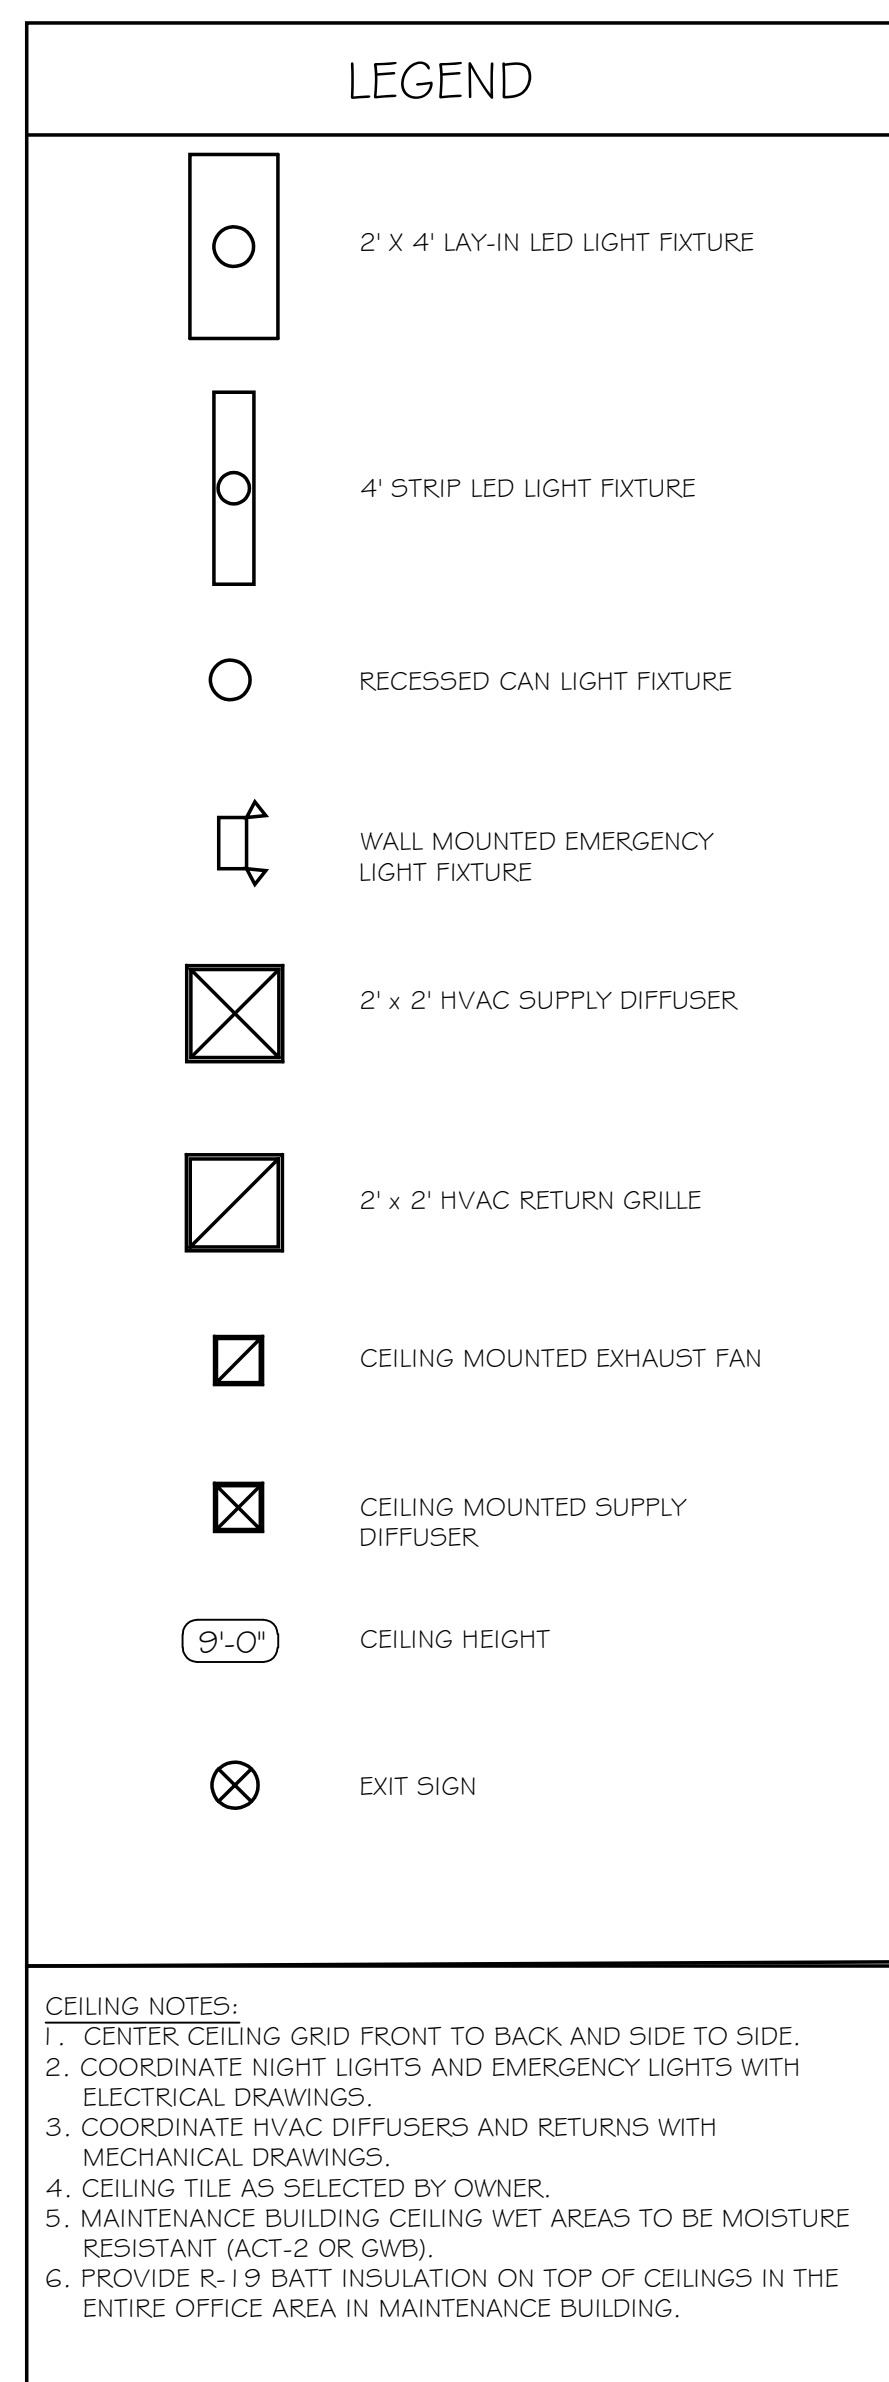

MAINTENANCE BUILDING 300 REFLECTED CEILING  
SCALE: 3/32" = 1'-0"