

**GENERAL NOTES:**

- A. EVERYTHING SHOWN IS NEW UNLESS OTHERWISE NOTED.
- B. FOR GENERAL DUCT CONSTRUCTION SEE DETAILS.
- C. ALL WORK SHALL BE IN ACCORDANCE WITH THE BEST QUALITY STANDARDS OF THE TRADE, AND SHALL CONFORM WITH ALL FEDERAL, STATE, AND LOCAL CODES AND STANDARDS.
- D. THE CONTRACTOR SHALL INCLUDE IN BID PROPOSAL ALL COSTS REQUIRED TO COMPLETELY AND PROPERLY INSTALL ALL WORK REQUIRED FOR THE PROJECT, AND SHALL EXAMINE THE SCOPE OF WORK OF OTHER TRADES PRIOR TO SUBMITTING A BID PROPOSAL.
- E. CONSTRUCTION DOCUMENTS SHALL BE FOLLOWED AS CLOSELY AS POSSIBLE, HOWEVER, SYSTEMS HAVE BEEN SHOWN DIAGRAMMATICALLY AND IN SOME CASES, ENLARGED FOR CLARITY. ANY OFFSETS, ADDITIONAL FITTINGS, AND/OR APPURTENANCES REQUIRED TO PROVIDE A COMPLETE AND COORDINATED SYSTEM SHALL BE BORNE BY THE CONTRACTOR.
- F. REFER TO ARCHITECTURAL REFLECTED CEILING PLANS FOR EXACT LOCATION OF CEILING MOUNTED MATERIALS INCLUDING ALL DIFFUSERS, GRILLES, AND REGISTERS. THE H.C. SHALL COORDINATE DUCTWORK INSTALLATIONS WITH OTHER TRADES. LIGHTING AND DUCTWORK DESIGNS INDICATED ON CONTRACT DRAWINGS WERE COORDINATED, HOWEVER CONFLICTS WITH DUCTWORK AND LIGHTS MAY ARISE DUE TO GRID INSTALLATION. H.C. SHALL BE RESPONSIBLE FOR ALL DUCTWORK MODIFICATIONS AND OFFSETS REQUIRED TO AVOID FIELD CONDITIONS.
- G. BALANCE DAMPERS SHALL BE LOCATED AT BRANCH CONNECTION TO THE MAIN.
- H. FLEXIBLE DUCTWORK IS LIMITED TO A MAXIMUM LENGTH OF 3 FEET, WITH NO DIPS, SAGS, OR TIGHT ELBOWS; AND ON SUPPLY DUCTWORK ONLY. FLEXIBLE DUCTWORK SHALL BE AN INSULATED, SEMI-RIGID AND LIGHT WEIGHT AIR DUCT, MANUFACTURED BY USING DEAD SOFT ALUMINUM STRIP WHICH IS SPIRALLY WOUND AND MECHANICALLY JOINED TOGETHER FORMING AN AIR TIGHT-LEAKPROOF TRIPLE LOCK SEAM. DUCT TO BE SELF-SUPPORTING AND CORROSIVE RESISTANT UL-181 CLASS I PRODUCT, WITH A POLYETHYLENE VAPOR BARRIER. FLEXIBLE DUCTWORK TO BE LIKE MASTERFIT UPC-018 (ACOUSTICAL) OR AN APPROVED EQUAL.
- I. LABEL ALL THERMOSTAT, SENSOR, ETC. AS TO WHAT THE DEVICE CONTROLS WITH AN ENLARGED, PLASTIC LABEL; MOUNTED UNDER OR ON THE DEVICE.
- J. PROVIDE NECK PLENUMS ON RETURN AND EXHAUST GRILLES AS REQUIRED. SEE DETAILS.
- K. PROVIDE TURNING VANES IN ALL SQUARE ELBOWS. SEE DETAILS.
- L. ALL EQUIPMENT INCLUDING BUT NOT LIMITED TO DUCTWORK, PIPING, UNIT HEATERS, ETC. SHALL BE HUNG FROM THE TOP CHORD OF THE STRUCTURAL STEEL.
- M. ALL EXTERIOR PENETRATIONS SHALL BE WEATHER AND WATER TIGHT.
- N. PROVIDE DUCT CLEANOUTS AS REQUIRED.
- O. REFRIGERANT PIPE SIZING AND CONFIGURATION BY UNIT MANUFACTURER.
- P. HVAC CONTRACTOR SHALL COORDINATE DUCT, DIFFUSERS, REGISTERS AND GRILLES WITH LIGHT FIXTURE LOCATIONS.
- Q. CONTRACTORS ARE TO REVIEW STRUCTURAL PLANS AND ACTUAL LAYOUT OF BEAMS, JOISTS, ETC. TO AVOID CONFLICT BETWEEN DUCT. ADJUST DUCT ROUTING TO ACCEPT STRUCTURAL CONDITIONS.
- R. ALL EXHAUST DISCHARGES AND GAS FLUES WHERE INDICATED SHALL BE LOCATED A MINIMUM OF 10'-0" AWAY FROM OUTSIDE AND COMBUSTION AIR INTAKES UNLESS LOCAL AND STATE CODES MANDATE ADDITIONAL DISTANCE.
- S. CONTRACTOR SHALL VERIFY ELECTRICAL CHARACTERISTICS OF ALL MECHANICAL EQUIPMENT WITH THE ELECTRICAL CONTRACTOR PRIOR TO PLACING EQUIPMENT ON ORDER.
- T. WHERE WALL TYPE LOUVERS ARE INDICATED, MECHANICAL CONTRACTOR SHALL SEAL WATER-TIGHT ALL AROUND LOUVER WITH SILICON CAULKING. CONTRACTOR SHALL COORDINATE PAINTING REQUIREMENTS FOR LOUVERS WITH GENERAL CONTRACTOR PRIOR TO SUBMITTING BID.

**DAIKIN**  
**Submital Data Sheet**  
 3-D Tor Round Flow Sensing Cassette  
 FXFG2RTVJU

**VRV 6-6**



**FEATURES**

- True 360° airflow distribution and three room sensors enables optimized control comfort and efficiency
- Quiet air delivery for peace of mind (Low Noise delivery and noise performance code)
- Individually controlled supply air louvers for comfortable air supply
- Improved efficiency with new DC fan motor and Auto Logic that adjusts fan speed based on indoor load
- Industry leading flexibility with 23 possible airflow patterns
- Ingress protection rating with an IP20/IP24
- Standard Limited Warranty: 10 year warranty on compressor and all parts

**BENEFITS**

- Compact design to allow for installation in small ceiling voids
- Very low sound levels increases flexibility regarding location of the unit
- Increased indoor air quality with high efficiency filter and a ventilation mode (optional)
- Automatic emergency department hot back function to save energy

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 Submital Date: 9/26/2018 4:43:12 AM

**DAIKIN**  
**Submital Data Sheet**  
 3-D Tor Round Flow Sensing Cassette  
 FXFG2RTVJU

**Specifications**

Indoor Unit Model No.	FXFG2RTVJU	Indoor Unit Name	3-D Tor Round Flow Sensing Cassette
Type	Cassette	Rated Cooling Conditions	Indoor (T DBWB): 80 / 67 Ambient (T DBWB): 95 / 75
Rated Cooling Capacity (Btu/h)	36,000	Rated Heating Conditions	Indoor (T DBWB): 71 / 60 Ambient (T DBWB): 47 / 43
Rated Heating Capacity (Btu/h)	28,200	Rated Piping Lengths	
Cooling Input Power (kW)	6.180	Rated Height Separation (ft)	
Rated Heating Capacity (Btu/h)	42,000		
Heating Input Power (kW)	5.18		


**Accessories (Optional)**

Power Supply (V/Ph/Hz)	208-230 / 3Ø / 1	Airflow Rate (FM/HL) (CFM)	1,950/1871
Power Supply Connections	1 L, 1 L, 2 Shared	Mixture Removal (SdRV)	
Min. Cold Amps (MCA) (A)	1.0	Gas Pipe Connection (DIN)	3/8
Max. Overcurrent Protection (MOP) (A)	10	Liquid Pipe Connection (DIN)	3/8
Dimensions (HxWxD) (in)	19.916 x 30.118 x 20.512	Condensate Connection (DIN)	1/4
Net Weight (lb)	98	Sound Pressure (HL) (dBA)	30/32
Ext. Static Pressure (Pmax) (inHg)	1	Sound Power Level (dBA)	

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**Submital Data Sheet**  
 3-D Tor Round Flow Sensing Cassette  
 FXFG2RTVJU

**DIMENSIONAL DRAWING**

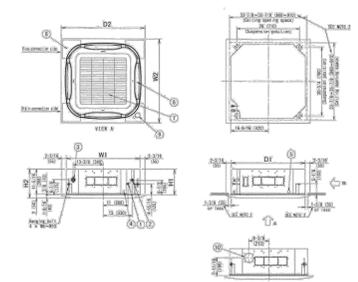

ITEM	REF. NO.	DESCRIPTION	QTY	UNIT	PRICE	TOTAL
1	1	3-D Tor Round Flow Sensing Cassette	1	EA	1,950.00	1,950.00
2	2	3-D Tor Round Flow Sensing Cassette	1	EA	1,871.00	1,871.00
3	3	3-D Tor Round Flow Sensing Cassette	1	EA	1,950.00	1,950.00
4	4	3-D Tor Round Flow Sensing Cassette	1	EA	1,871.00	1,871.00
5	5	3-D Tor Round Flow Sensing Cassette	1	EA	1,950.00	1,950.00
6	6	3-D Tor Round Flow Sensing Cassette	1	EA	1,871.00	1,871.00
7	7	3-D Tor Round Flow Sensing Cassette	1	EA	1,950.00	1,950.00
8	8	3-D Tor Round Flow Sensing Cassette	1	EA	1,871.00	1,871.00
9	9	3-D Tor Round Flow Sensing Cassette	1	EA	1,950.00	1,950.00
10	10	3-D Tor Round Flow Sensing Cassette	1	EA	1,871.00	1,871.00

NOTE: 1. Location of the receiver:  
 (1) 100% outdoor air supply system: 100% outdoor air supply system with 100% outdoor air supply.  
 (2) 100% outdoor air supply system: 100% outdoor air supply system with 100% outdoor air supply.  
 (3) 100% outdoor air supply system: 100% outdoor air supply system with 100% outdoor air supply.  
 (4) 100% outdoor air supply system: 100% outdoor air supply system with 100% outdoor air supply.  
 (5) 100% outdoor air supply system: 100% outdoor air supply system with 100% outdoor air supply.  
 (6) 100% outdoor air supply system: 100% outdoor air supply system with 100% outdoor air supply.  
 (7) 100% outdoor air supply system: 100% outdoor air supply system with 100% outdoor air supply.  
 (8) 100% outdoor air supply system: 100% outdoor air supply system with 100% outdoor air supply.  
 (9) 100% outdoor air supply system: 100% outdoor air supply system with 100% outdoor air supply.  
 (10) 100% outdoor air supply system: 100% outdoor air supply system with 100% outdoor air supply.

NOTE: For additional dimensional data and clearance information, refer to Engineering Data.

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DUCT INSULATION SCHEDULE			
SYSTEM	INTERIOR CONCEALED SUPPLY	EXTERIOR SUPPLY	EXTERIOR RETURN
FLUID TEMP. RANGE (°F)	40 & BELOW	100-300	40-75
INSULATION TYPE	MF OR FE	MF OR FE	MF OR FE
JACKET TYPE	FP	FP	FP
VAPOR BARRIER REQ'D	-	-	-
INSULATION THICKNESS (IN)	1-1/2"	2"	2"

**ABBREVIATIONS**

<b>INSULATION TYPES</b>	<b>JACKET TYPES</b>
FE FLEXIBLE ELASTOMERIC	FP FOIL & KRAFT PAPER
CG CELLULAR GLASS	PVC CELLULAR GLASS
MF MINERAL FIBER	AL ALUMINUM
PO POLYURETHANE	SS STAINLESS STEEL
CS CALCIUM SILICATE	
CCF CLOSED-CELL FOAM	

EQUIPMENT NOTES:
EF-1 AND EF-2 TO BE 100 CFM @ 0.35"ESP, LIKE COOK GC-144, 120V
BF-1, BOOSTER FAN TO BE LIKE FANTECH DEDPV705, 120V.
DF-1 TO BE LIKE TITUS TMS OR SIMILAR.

**DAE**  
**DESIGN-AIRE ENGINEERING, INC.**  
 Indianapolis, Indiana 46241  
 Fax: (317) 464-9593  
 Email: dae@dae-engineering.com  
 Mechanical, Electrical, and Energy Engineering


**NEW CLASSROOM RENOVATION**  
**NORTHWEST CONSOLIDATED SCHOOL**  
**DISTRICT OF SHELBY COUNTY**  
**FAIRLAND, IN 46126**

PROJECT: 23036  
 DATE: 04-20-2023  
 CONCEPTUAL DESIGN

MECHANICAL NOTES & SCHEDULES


DRAWING INDEX	
DRAWING No.	DRAWING TITLE
M001	MECHANICAL NOTES AND SCHEDULES
M002	MECHANICAL DETAILS
M101	MECHANICAL FLOORPLAN

**M001**

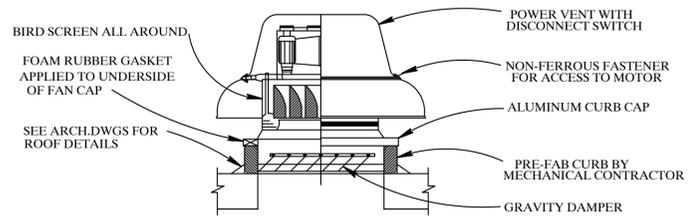


**ROOF MOUNTED EXHAUST FAN DETAIL**

NOT TO SCALE

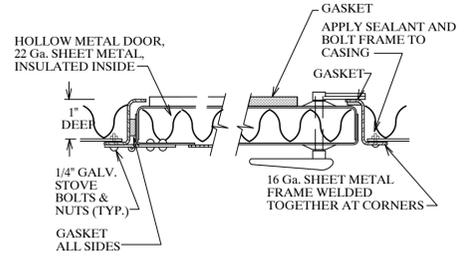


**DUCT ACCESS DOOR DETAIL**

NOT TO SCALE

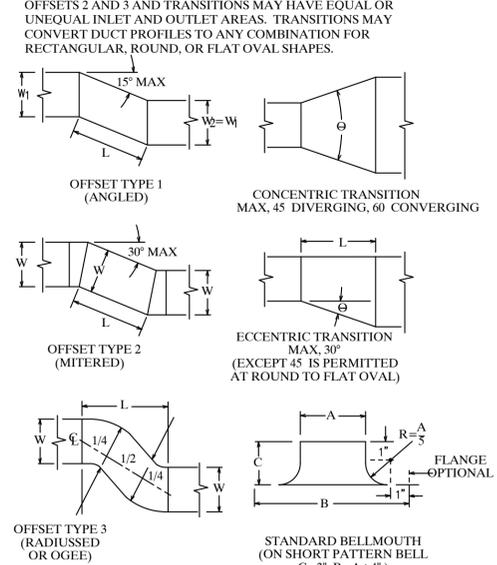


**DUCT OFFSETS AND TRANSITIONS**

NOT TO SCALE

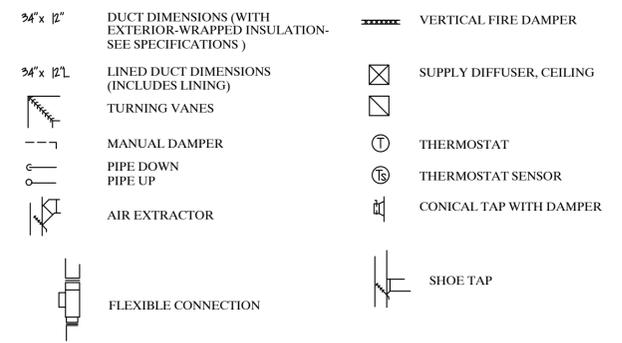


**HVAC - TYPICAL SYMBOLS**

NOT TO SCALE

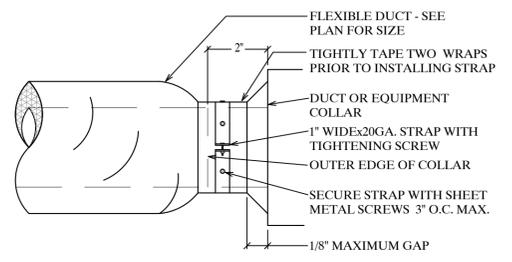


**FLEXIBLE DUCT CONNECTION**

NOT TO SCALE

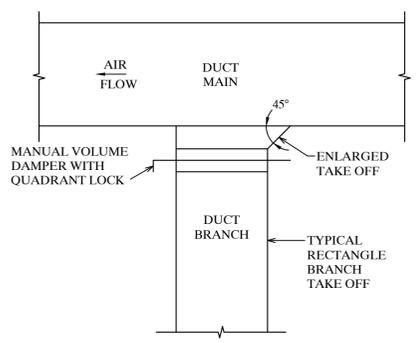


**TYPICAL RECTANGLE BRANCH SUPPLY AIR TAKE OFF DETAIL**

NOT TO SCALE

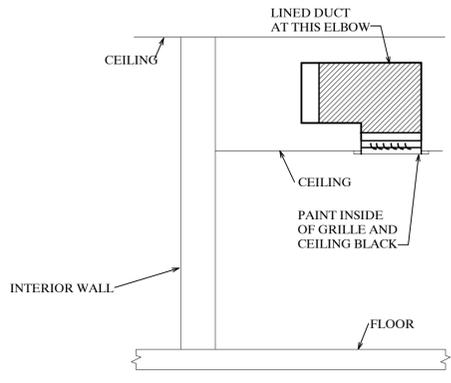


**TRANSFER GRILLE DETAIL**

NOT TO SCALE

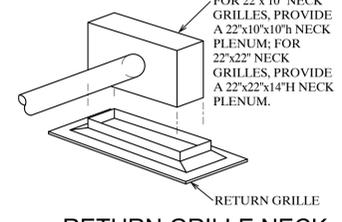


**RETURN GRILLE NECK PLENUM DETAIL**

NOT TO SCALE

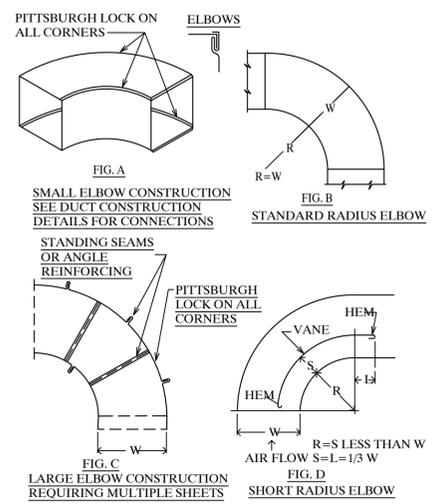

**ELBOW DETAILS**

NOT TO SCALE

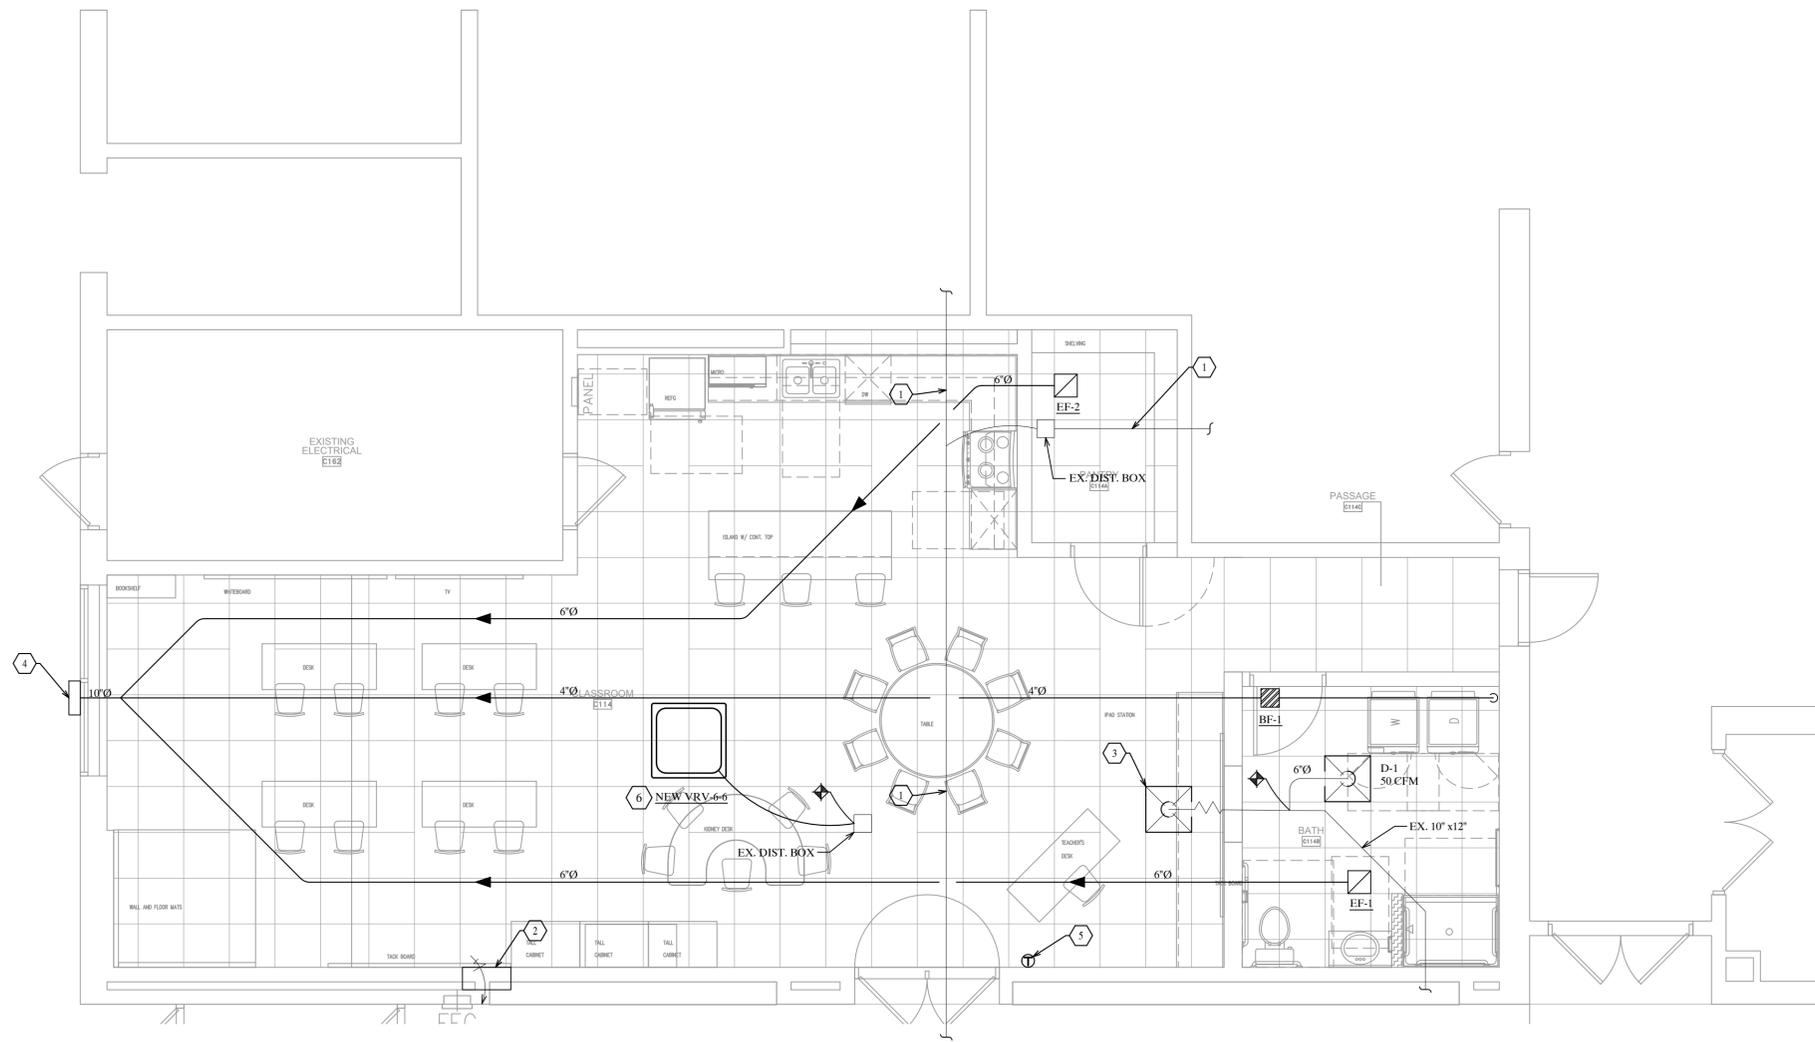

# PLAN NOTES:

1. EXISTING SETS OF REFRIGERANT PIPING
2. EXISTING ABOVE CEILING RETURN OPENING.
3. EXISTING DIFFUSER RELOCATED INTO NEW CEILING AS REQUIRED.
4. WALL EXHAUST HOOD.
5. RELOCATE EXISTING THERMOSTAT. RECONNECT TO NEW VRV-6-6 AS REQUIRED.
6. CONNECT CONDENSATE DRAIN TO NEAREST WASTE/VENT LINE AS REQUIRED.

 FLOOR PLAN - HVAC  
SCALE: 1/4" = 1'-0"

PROJECT: 23036
DATE: 04-20-2023
CONCEPTUAL DESIGN

HVAC PLAN

M101

NEW CLASSROOM RENOVATION  
NORTHWEST CONSOLIDATED SCHOOL  
DISTRICT OF SHELBY COUNTY  
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